
# **PROPOSED MIXED USE DEVELOPMENT COMPRISING SHOP TOP HOUSING 58 ANDERSON STREET, CHATSWOOD**

DRAWING NUMBER	DRAWING NAME	REVISIO
A001	COVER SHEET	05
A010	SURVEY PLAN - PREPARED BY EAST WEST SURVEYORS PTY LTD.	03
A010A	SURVEY PLAN -PREPARED BY DAW & WALTON CONSULTING SURVEYORS.	01
A011	SITE PLAN	04
A012	DEMOLITION PLAN	02
A013	SITE ANALYSIS	02
A100	BASEMENT 3 FLOOR PLAN	04
A101	BASEMENT 2 FLOOR PLAN	03
A102	BASEMENT 1 FLOOR PLAN	05
A103	GROUND FLOOR PLAN	05
A104	LEVEL 1 FLOOR PLAN	04
A105	LEVEL 2 FLOOR PLAN	04
A106	LEVEL 3 FLOOR PLAN	05
A107	LEVEL 4 FLOOR PLAN	05
A108	LEVEL 5 - 7 TYPICAL FLOOR PLANS	05
A109	LEVEL 8 - 12 TYPICAL FLOOR PLANS	05
A110	LEVEL 13 PENTHOUSE	05
A111	LEVEL 14 PENTHOUSE	03
A112	ROOF PLAN	03
A113	ADAPTABLE UNIT PLANS- SHEET 1	03
A114	ADAPTABLE UNIT PLANS- SHEET 2	03
A115	ADAPTABLE UNIT PLANS- SHEET 3	03
A201	ANDERSON STREET (EAST) ELEVATION	03
A202	WILSON STREET (SOUTH) ELEVATION	03
A203	RAILWAY (WEST) ELEVATION	03
A204	NORTH ELEVATION	03
A205	MATERIALS AND FINISHES	03
A211	SECTION 1	03
A212	SECTION 2	03
A213	SECTION 3	03
A214	SITE SECTION (SECTION 2)	03
A218	DETAIL SECTION	03
A219	DETAIL SECTION SHEET 2	01
A300	HEIGHT PLAN ANALYSIS	03
A301	SHADOW DIAGRAMS - 21 JUNE	02
A302	SHADOW DIAGRAMS - 21 DEC	02
A303	SOLAR ACCESS VIEWS (WINTER SOLSTICE)	03
A304	SOLAR ACCESS VIEWS (SUMMER SOLSTICE)	03
A305	CROSS VENTILATION DIAGRAM	03
A306	GFA DIAGRAMS	04
A307	SOLAR ACCESS DIAGRAM	03
A308	STORAGE DIAGRAMS	02
A401	NOTIFICATION PLAN	02
A402	NOTIFICATION ELEVATIONS -SHEET 1	02
A403	NOTIFICATION ELEVATIONS -SHEET 2	02
A404	DRIVEWAY PROFILE DETAIL PLAN	03
A405	DRIVEWAY ELEVATION AND CROSS SECTIONS	03



# **DEVELOPMENT SUMMARY**

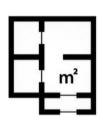

**TOTAL GFA** 

TOTAL GROSS FLOOR AREA (GFA)

TOTAL FLOOR SPACE RATIO (FSR)

GROSS FLOOR AREA (GFA)

FLOOR SPACE RATIO (FSR)

SITE AREA

RESIDENTIAL

# **CAR PARKING**

$\langle$	RESIDENTIAL PARKING SPACES
	RESIDENTIAL VISITOR PARKING SPACES
	COMMERCIAL PARKING SPACES

#### TWO LEVELS FULLY AUTOMATIC PARKING PROPOSED NUMBER



FIGURED DIMENSIONS SHALL BE USED IN

PREFERENCE TO THOSE SCALED OFF. DETAIL DRAWINGS TO LARGER SCALES TAKE

PRECEDENCE OVER SMALLER SCALE DRAWIN

THIS DRAWING WAS PREPARED FROM DRAWIN

AND SURVEY INFORMATION AVAILABLE AT THE TIME OF DRAFTING AND MAY VARY FROM ACTUA SITE MEASURED DIMENSIONS. VERIFY ALL

DIMENSIONS & LEVELS ON SITE PRIOR TO FABRICATION OF COMPONENTS OR COMMENCEMENT OF WORK ON SITE.



565m<sup>2</sup>


2,261m<sup>2</sup>

4:1

1696m<sup>2</sup>

3:1

# TOTAL:

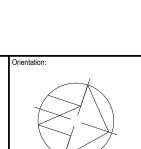

24/01/2025 ADDITIONAL INFORMATION SHOWN AD 14/10/2024 ISSUE FOR COUNCIL RFI EO 07/08/2024 ISSUED FOR COUNCIL RFI EO EO 27/03/2024 ISSUED FOR COUNCIL RFI 23/02/2023 ISSUED FOR DEVELOPMENT APPLICATION VE SSUE DATE DESCRIPTION **ISSUED BY** 


REV3, PREPARED BY EAST WEST SURVEY REFER TO SURVEY DRAWINGS FOR MORE

THIS DRAWING HAS BEEN PREPARED FROM INFORMATION MAD AVAILABLE FROM SURVEY DWGS. 'DETAIL SURVEY @ 58 ANDERSON STREET, CHATSWOOD NSW 2067' JOB NO. 3823-17,

YORS PTY LTD. DATED:	
EINFORMATION.	


## VIEW FROM ANDERSON STREET NORTH

PROJECT:

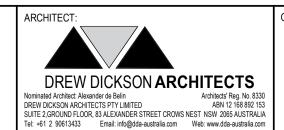


CLIENT:	
REZA VAKILI	
(THE PROPERTY OWNER)	

r	Drawing Scale @ A1:	Date: OCT 2022	Drawn by: KL
	Drawing Status: DEVELOPN	MENT APPLICATIC	N
	Project / Job No: 18014	Drawing No: A001	Revision:

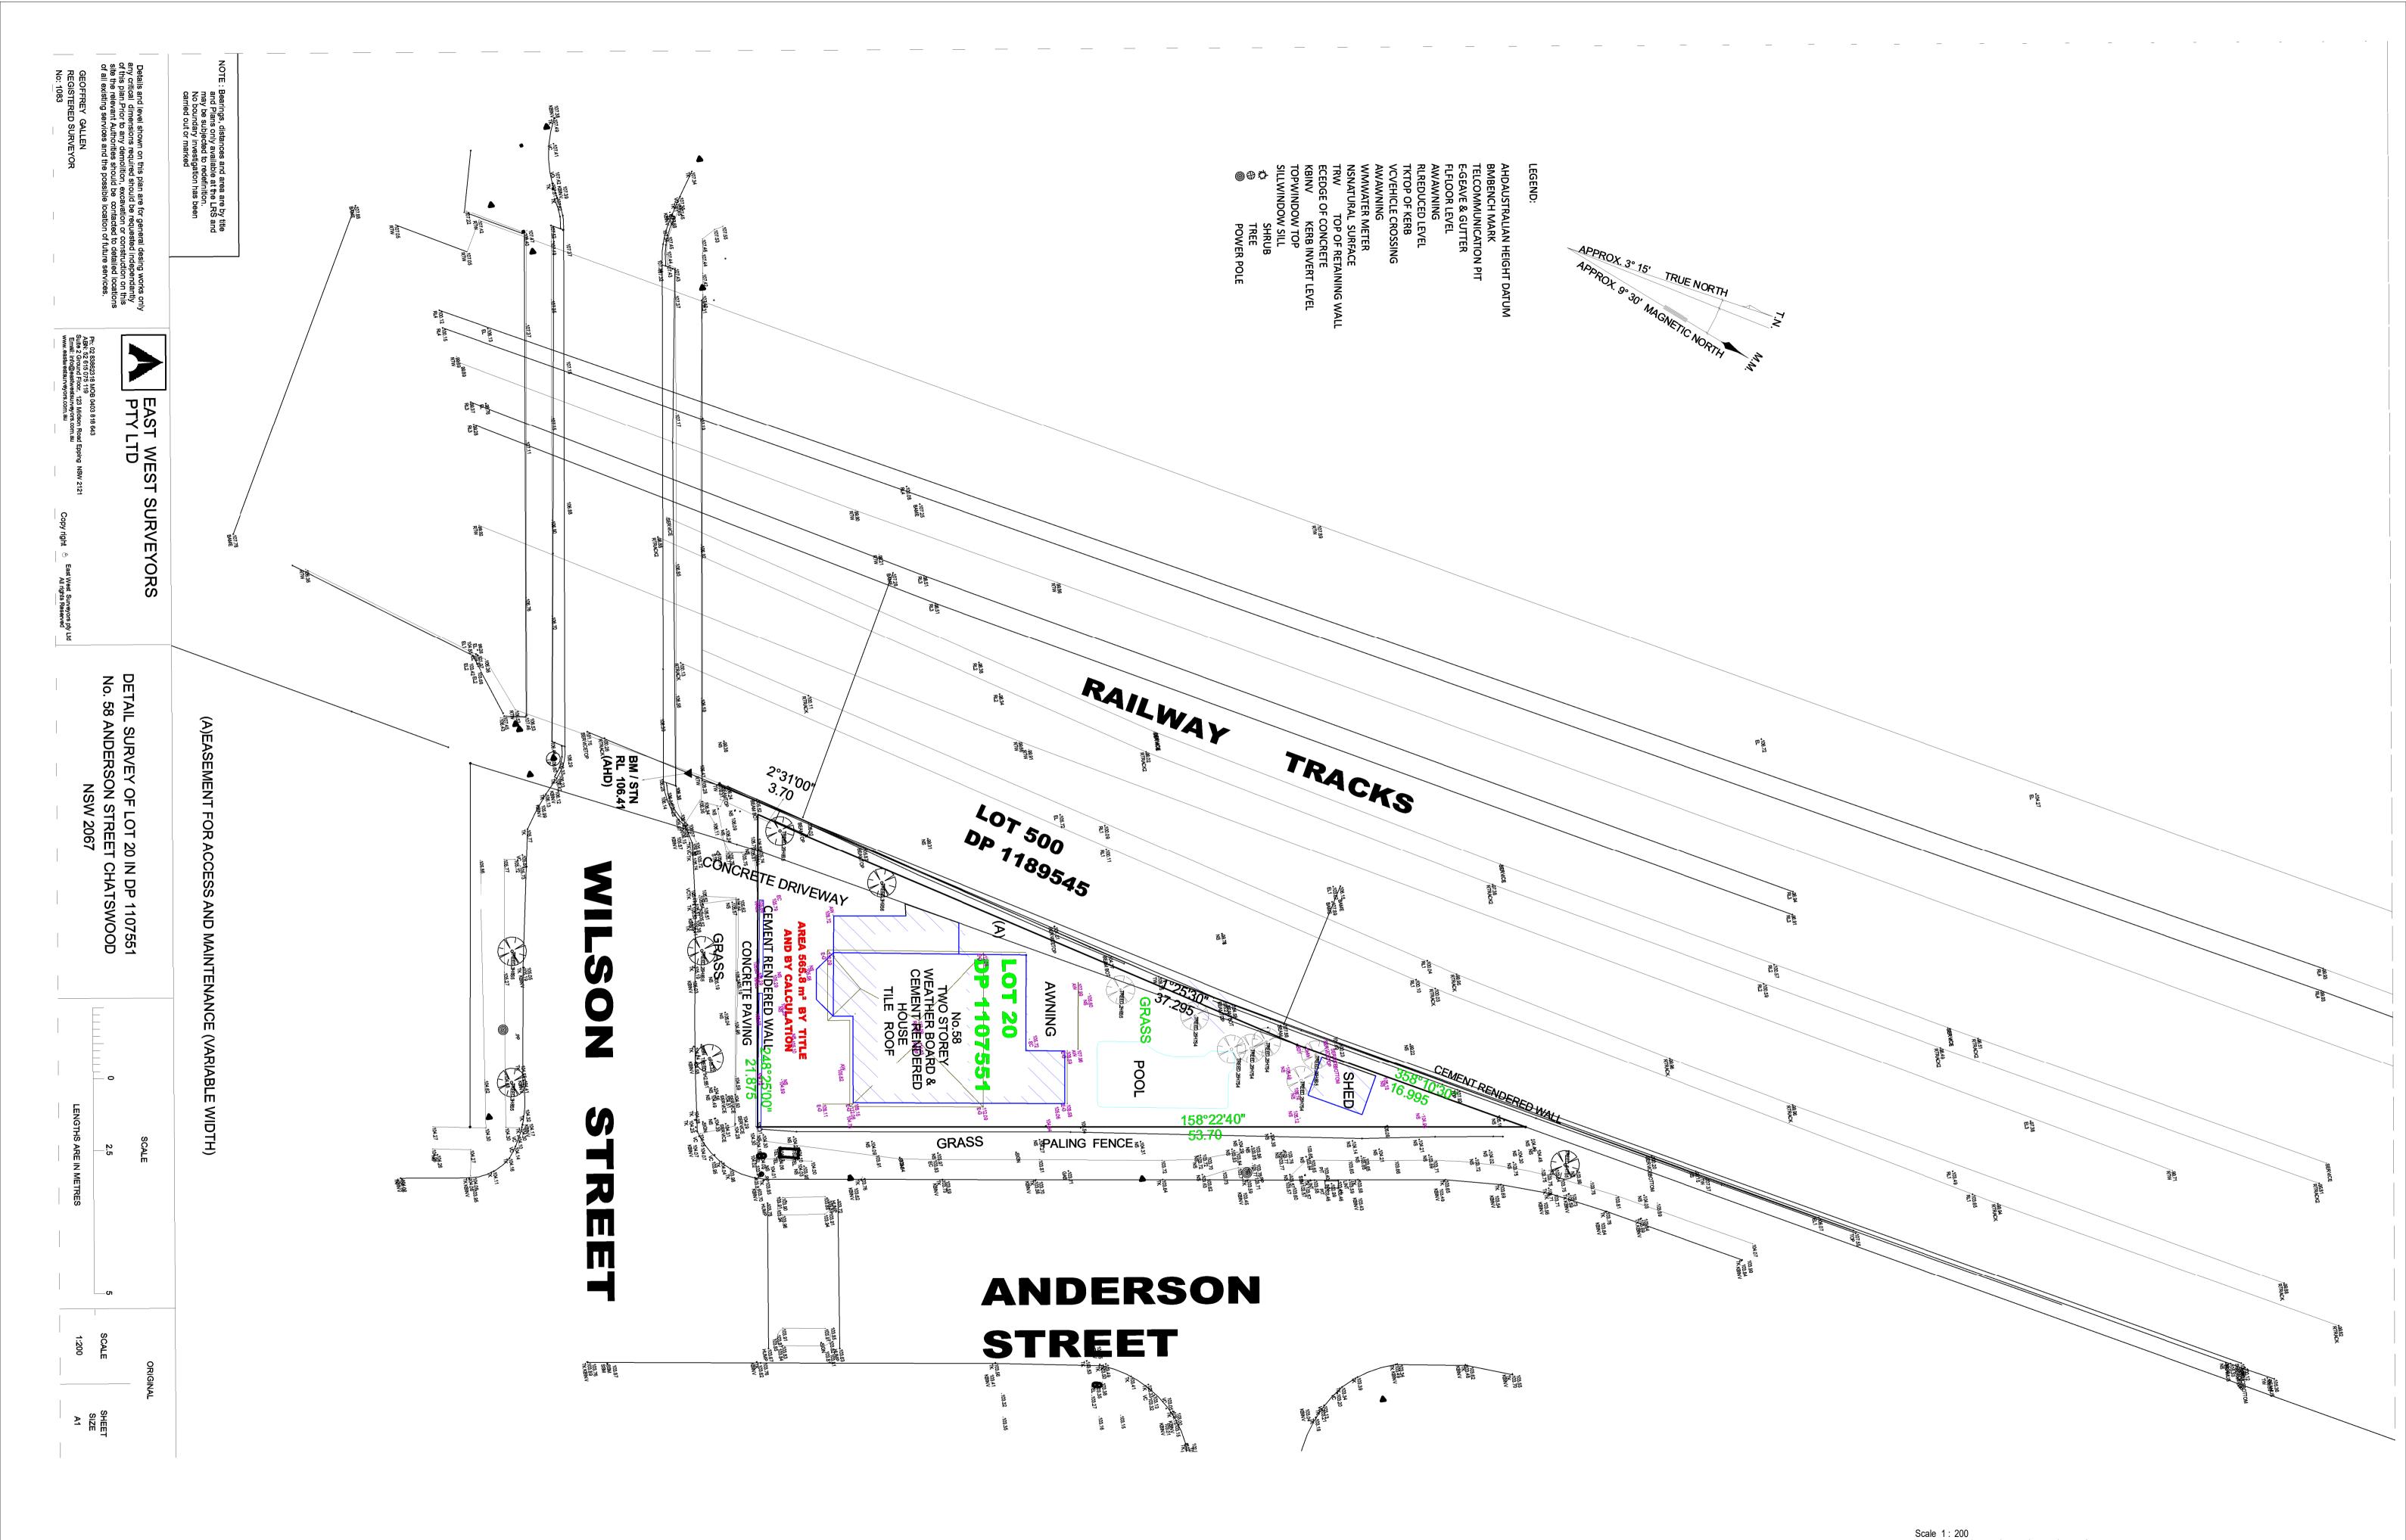

			6 4 8 12			
ARCHITECT:		PROJECT: PROPOSED SHOP TOP HOUSING	DRAWING SURVEY PLAN - PREPARED BY EAST WEST	Drawing Scale @ A1: 1:200		Drawn by: BY OTHERS
DREW DICKSON ARCHITECTS	(THE PROPERTY OWNER) <b>DEVELOPMENT</b>	SURVEYORS PTY LTD.	Drawing Status: DEVELOPMENT APPLICATION			
Nominated Architect: Alexander de Belin         Architects' Reg. No. 8330           DREW DICKSON ARCHITECTS PTV LIMITED         ABN 12 168 802 153           SUITE 2,GROUND FLOOR, 83 ALEXANDER STREET CROWS NEST NSW 2065 AUSTRALIA         Tel: +61 2 90613433           Email: info@dda-australia.com         Web: www.dda-australia.com		58 ANDERSON STREET CHATSWOOD, NSW, 2067		Project / Job No: 18014	Drawing No: A010	Revision: 03

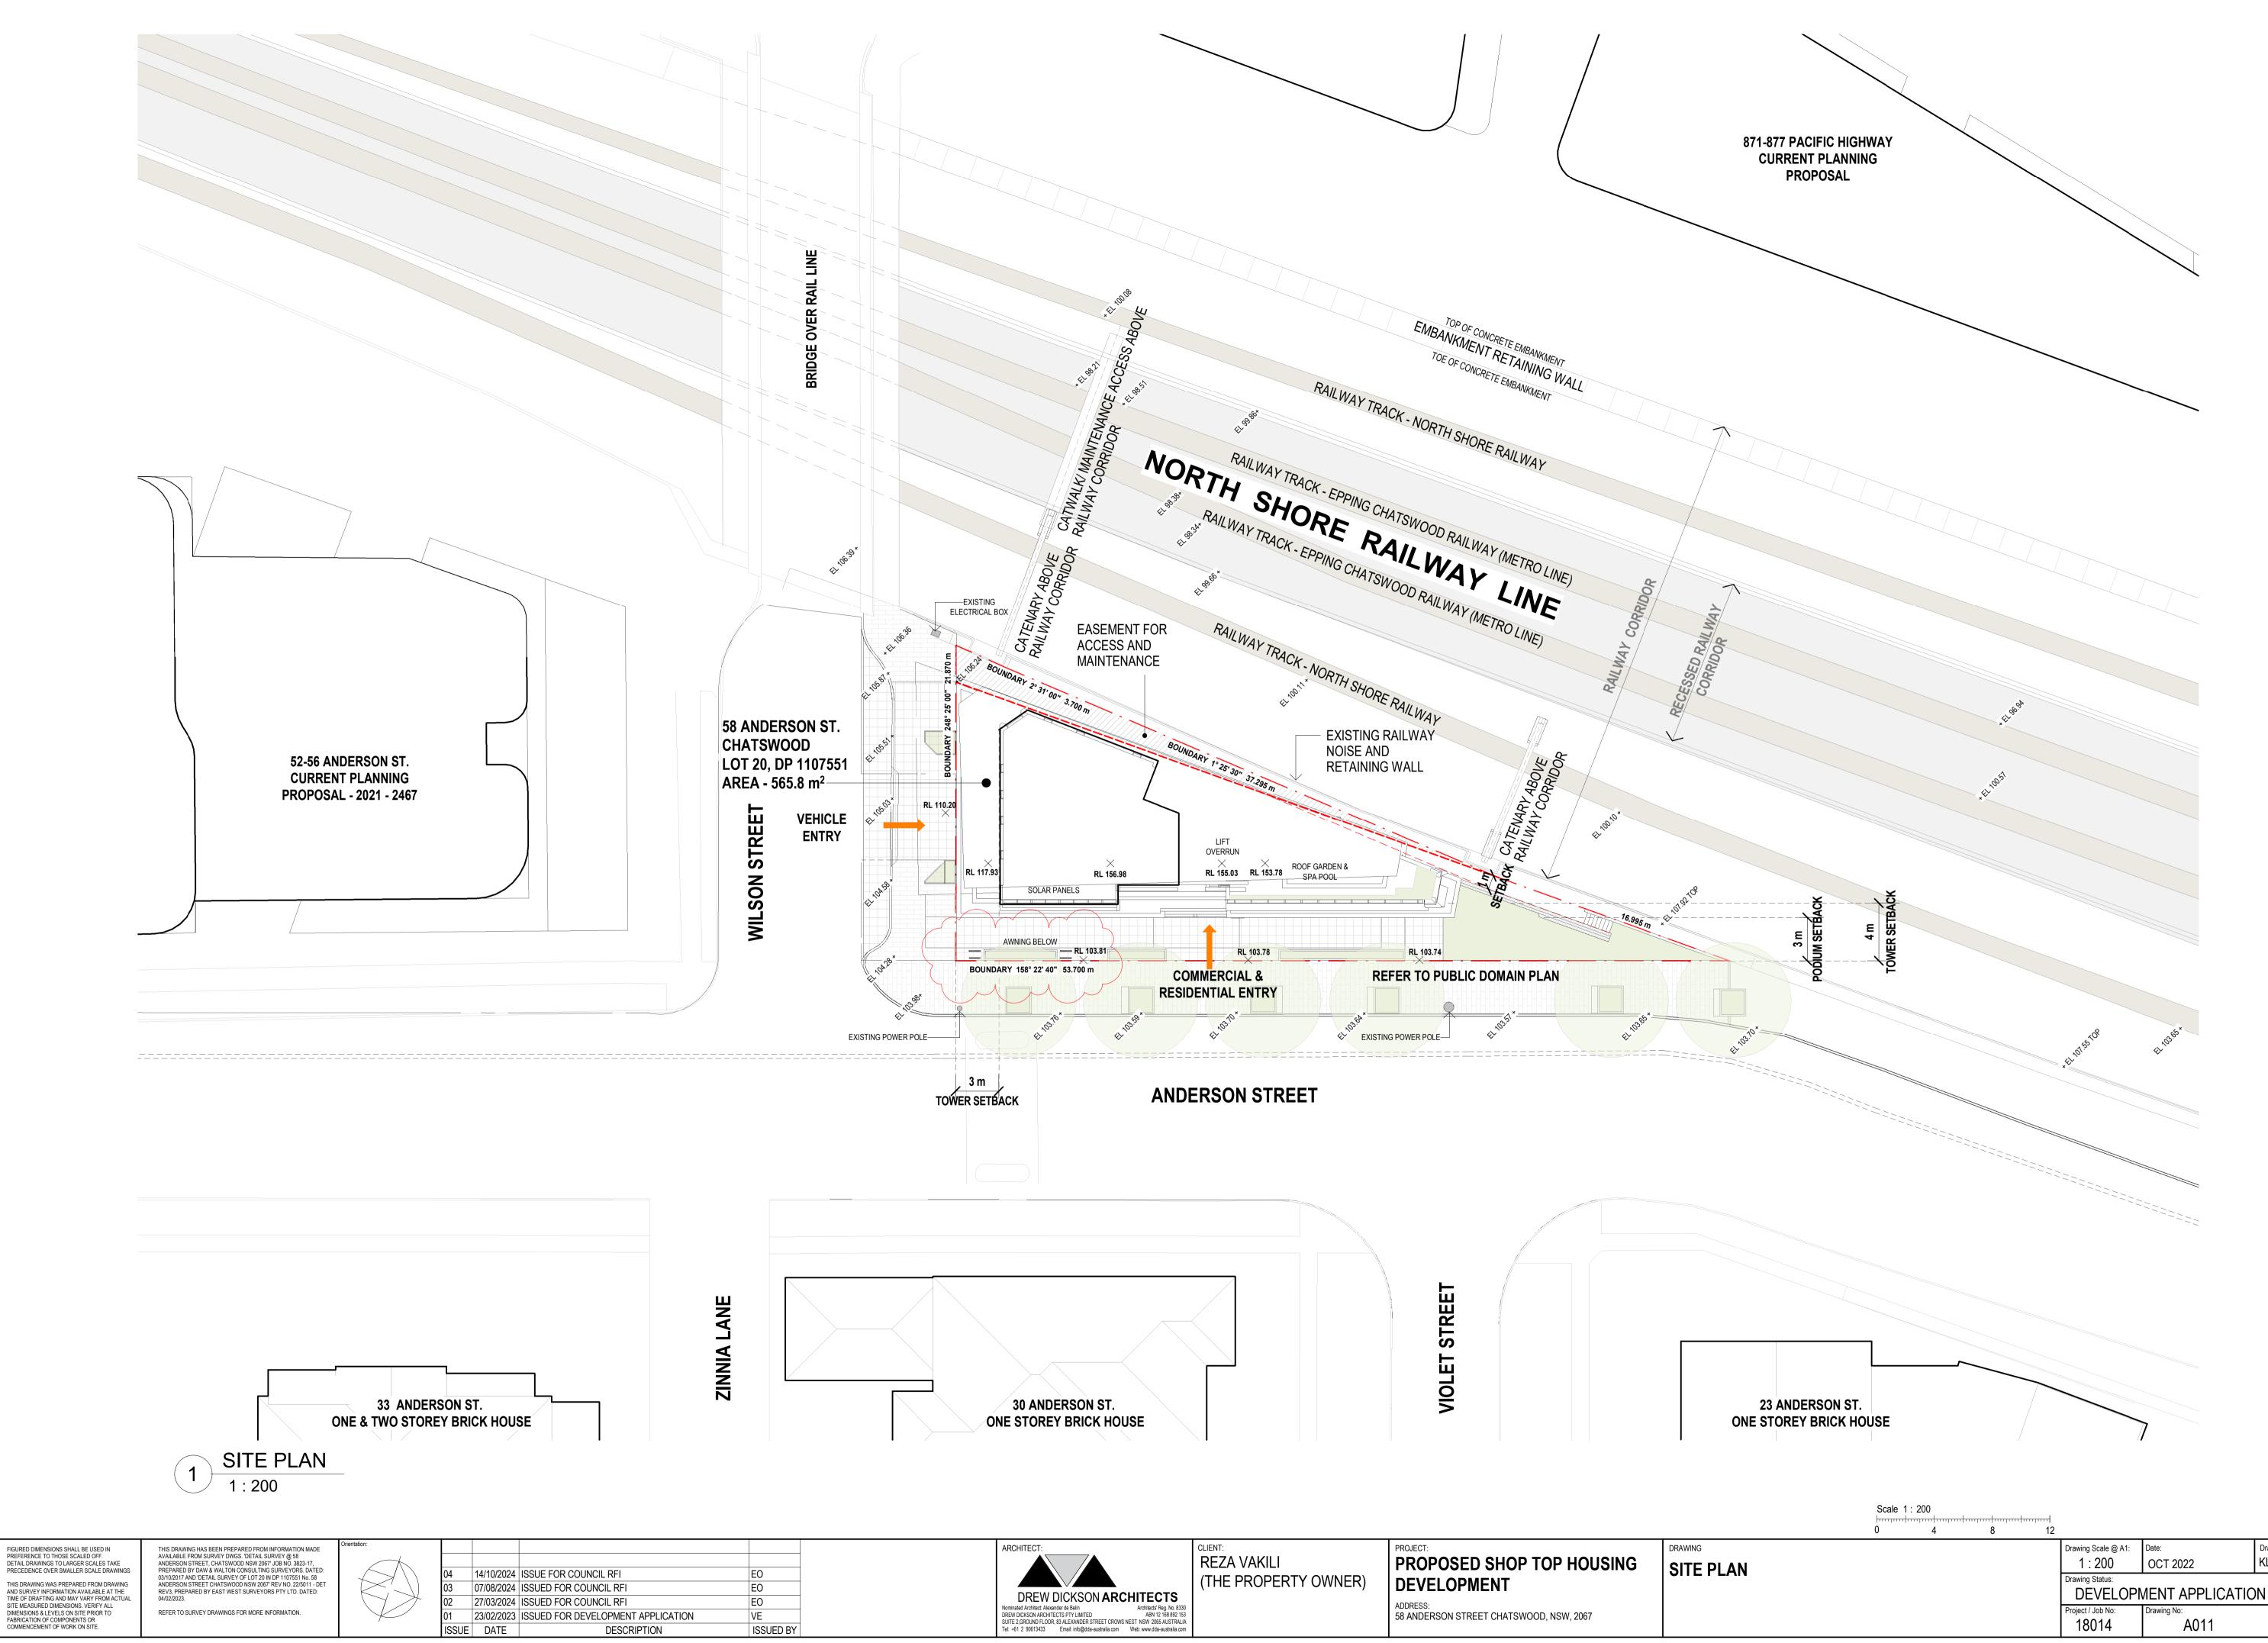


ARCHITECT: DREW DICKSON ARCHITECTS Nominated Architect: Alexander de Belin DREW DICKSON ARCHITECTS PTV LIMITED ARChitects' Reg. No. 8330 DREW DICKSON ARCHITECTS PTV LIMITED ABIN 12 f68 892 153 SUITE 2,GROUND FLOOR, 83 ALEXANDER STREET CROWS NEST NSW 2065 AUSTRALIA Tel: +61 2 90613433 Email: info@dda-australia.com Web: www.dda-australia.com	CLIENT: REZA VAKILI (THE PROPERTY OWNER)	PROJECT: <b>PROPOSED SHOP TOP HOUSING</b> <b>DEVELOPMENT</b> ADDRESS: 58 ANDERSON STREET CHATSWOOD, NSW, 2067	drawing SITE PLAN
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Drawn by:

Revision: 04

KL

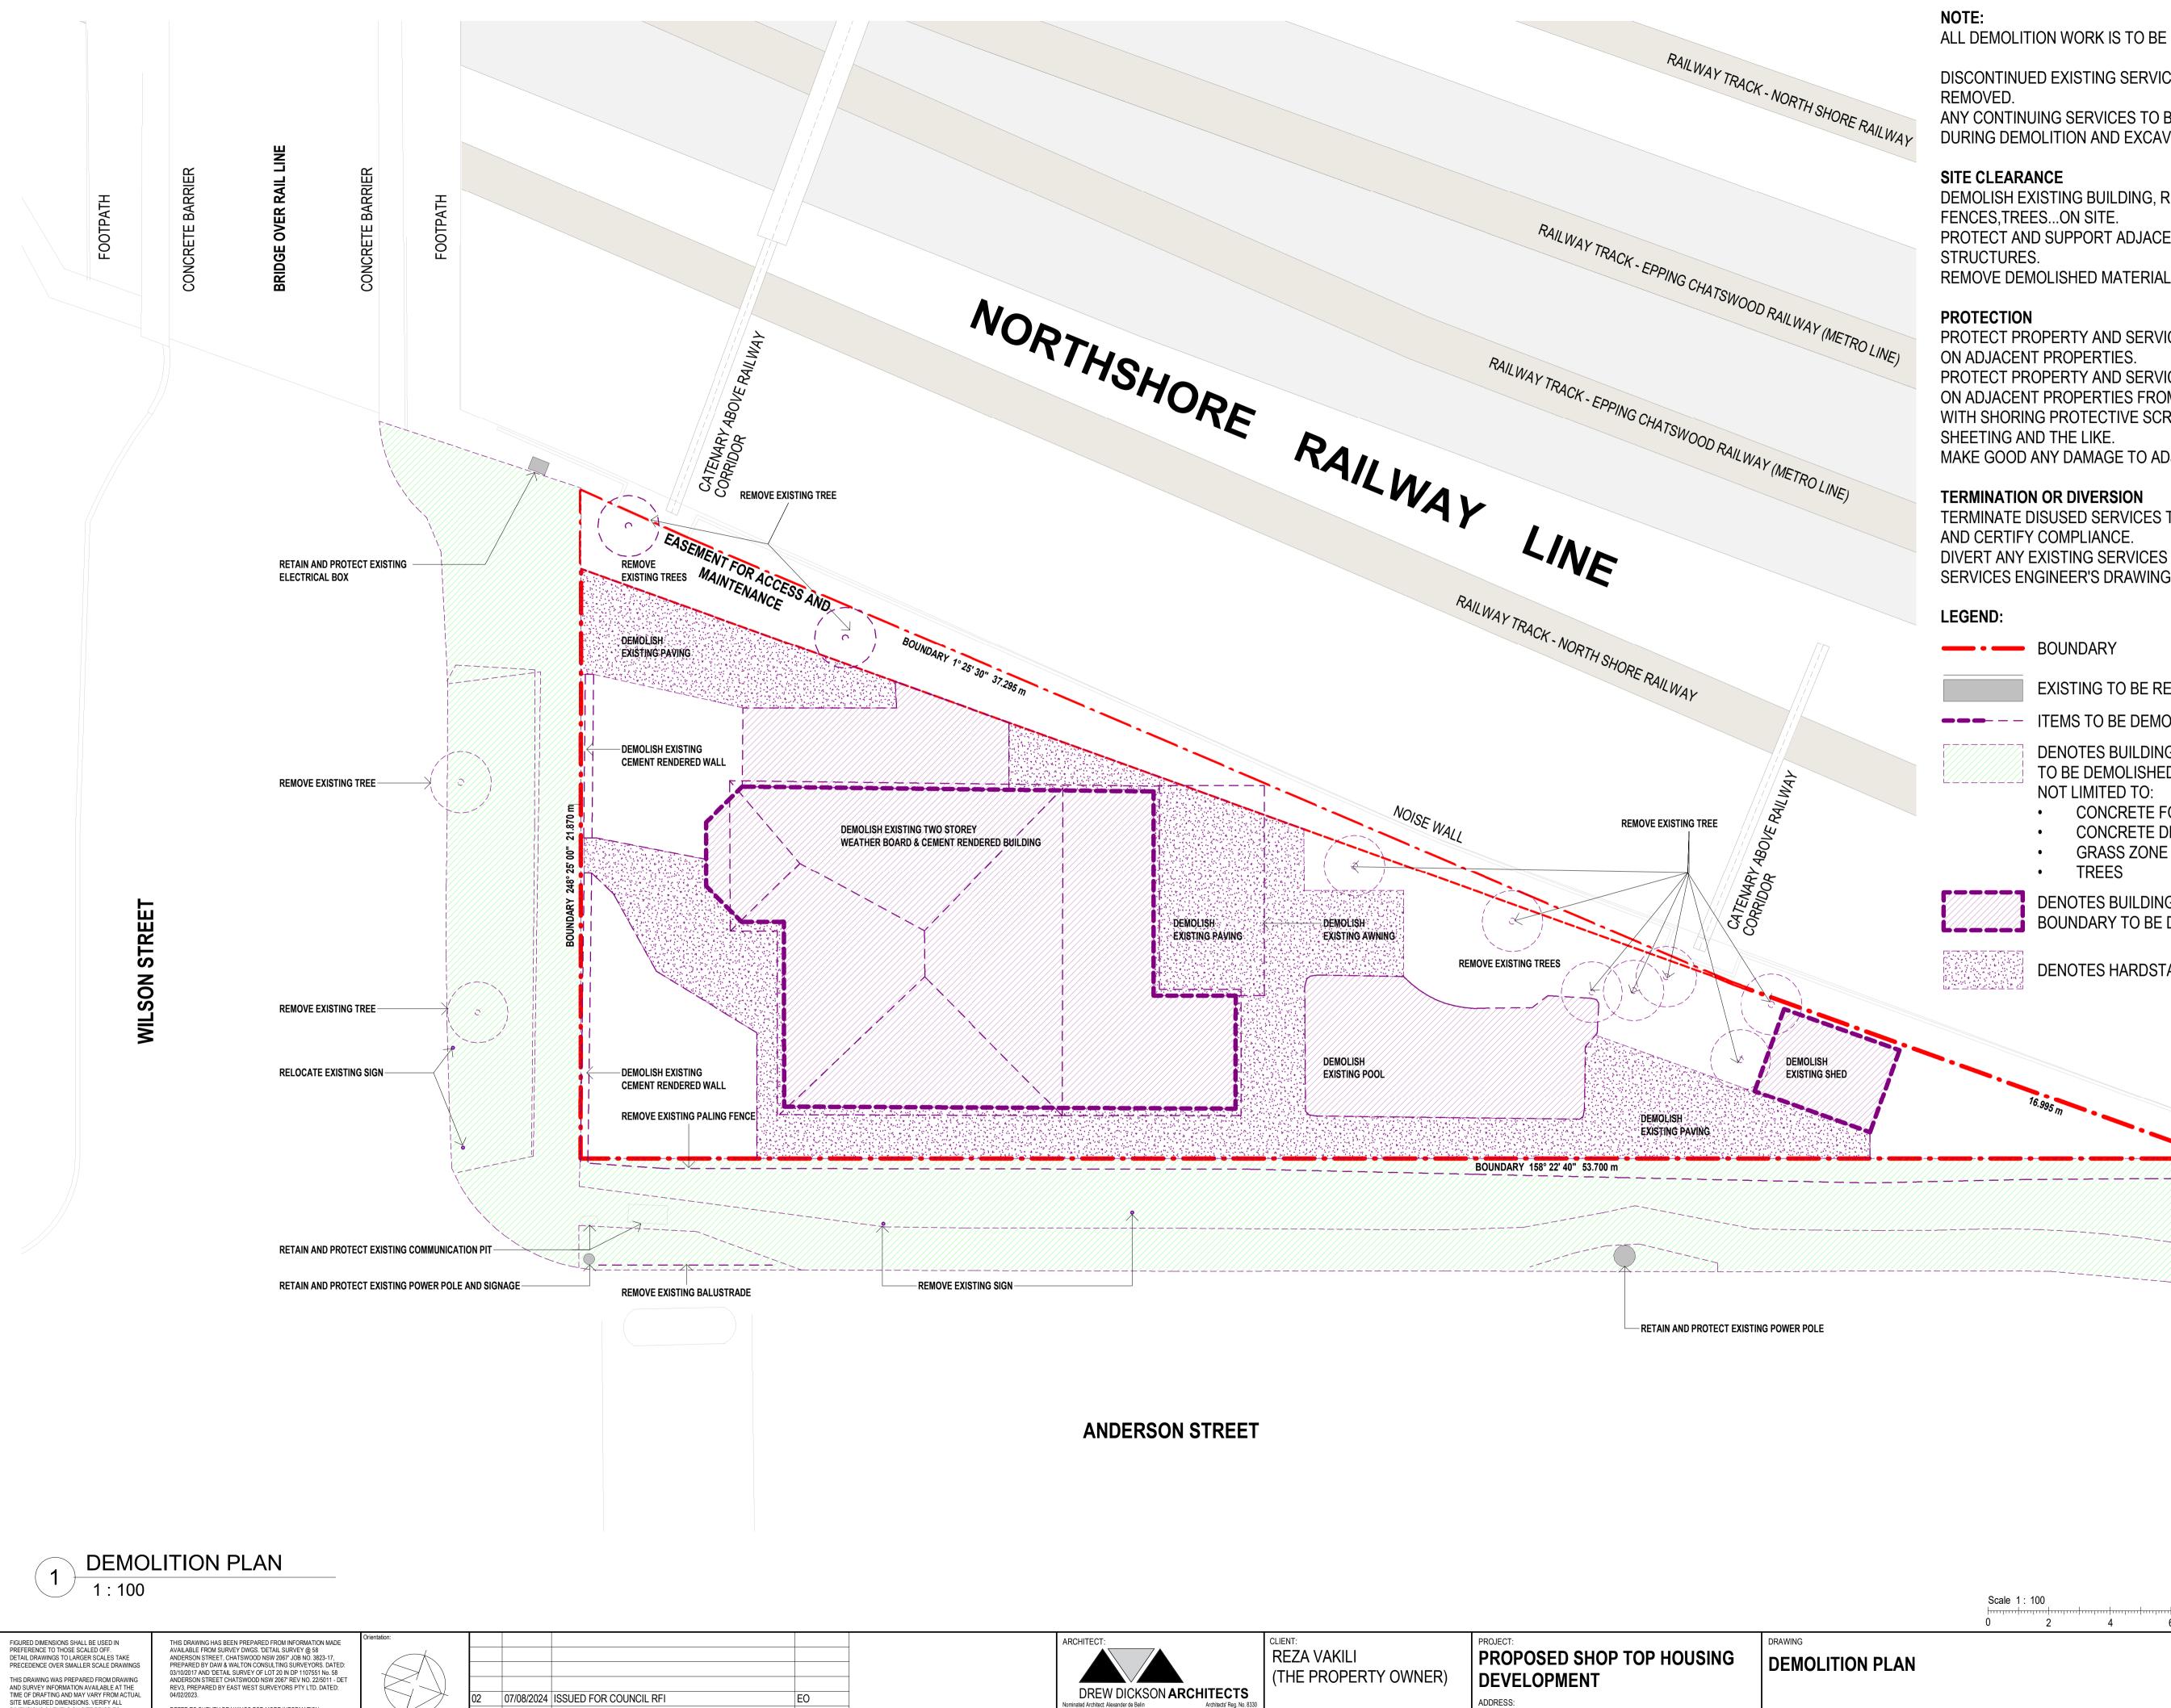

EO

VE

ISSUED BY

23/02/2023 ISSUED FOR DEVELOPMENT APPLICATION

DESCRIPTION

ISSUE DATE

DIMENSIONS & LEVELS ON SITE PRIOR TO FABRICATION OF COMPONENTS OR COMMENCEMENT OF WORK ON SITE.

REFER TO SURVEY DRAWINGS FOR MORE INFORMATION.

ARCHITECT:		PROJECT: PROPOSED SHOP TOP HOUSING	DRAWING DEMOLITION PLAN		OCT 2022	Drawn by: VE
DREW DICKSON ARCHITECTS (T	(THE PROPERTY OWNER)	DEVELOPMENT		Drawing Status: DEVELOPMENT APPLICATION		
Nominated Architect: Alexander de Belin         Architects' Reg. No. 8330           DREW DICKSON ARCHITECTS PTY LIMITED         ABN 12 168 892 153           SUITE 2,GROUND FLOOR, 83 ALEXANDER STREET CROWS NEST NSW 2065 AUSTRALIA         Tel: +61 2 90613433           Tel: +61 2 90613433         Email: info@dda-australia.com         Web: www.dda-australia.com		ADDRESS: 58 ANDERSON STREET CHATSWOOD, NSW, 2067		Project / Job No: 18014	Drawing No: A012	Revision:

### NOTE:

ALL DEMOLITION WORK IS TO BE IN ACCORDANCE WITH AS2601.

#### DISCONTINUED EXISTING SERVICES TO BE CAPPED OFF & REMOVED. ANY CONTINUING SERVICES TO BE CAPPED AND PROTECTED

DURING DEMOLITION AND EXCAVATION.

#### SITE CLEARANCE

DEMOLISH EXISTING BUILDING, RETAINING WALLS, FENCES, TREES... ON SITE. PROTECT AND SUPPORT ADJACENT AND RETAINED STRUCTURES. REMOVE DEMOLISHED MATERIALS, SLABS.

#### PROTECTION

PROTECT PROPERTY AND SERVICES, WHICH ARE TO REMAIN OR ON ADJACENT PROPERTIES. PROTECT PROPERTY AND SERVICES, WHICH ARE TO REMAIN OR ON ADJACENT PROPERTIES FROM INTERFERENCE OR DAMAGE WITH SHORING PROTECTIVE SCREENS, SHEETING AND THE LIKE. MAKE GOOD ANY DAMAGE TO ADJOINING STRUCTURES.


#### **TERMINATION OR DIVERSION**

TERMINATE DISUSED SERVICES TO AUTHORITY REQUIREMENTS AND CERTIFY COMPLIANCE. DIVERT ANY EXISTING SERVICES WHERE INDICATED ON THE SERVICES ENGINEER'S DRAWINGS.


#### LEGEND:

	BOUNDARY
	EXISTING TO BE RETAINED
	ITEMS TO BE DEMOLISHED / REMOVED
	DENOTES BUILDING ELEMENTS FROM PUBLIC DOMAIN TO BE DEMOLISHED / RELOCATED. THIS INCLUDES, BUT IS NOT LIMITED TO: CONCRETE FOOT PATH CONCRETE DRIVEWAY GRASS ZONE TREES
	DENOTES BUILDING ELEMENTS WITHIN PROPERTY BOUNDARY TO BE DEMOLISHED
	DENOTES HARDSTAND TO BE DEMOLISHED
	16.995 m


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0	2	4	6

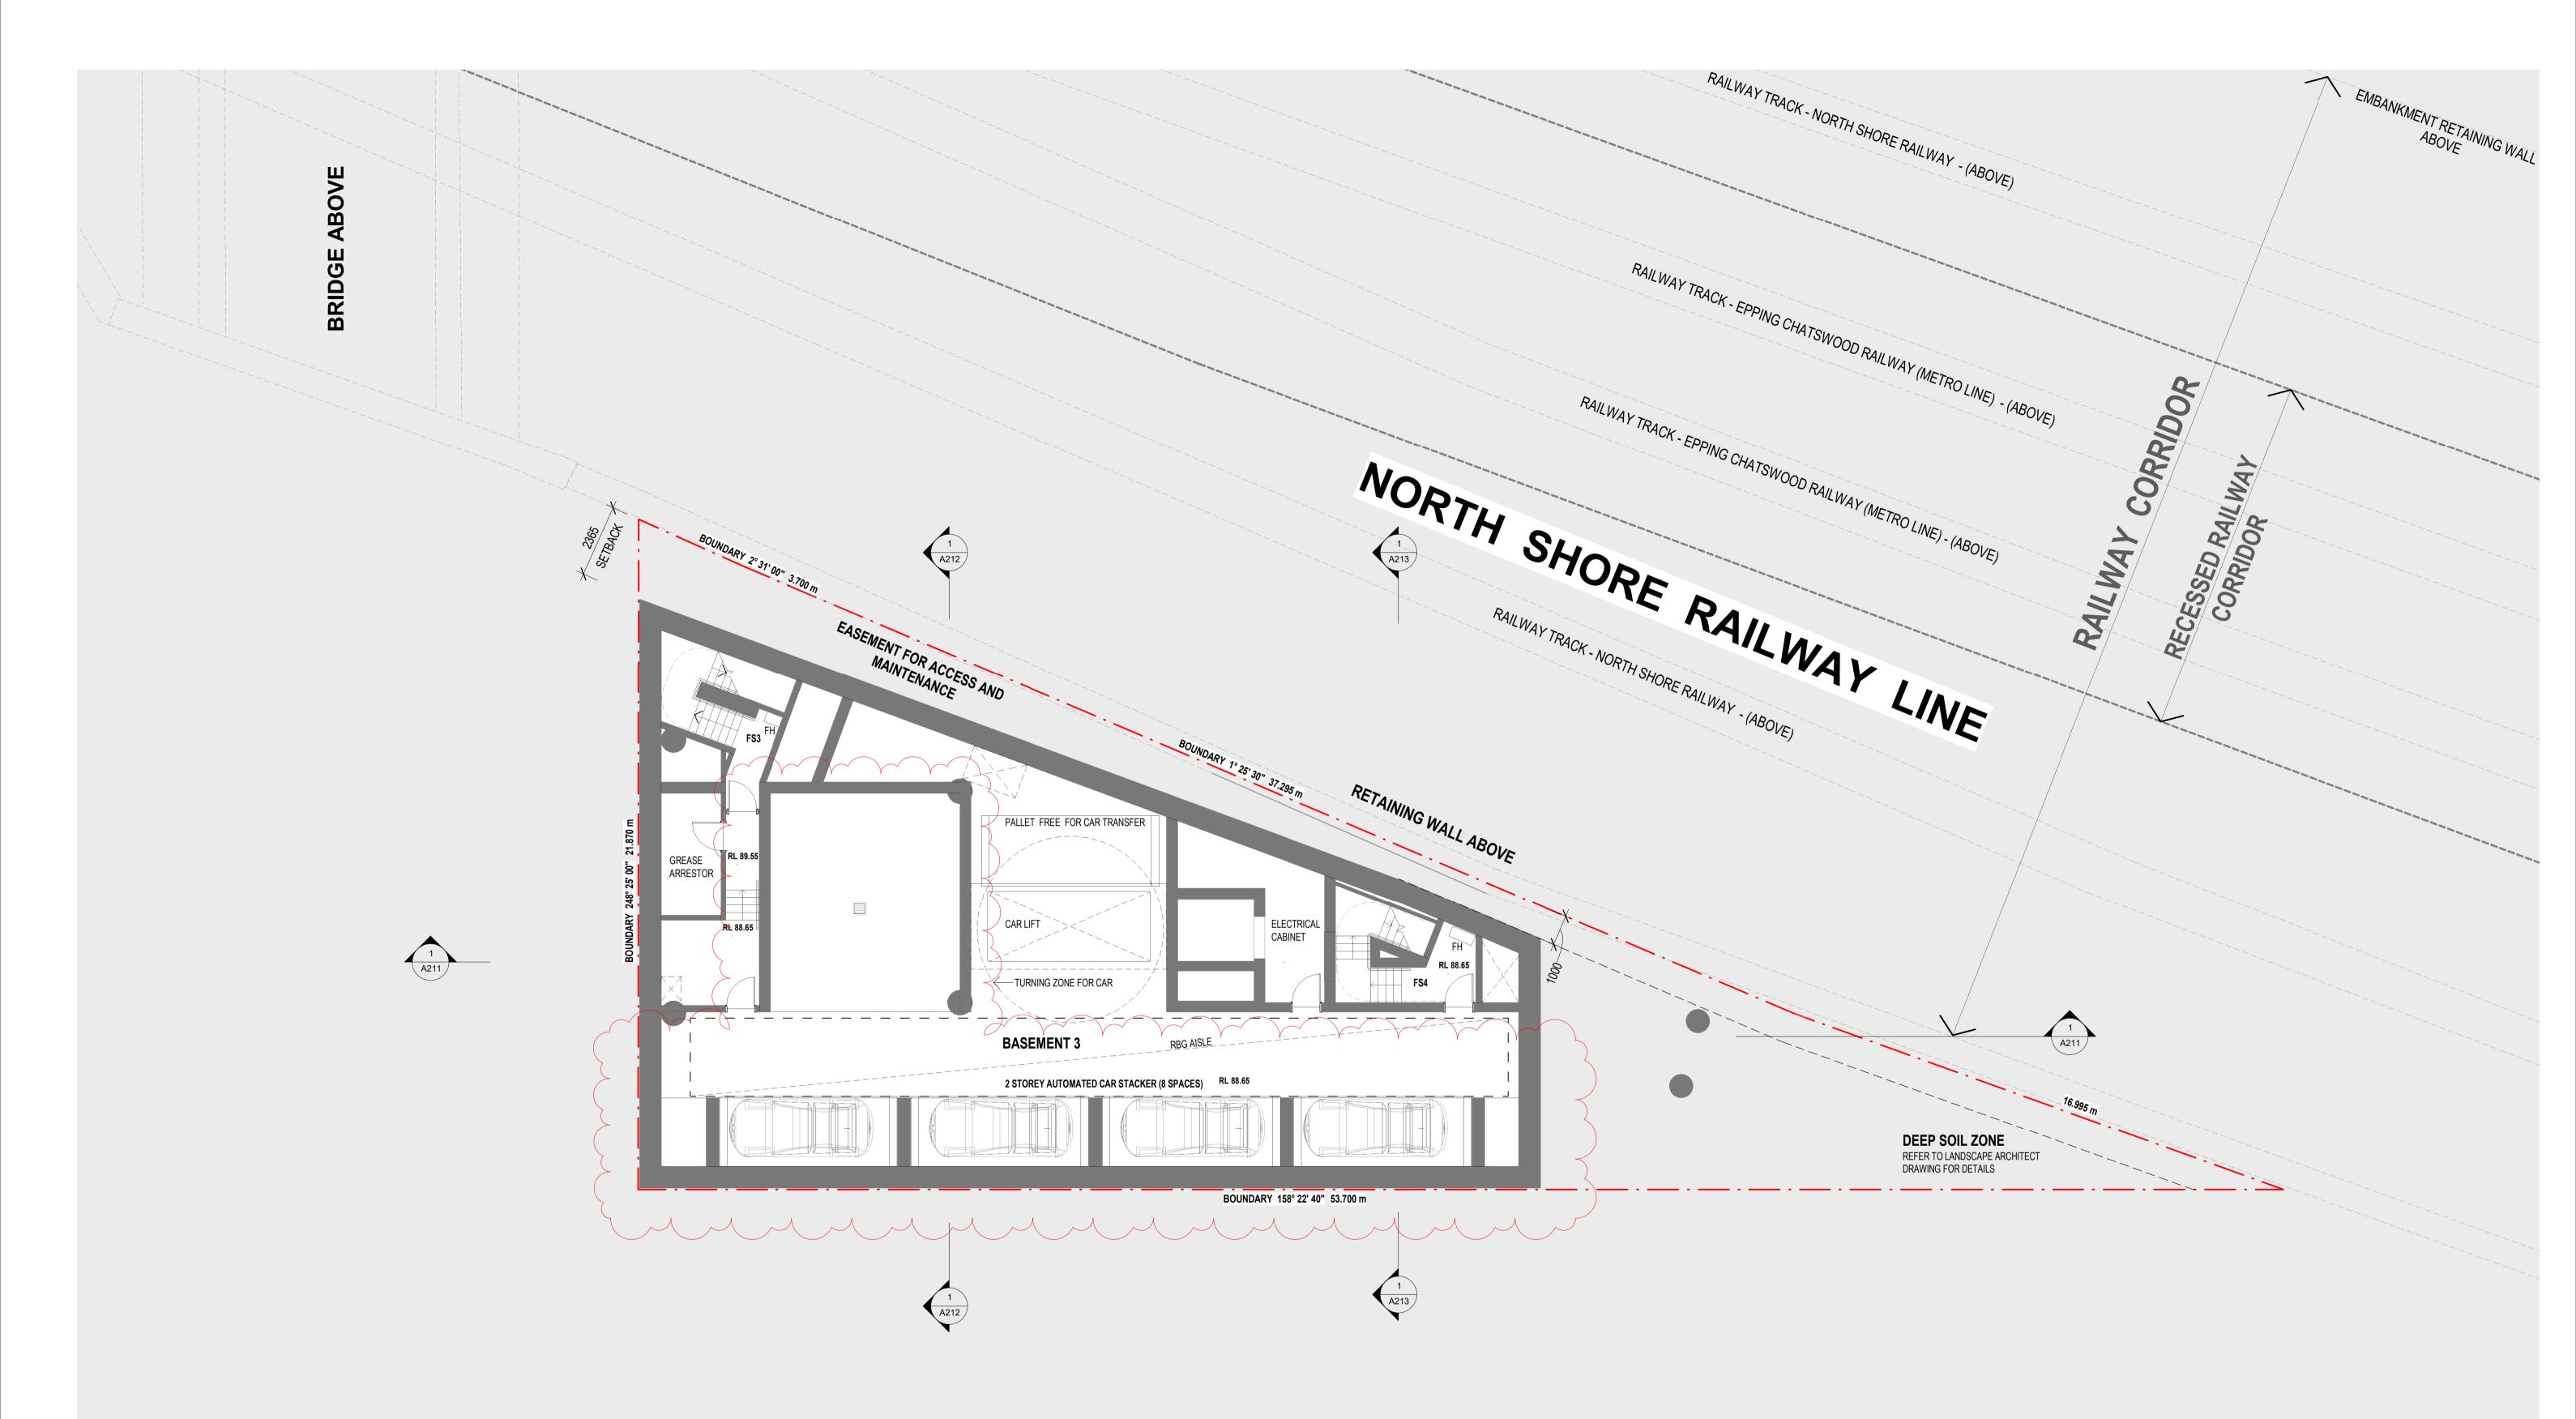




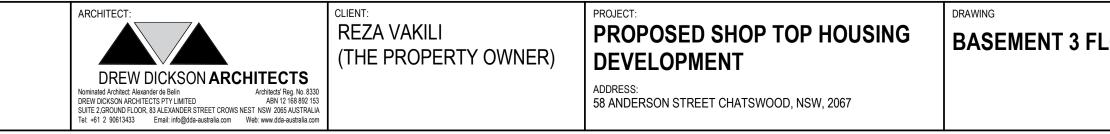


	Scale 1 : 100 	1 1	 ⊢  6				
				Drawing Scale @ A1:	Date:	Drawn	by:
<b>B FLOOR PLAN</b>				1 : 100	OCT 2022	KL	
				Drawing Status:			
				DEVELOPN	MENT APPLICATIC	N	
				Project / Job No:	Drawing No:		Revision:
				18014	A100		04

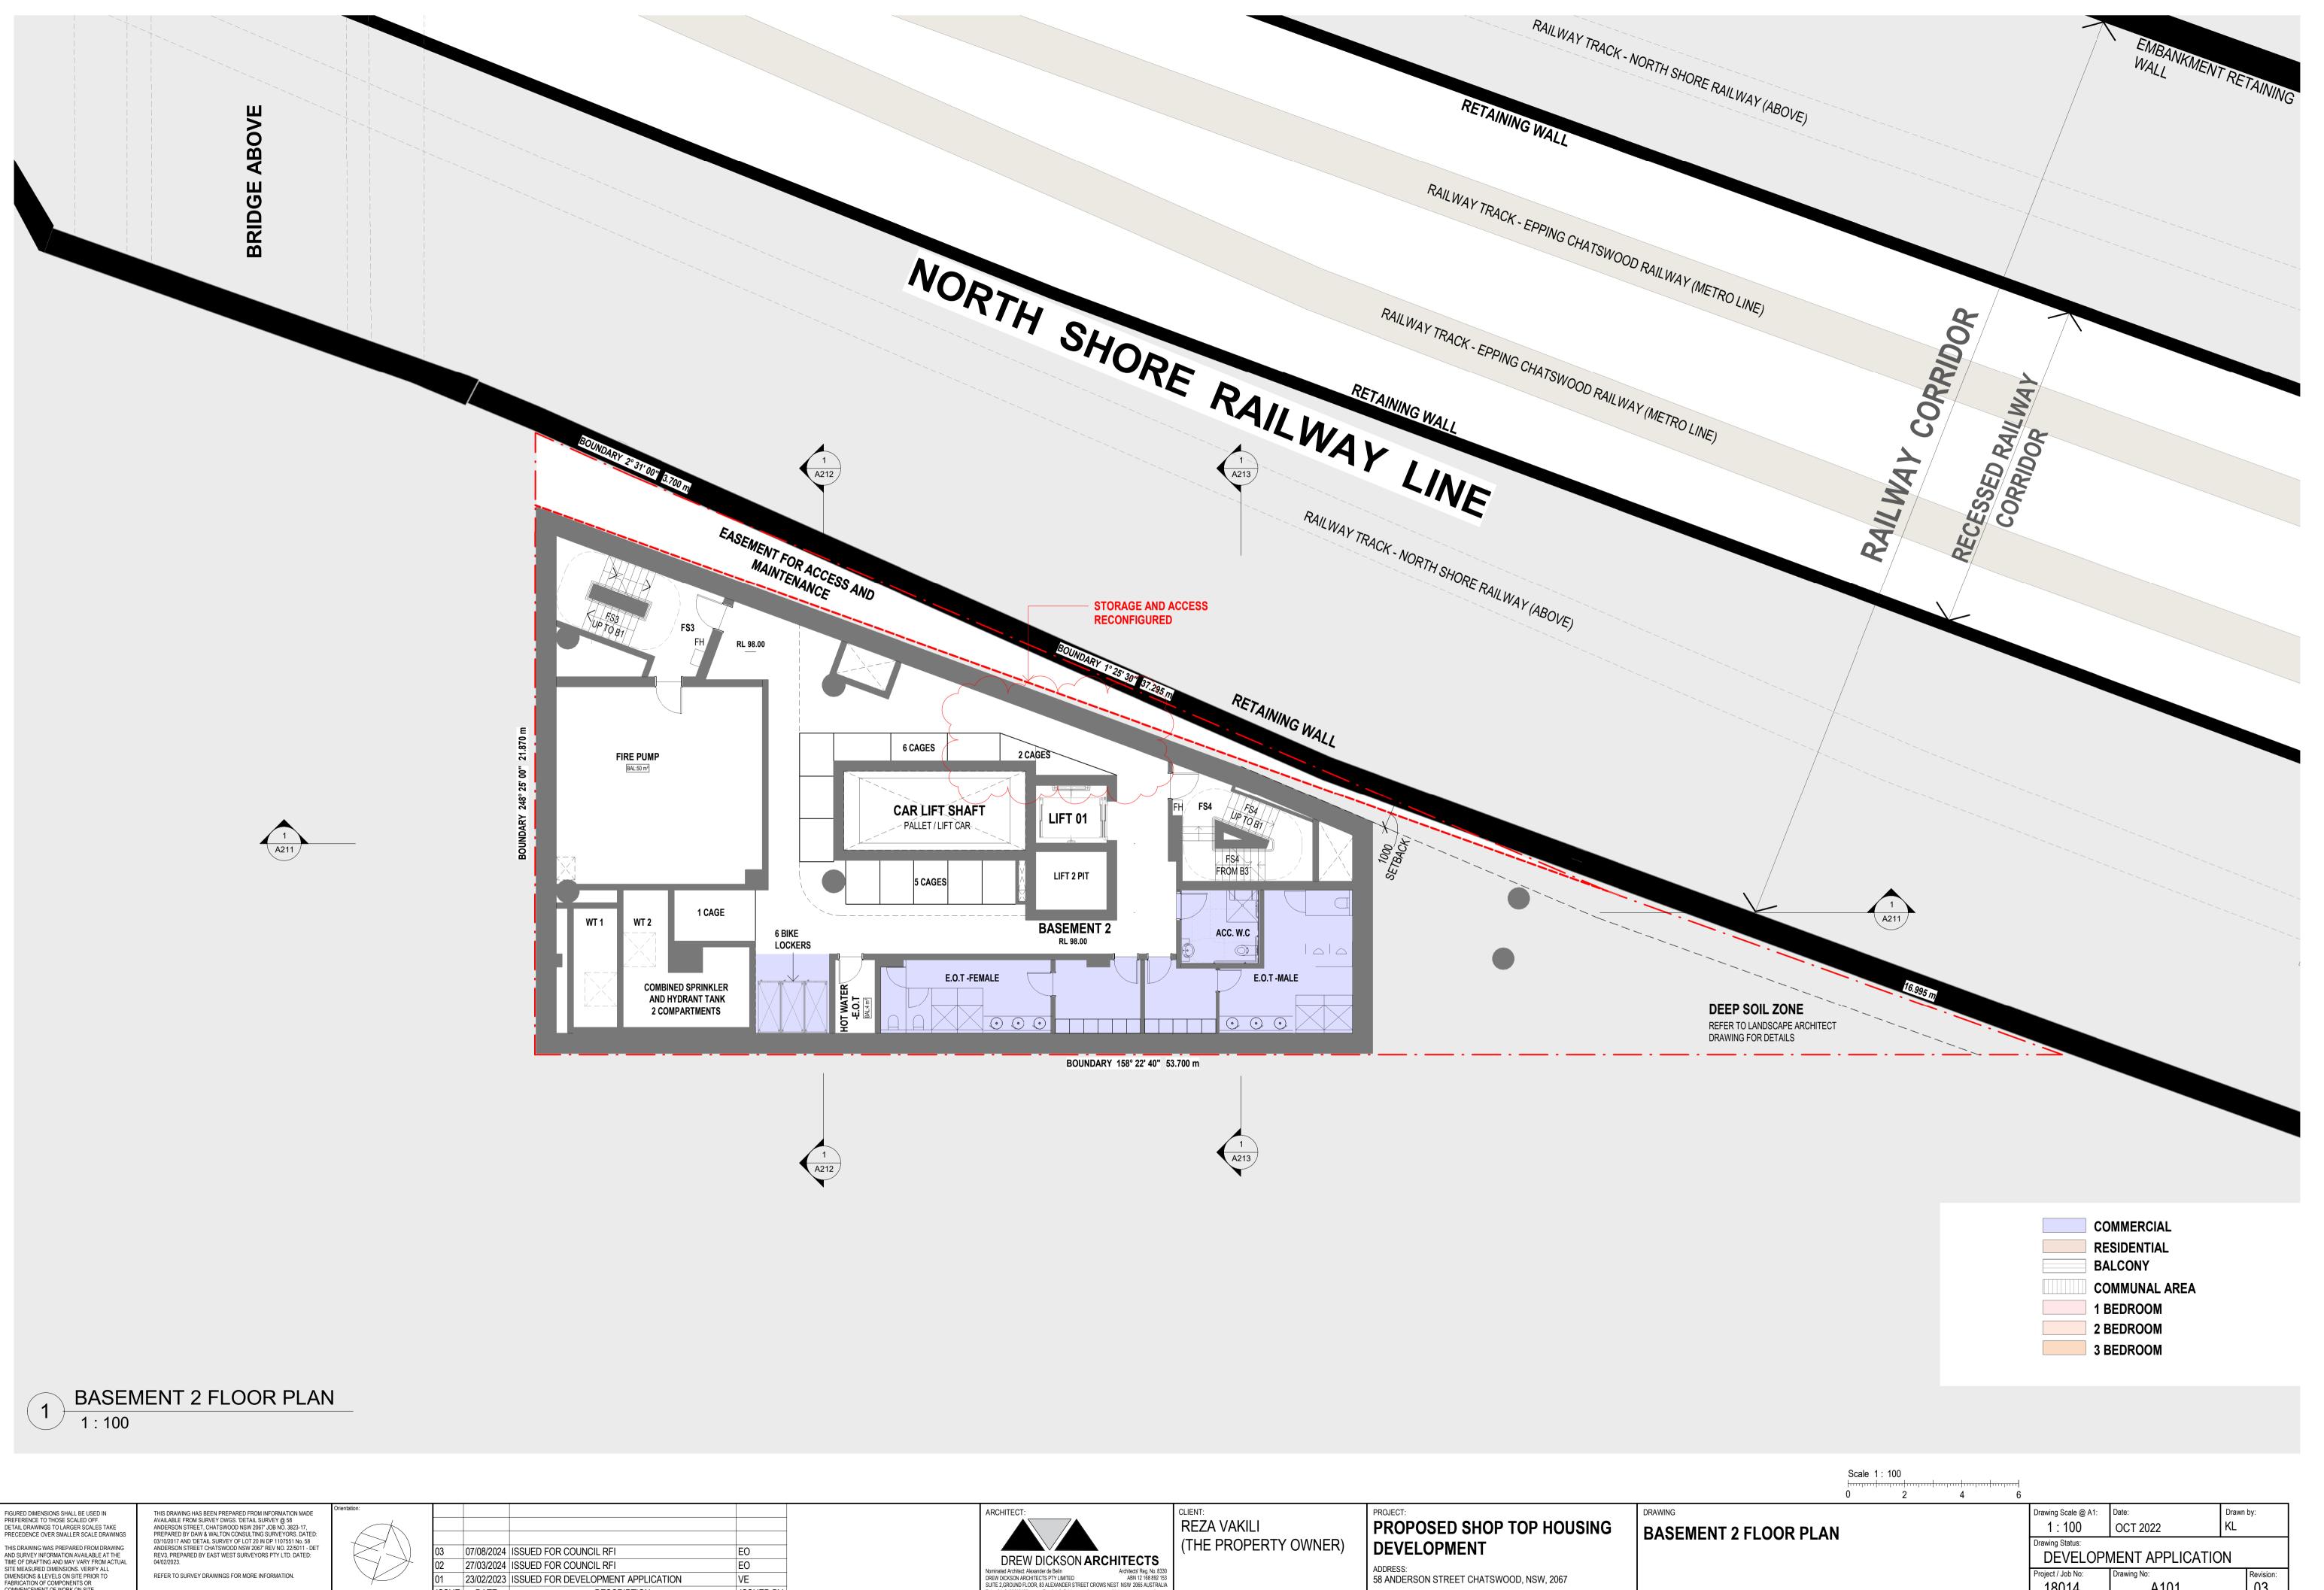


PRECEDENCE OVER SMALLER SCALE DRAWINGS THIS DRAWING WAS PREPARED FROM DRAWING AND SURVEY INFORMATION AVAILABLE AT THE TIME OF DRAFTING AND MAY VARY FROM ACTUAL SITE MEASURED DIMENSIONS. VERIFY ALL DIMENSIONS & LEVELS ON SITE PRIOR TO FABRICATION OF COMPONENTS OR COMMENCEMENT OF WORK ON SITE.

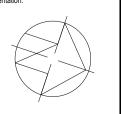


ISSUE DATE DESCRIPTION ISSUED BY

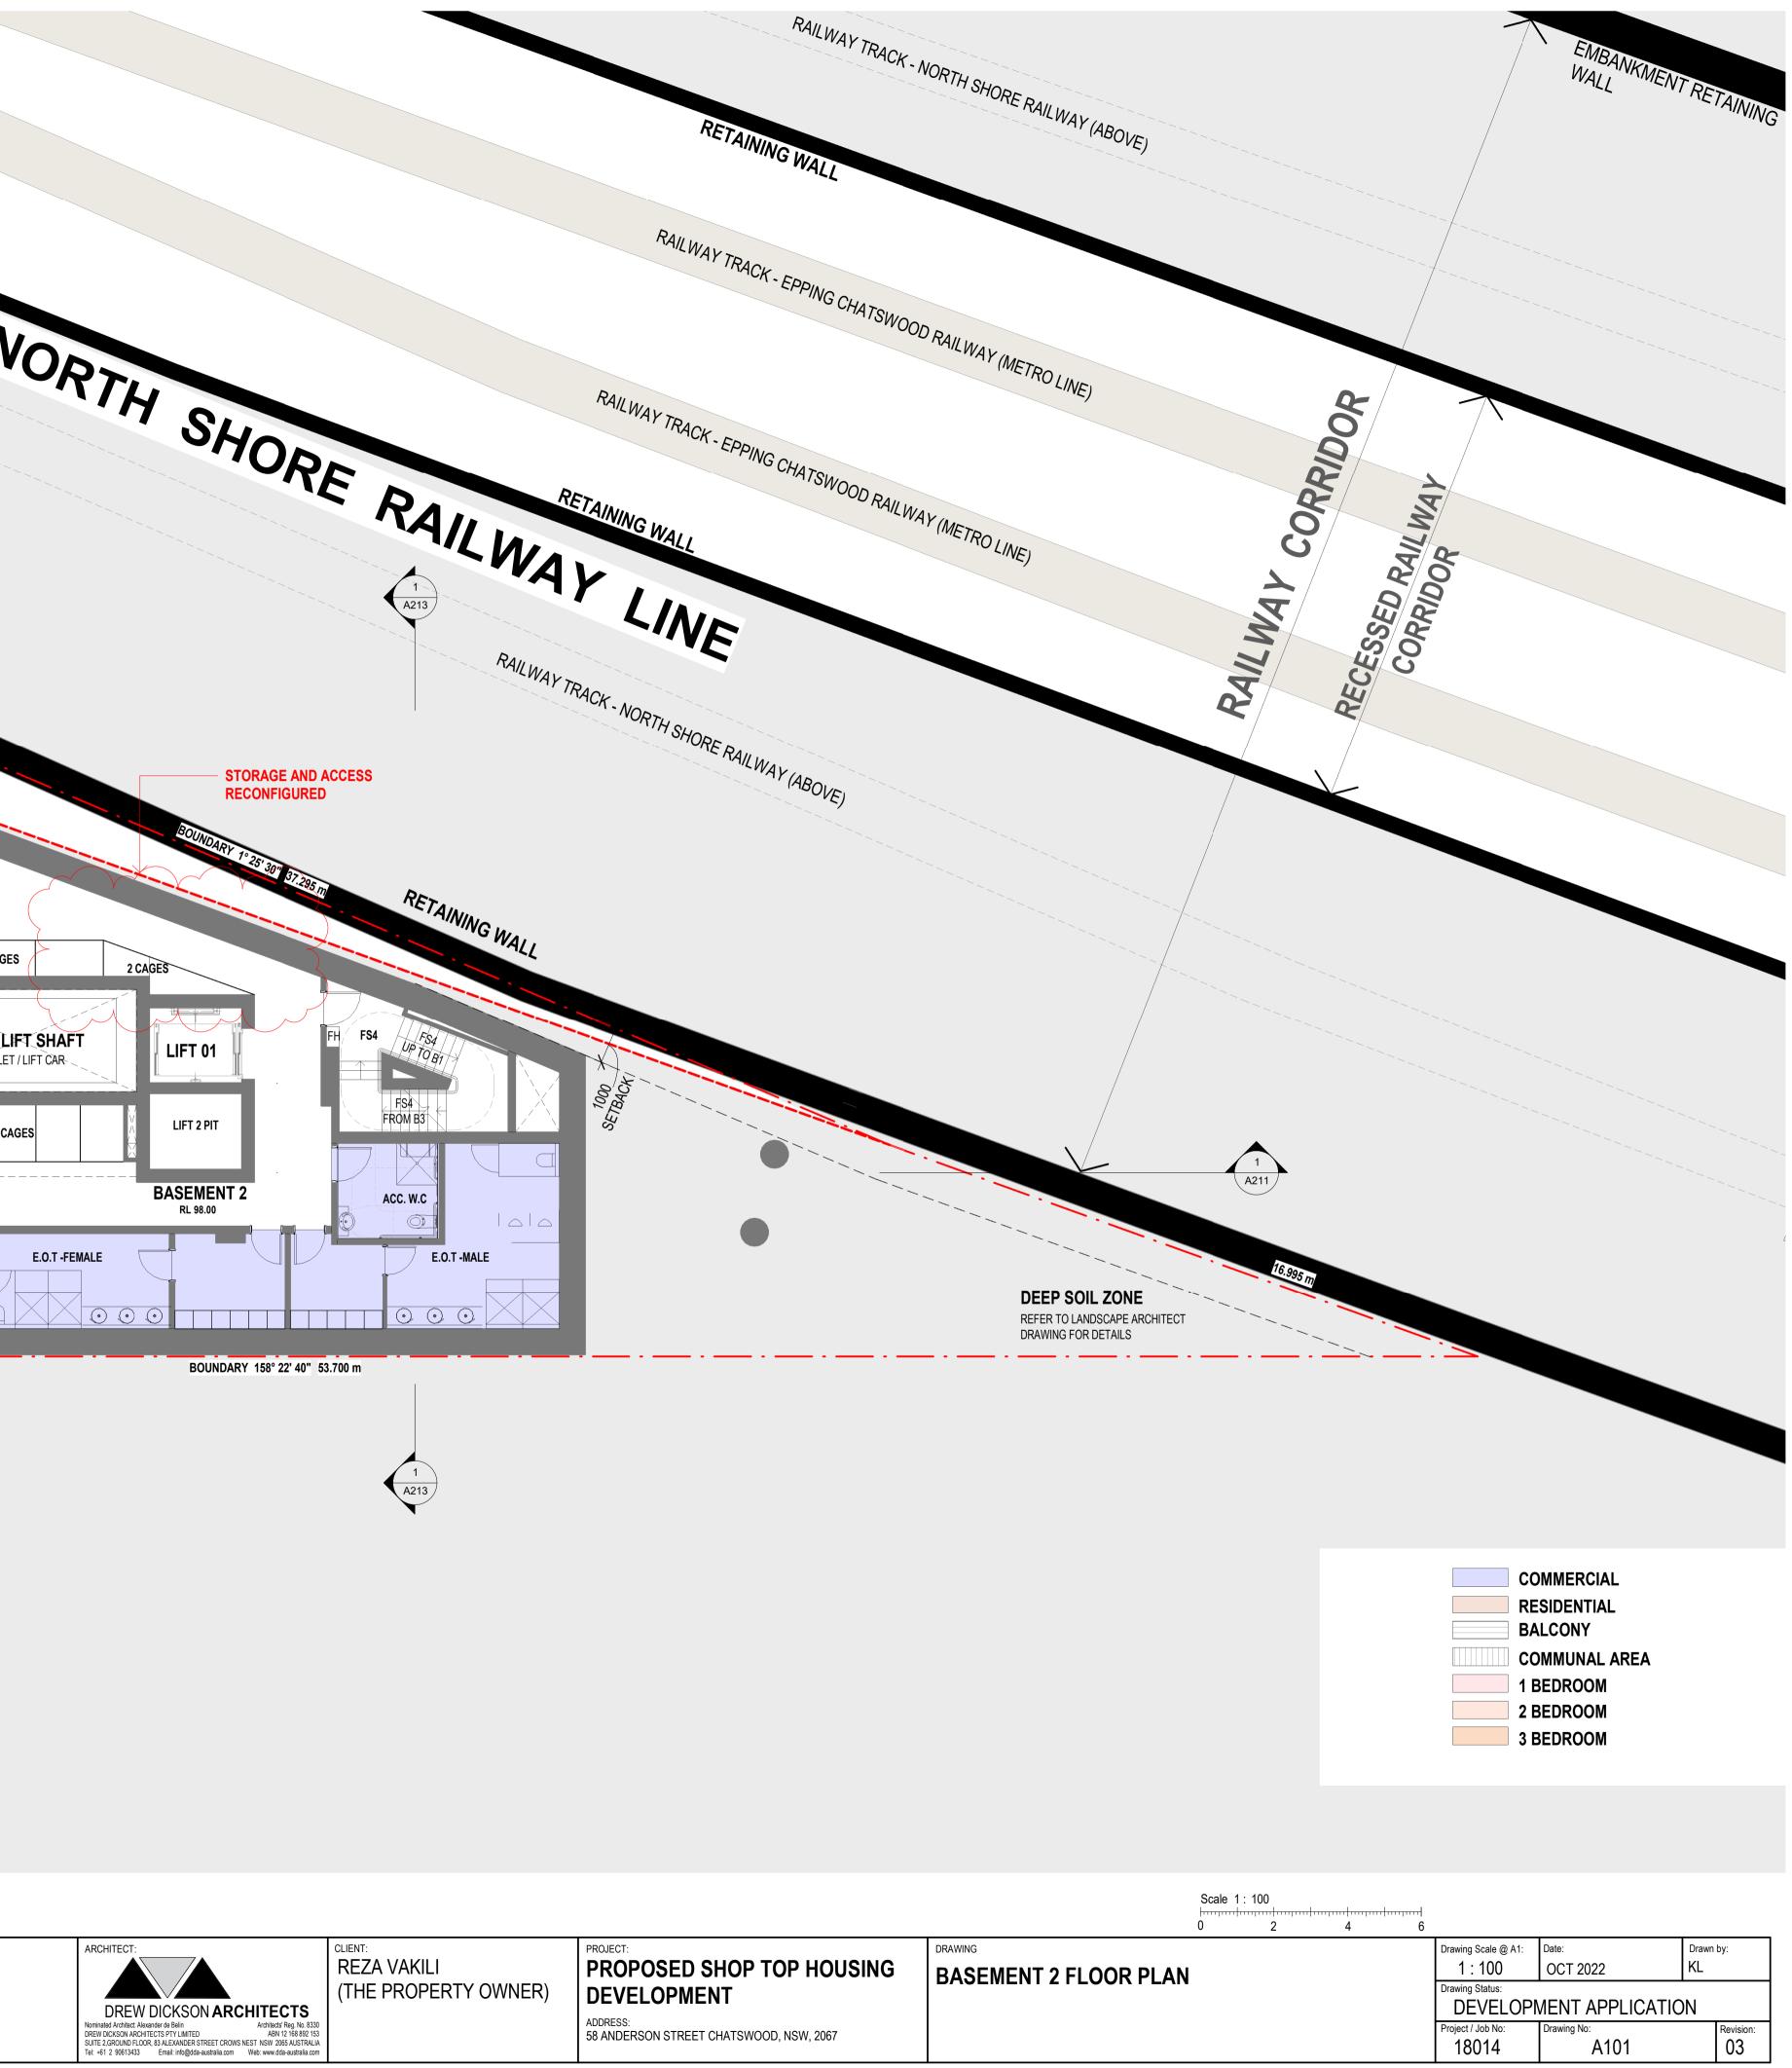

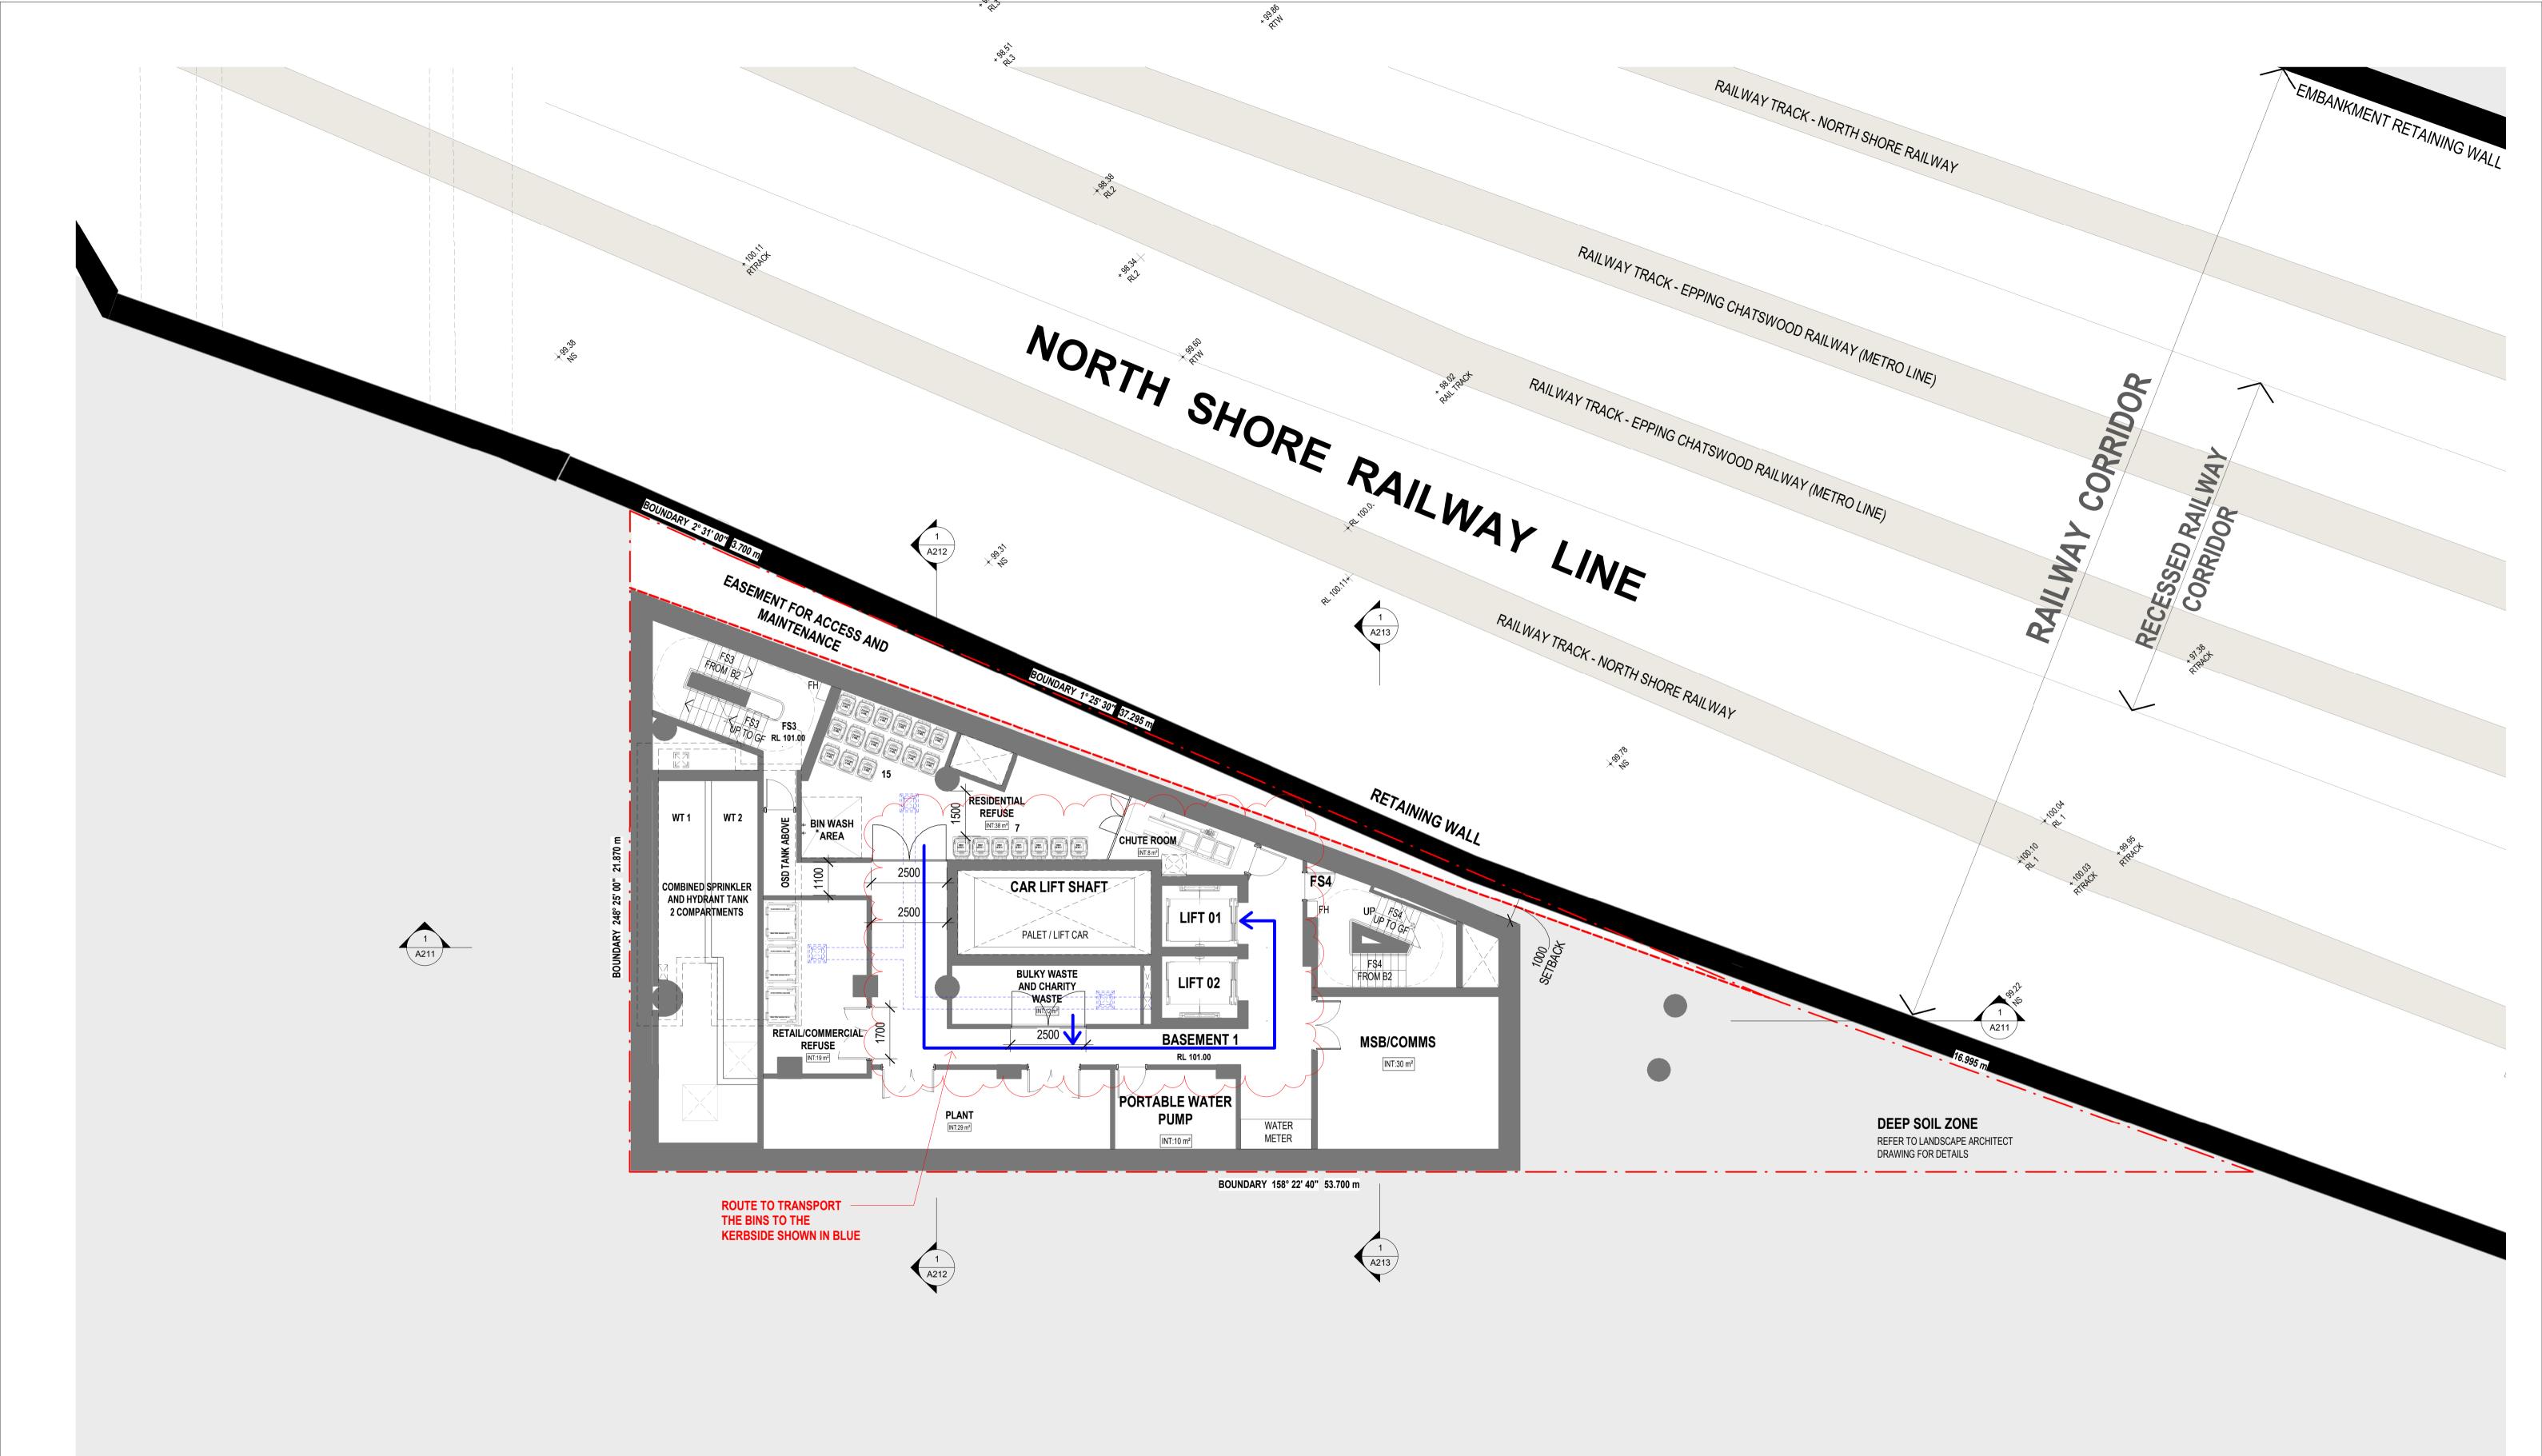


### BASEMENT 1 FLOOR PLAN 1:100

FIGURED DIMENSIONS SHALL BE USED IN	THIS DRAWING HAS BEEN PREPARED FROM INFORMATION MADE	Orientation:					
PREFERENCE TO THOSE SCALED OFF. DETAIL DRAWINGS TO LARGER SCALES TAKE	AVAILABLE FROM SURVEY DWGS. 'DETAIL SURVEY @ 58 ANDERSON STREET, CHATSWOOD NSW 2067' JOB NO. 3823-17,	$\frown$					
PRECEDENCE OVER SMALLER SCALE DRAWINGS	PREPARED BY DAW & WALTON CONSULTING SURVEYORS. DATED: 03/10/2017 AND 'DETAIL SURVEY OF LOT 20 IN DP 1107551 №. 58		04	14/10/2024	ISSUE FOR COUNCIL RFI	EO	
THIS DRAWING WAS PREPARED FROM DRAWING AND SURVEY INFORMATION AVAILABLE AT THE	ANDERSON STREET CHATSWOOD NSW 2067' REV NO. 22/5011 - DET REV3, PREPARED BY EAST WEST SURVEYORS PTY LTD. DATED:		03	07/08/2024	ISSUED FOR COUNCIL RFI	EO	
TIME OF DRAFTING AND MAY VARY FROM ACTUAL SITE MEASURED DIMENSIONS. VERIFY ALL	04/02/2023.		02	27/03/2024	ISSUED FOR COUNCIL RFI	EO	
DIMENSIONS & LEVELS ON SITE PRIOR TO FABRICATION OF COMPONENTS OR	REFER TO SURVEY DRAWINGS FOR MORE INFORMATION.	$\checkmark$	01	23/02/2023	ISSUED FOR DEVELOPMENT APPLICATION	VE	
COMMENCEMENT OF WORK ON SITE.			ISSUE	DATE	DESCRIPTION	ISSUED BY	

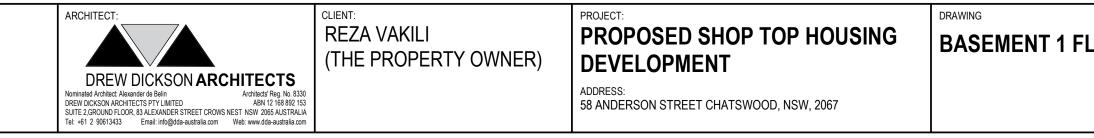


FLOOR PLAN	Drawing Scale @ A1: 1:100	Date: OCT 2022	Drawn by: KL
	Drawing Status: DEVELOPN	MENT APPLICATIC	N
	Project / Job No: 18014	Drawing No: A102	Revision:

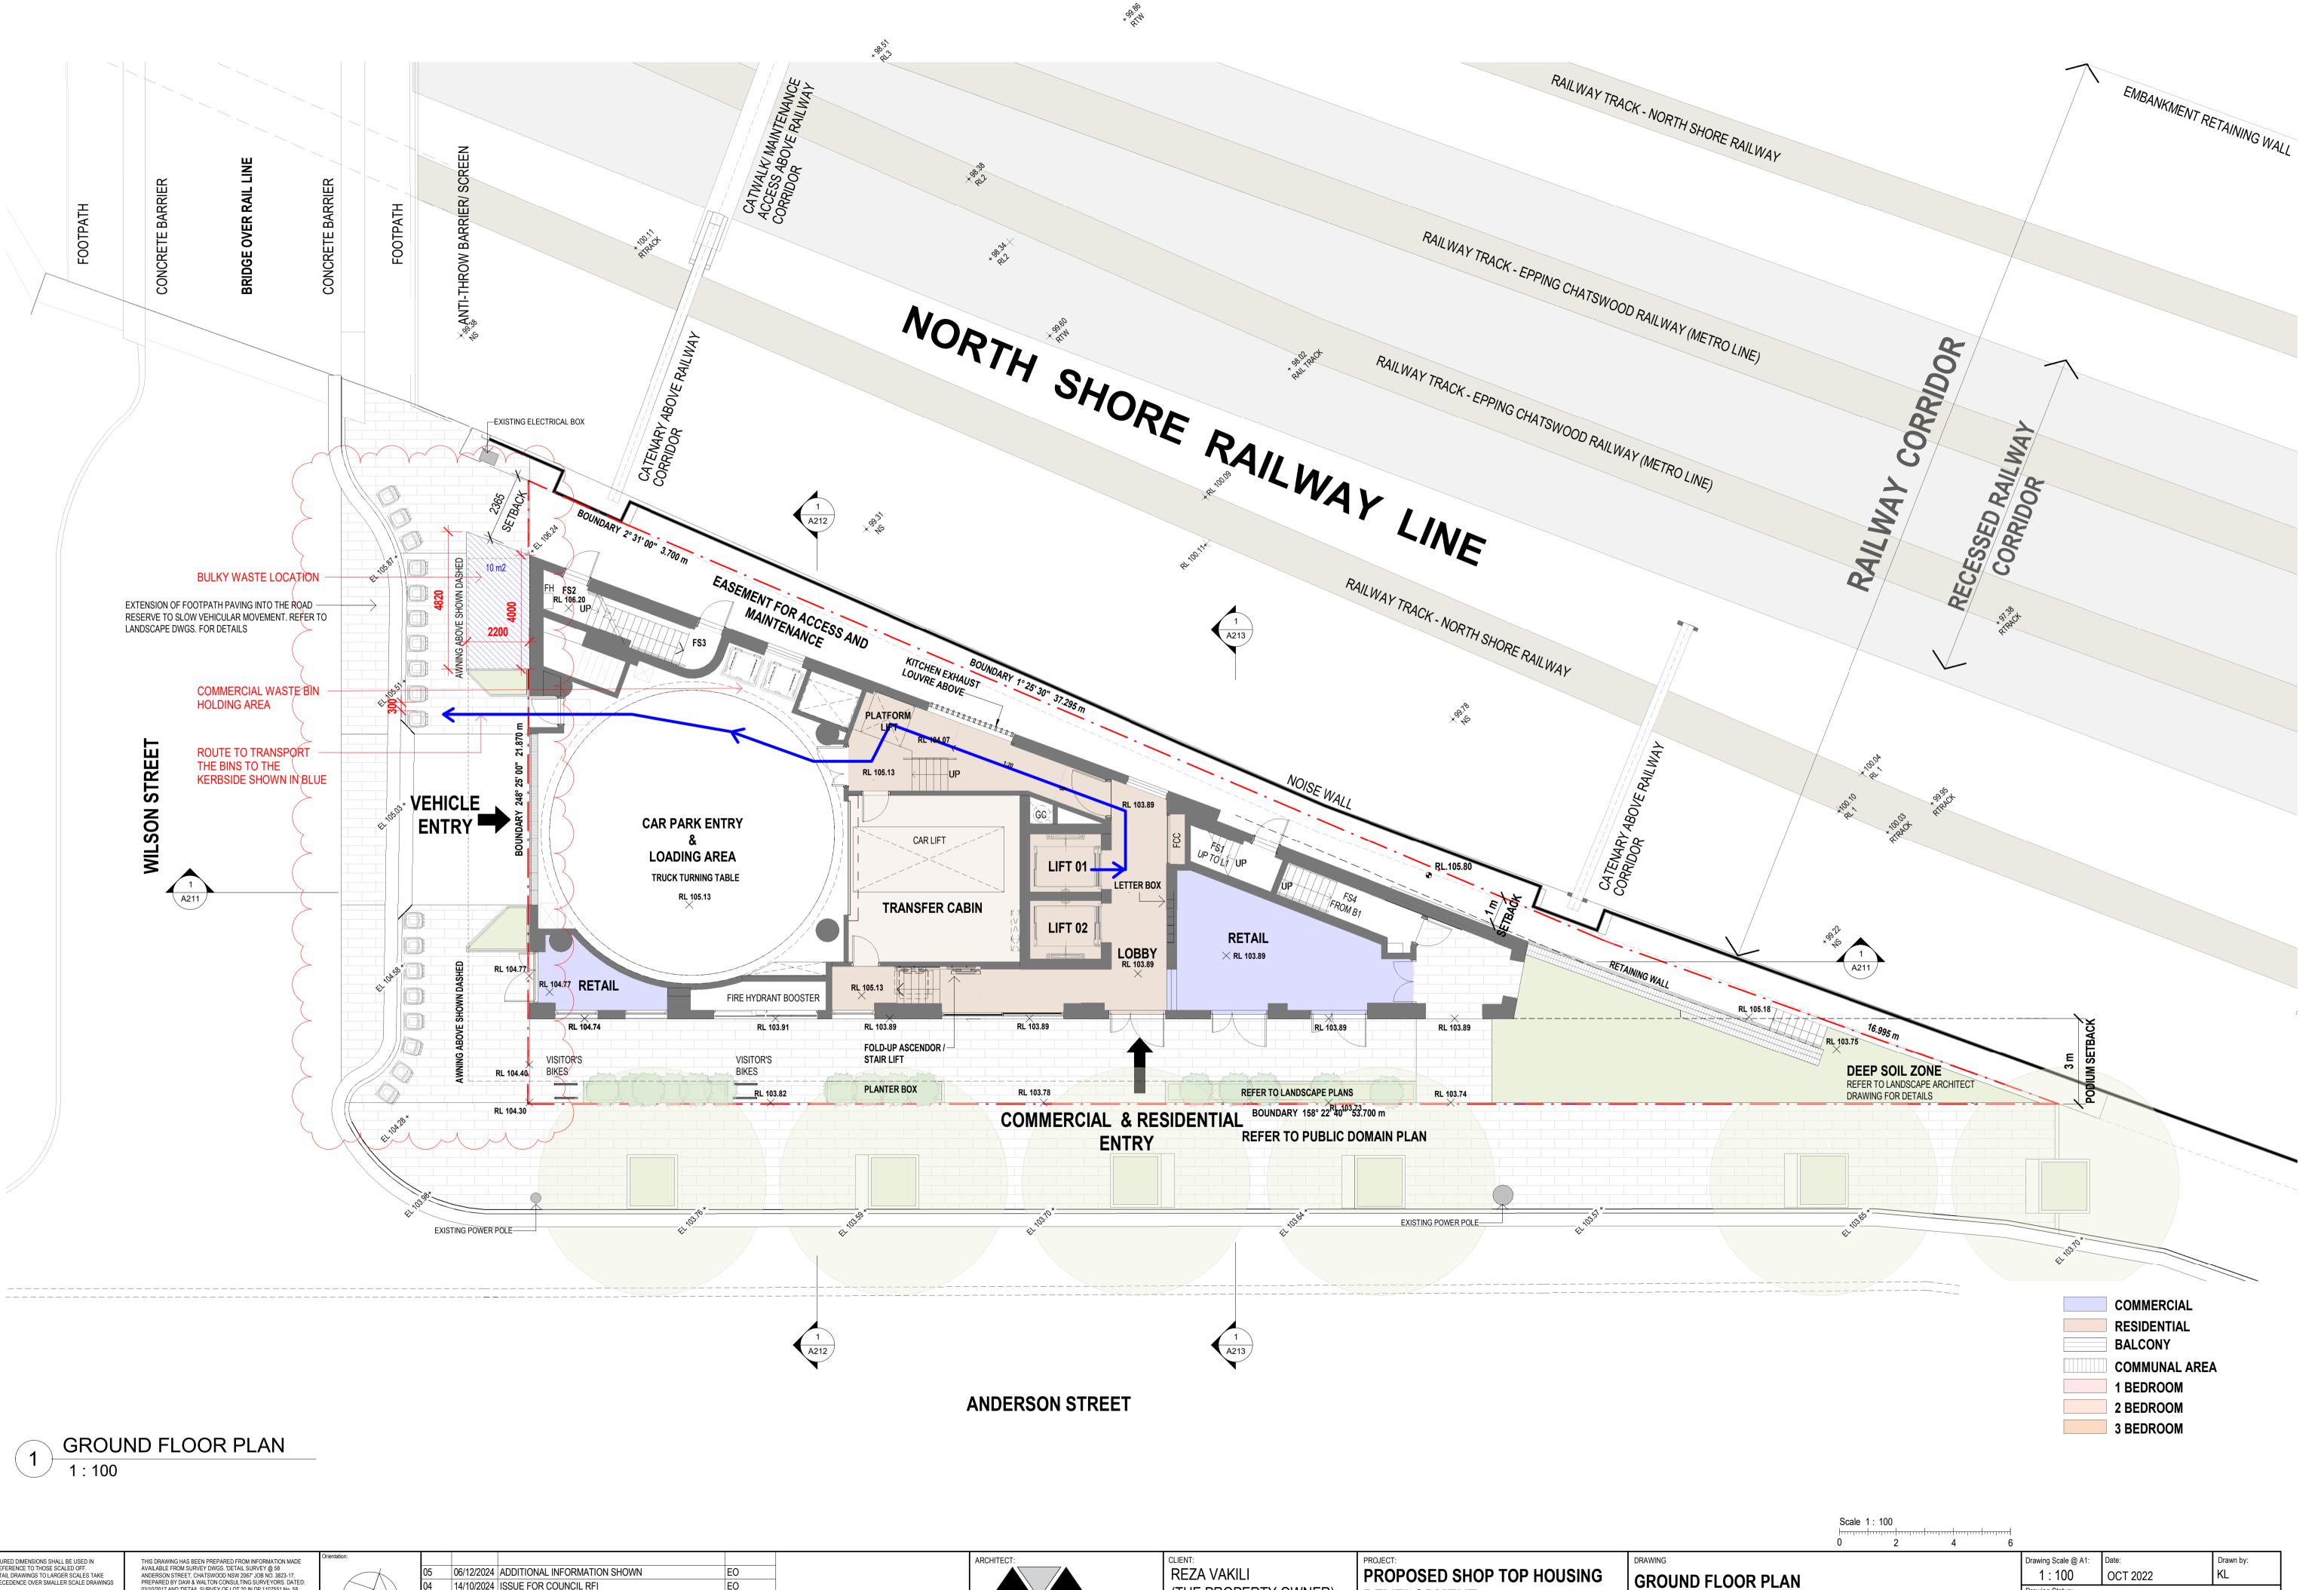



FIGURED DIMENSIONS SHALL BE USED IN	THIS DRAWING HAS BEEN PREPARED FROM INFORMATION MADE	Orientation:				
PREFERENCE TO THOSE SCALED OFF. DETAIL DRAWINGS TO LARGER SCALES TAKE	AVAILABLE FROM SURVEY DWGS. 'DETAIL SURVEY @ 58 ANDERSON STREET, CHATSWOOD NSW 2067' JOB NO. 3823-17,	$\frown$	05	06/12/2024	ADDITIONAL INFORMATION SHOWN	EO
PRECEDENCE OVER SMALLER SCALE DRAWINGS	PREPARED BY DAW & WALTON CONSULTING SURVEYORS. DATED: 03/10/2017 AND 'DETAIL SURVEY OF LOT 20 IN DP 1107551 No. 58		04	14/10/2024	ISSUE FOR COUNCIL RFI	EO
THIS DRAWING WAS PREPARED FROM DRAWING AND SURVEY INFORMATION AVAILABLE AT THE	ANDERSON STREET CHATSWOOD NSW 2067' REV NO. 22/5011 - DET REV3, PREPARED BY EAST WEST SURVEYORS PTY LTD. DATED:		03	07/08/2024	ISSUED FOR COUNCIL RFI	EO
TIME OF DRAFTING AND MAY VARY FROM ACTUAL SITE MEASURED DIMENSIONS. VERIFY ALL	04/02/2023.		02	27/03/2024	ISSUED FOR COUNCIL RFI	EO
DIMENSIONS & LEVELS ON SITE PRIOR TO FABRICATION OF COMPONENTS OR	REFER TO SURVEY DRAWINGS FOR MORE INFORMATION.	$\downarrow$	01	23/02/2023	ISSUED FOR DEVELOPMENT APPLICATION	VE
COMMENCEMENT OF WORK ON SITE.			ISSUE	DATE	DESCRIPTION	ISSUED BY

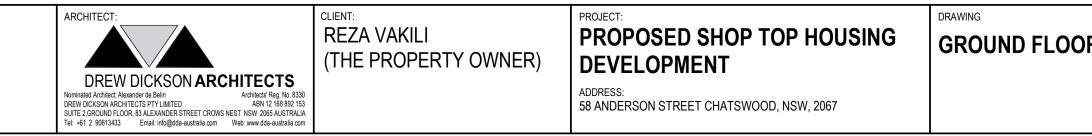

Drawing Status:

roject / Job No:


18014

DEVELOPMENT APPLICATION

wing No

A103


Revision: 05

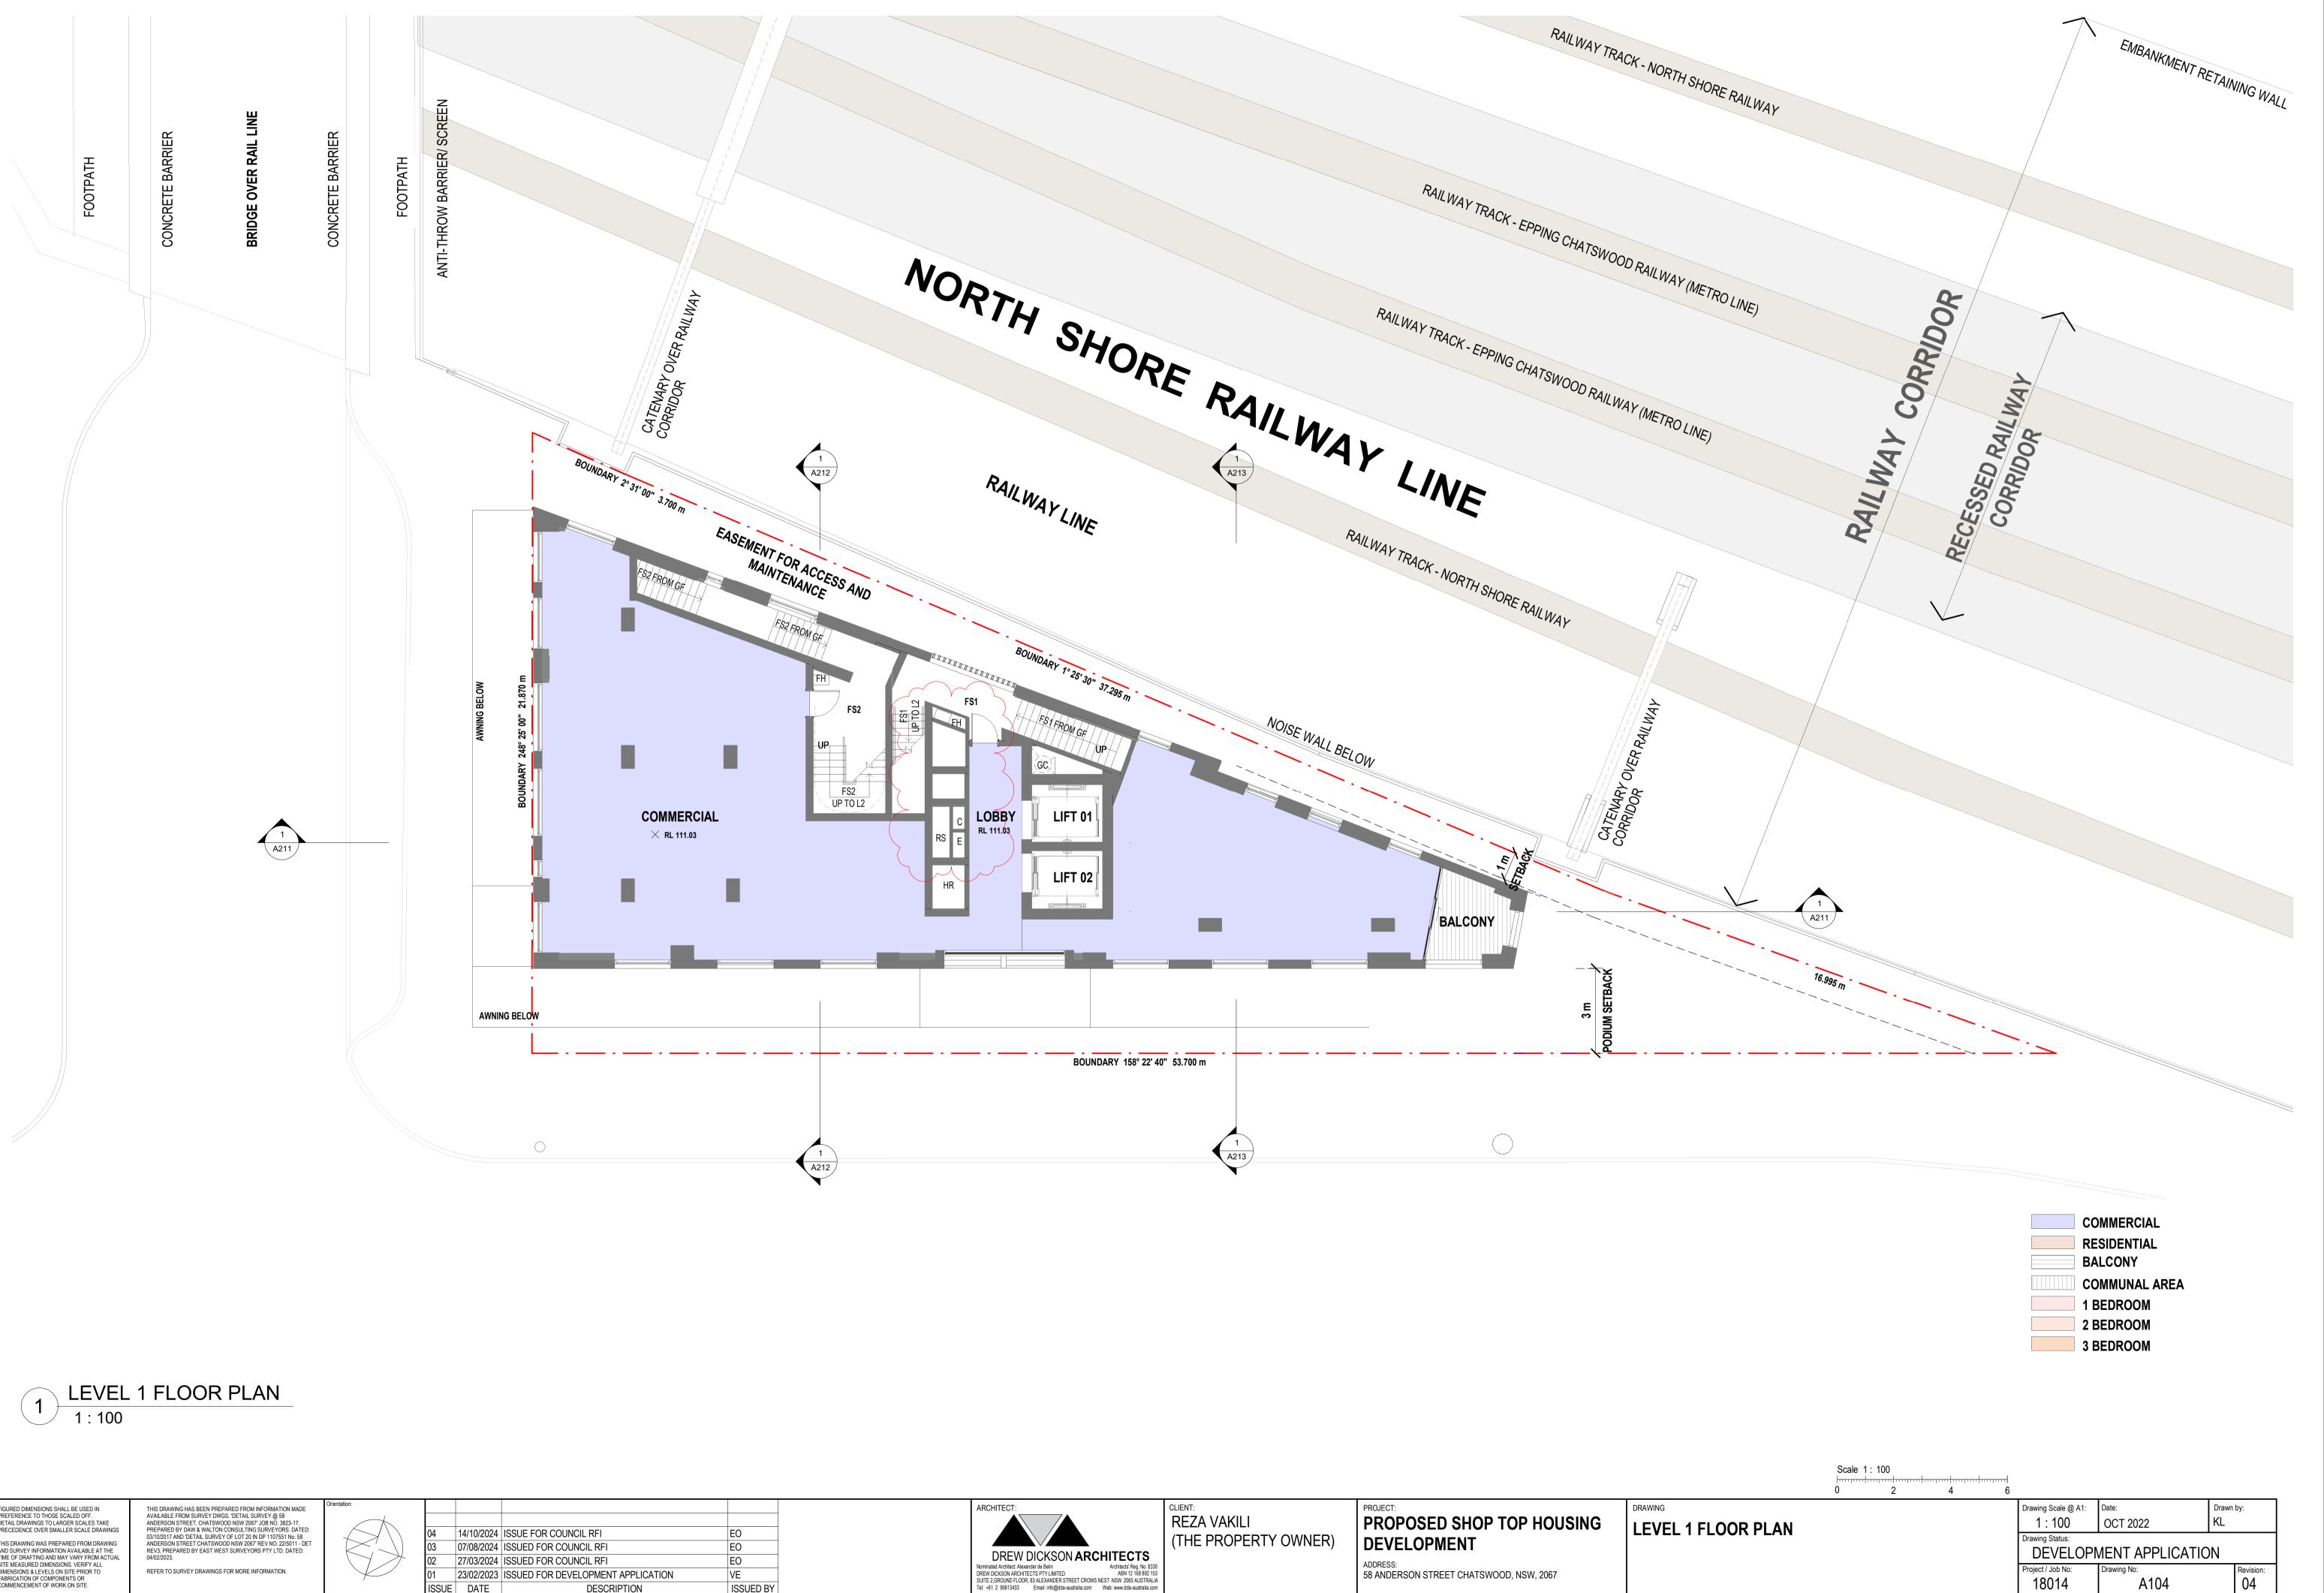



FIGURED DIMENSIONS SHALL BE USED IN PREFERENCE TO THOSE SCALED OFF. DETAIL DRAWINGS TO LARGER SCALES TAKE	THIS DRAWING HAS BEEN PREPARED FROM INFORMATION MADE AVAILABLE FROM SURVEY DWGS. 'DETAIL SURVEY @ 58 ANDERSON STREET. CHATSWOOD NSW 2067' JOB NO. 3823-17.	Orientation:				
PRECEDENCE OVER SMALLER SCALE DRAWINGS	PREPARED BY DAW & WALTON CONSULTING SURVEYORS. DATED: 03/10/2017 AND 'DETAIL SURVEY OF LOT 20 IN DP 1107551 No. 58		04	14/10/2024	ISSUE FOR COUNCIL RFI	EO
THIS DRAWING WAS PREPARED FROM DRAWING AND SURVEY INFORMATION AVAILABLE AT THE	ANDERSON STREET CHATSWOOD NSW 2067' REV NO. 22/5011 - DET REV3, PREPARED BY EAST WEST SURVEYORS PTY LTD. DATED:		03	07/08/2024	ISSUED FOR COUNCIL RFI	EO
TIME OF DRAFTING AND MAY VARY FROM ACTUAL SITE MEASURED DIMENSIONS. VERIFY ALL	04/02/2023.		02	27/03/2024	ISSUED FOR COUNCIL RFI	EO
DIMENSIONS & LEVELS ON SITE PRIOR TO FABRICATION OF COMPONENTS OR	REFER TO SURVEY DRAWINGS FOR MORE INFORMATION.	$\sim$	01	23/02/2023	ISSUED FOR DEVELOPMENT APPLICATION	VE
COMMENCEMENT OF WORK ON SITE.			ISSUE	DATE	DESCRIPTION	ISSUED BY


ARCHITECT: ARCHITECT: DEW DICKSON ARCHITECTS Nominated Architect: Alexander de Belin DREW DICKSON ARCHITECTS PTY LIMITED SUITE 2 GROUND FLOOR, 83 ALEXANDER STREET CROWS NEST NSW 2065 AUSTRALIA Te:: +61 2 90613433 Email: info@dda-australia.com Web: www.dda-australia.com Web: www.dda-au	LEVEL 1 FLOOR
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FIGURED DIMENSIONS SHALL BE USED IN PREFERENCE TO THOSE SCALED OFF. DETAIL DRAWINGS TO LARGER SCALES TAKE	THIS DRAWING HAS BEEN PREPARED FROM INFORMATION MADE AVAILABLE FROM SURVEY DWGS. 'DETAIL SURVEY @ 58 ANDERSON STREET, CHATSWOOD NSW 2067' JOB NO. 3823-17,	Orientation:				
PRECEDENCE OVER SMALLER SCALE DRAWINGS	PREPARED BY DAW & WALTON CONSULTING SURVEYORS. DATED: 03/10/2017 AND 'DETAIL SURVEY OF LOT 20 IN DP 1107551 No. 58		04	14/10/2024	ISSUE FOR COUNCIL RFI	EO
THIS DRAWING WAS PREPARED FROM DRAWING AND SURVEY INFORMATION AVAILABLE AT THE	ANDERSON STREET CHATSWOOD NSW 2067' REV NO. 22/5011 - DET REV3, PREPARED BY EAST WEST SURVEYORS PTY LTD. DATED: 04/02/2023.		03	07/08/2024	ISSUED FOR COUNCIL RFI	EO
TIME OF DRAFTING AND MAY VARY FROM ACTUAL SITE MEASURED DIMENSIONS. VERIFY ALL			02	27/03/2024	ISSUED FOR COUNCIL RFI	EO
DIMENSIONS & LEVELS ON SITE PRIOR TO FABRICATION OF COMPONENTS OR	REFER TO SURVEY DRAWINGS FOR MORE INFORMATION.	$\downarrow$	01	23/02/2023	ISSUED FOR DEVELOPMENT APPLICATION	VE
COMMENCEMENT OF WORK ON SITE.			ISSUE	DATE	DESCRIPTION	ISSUED BY

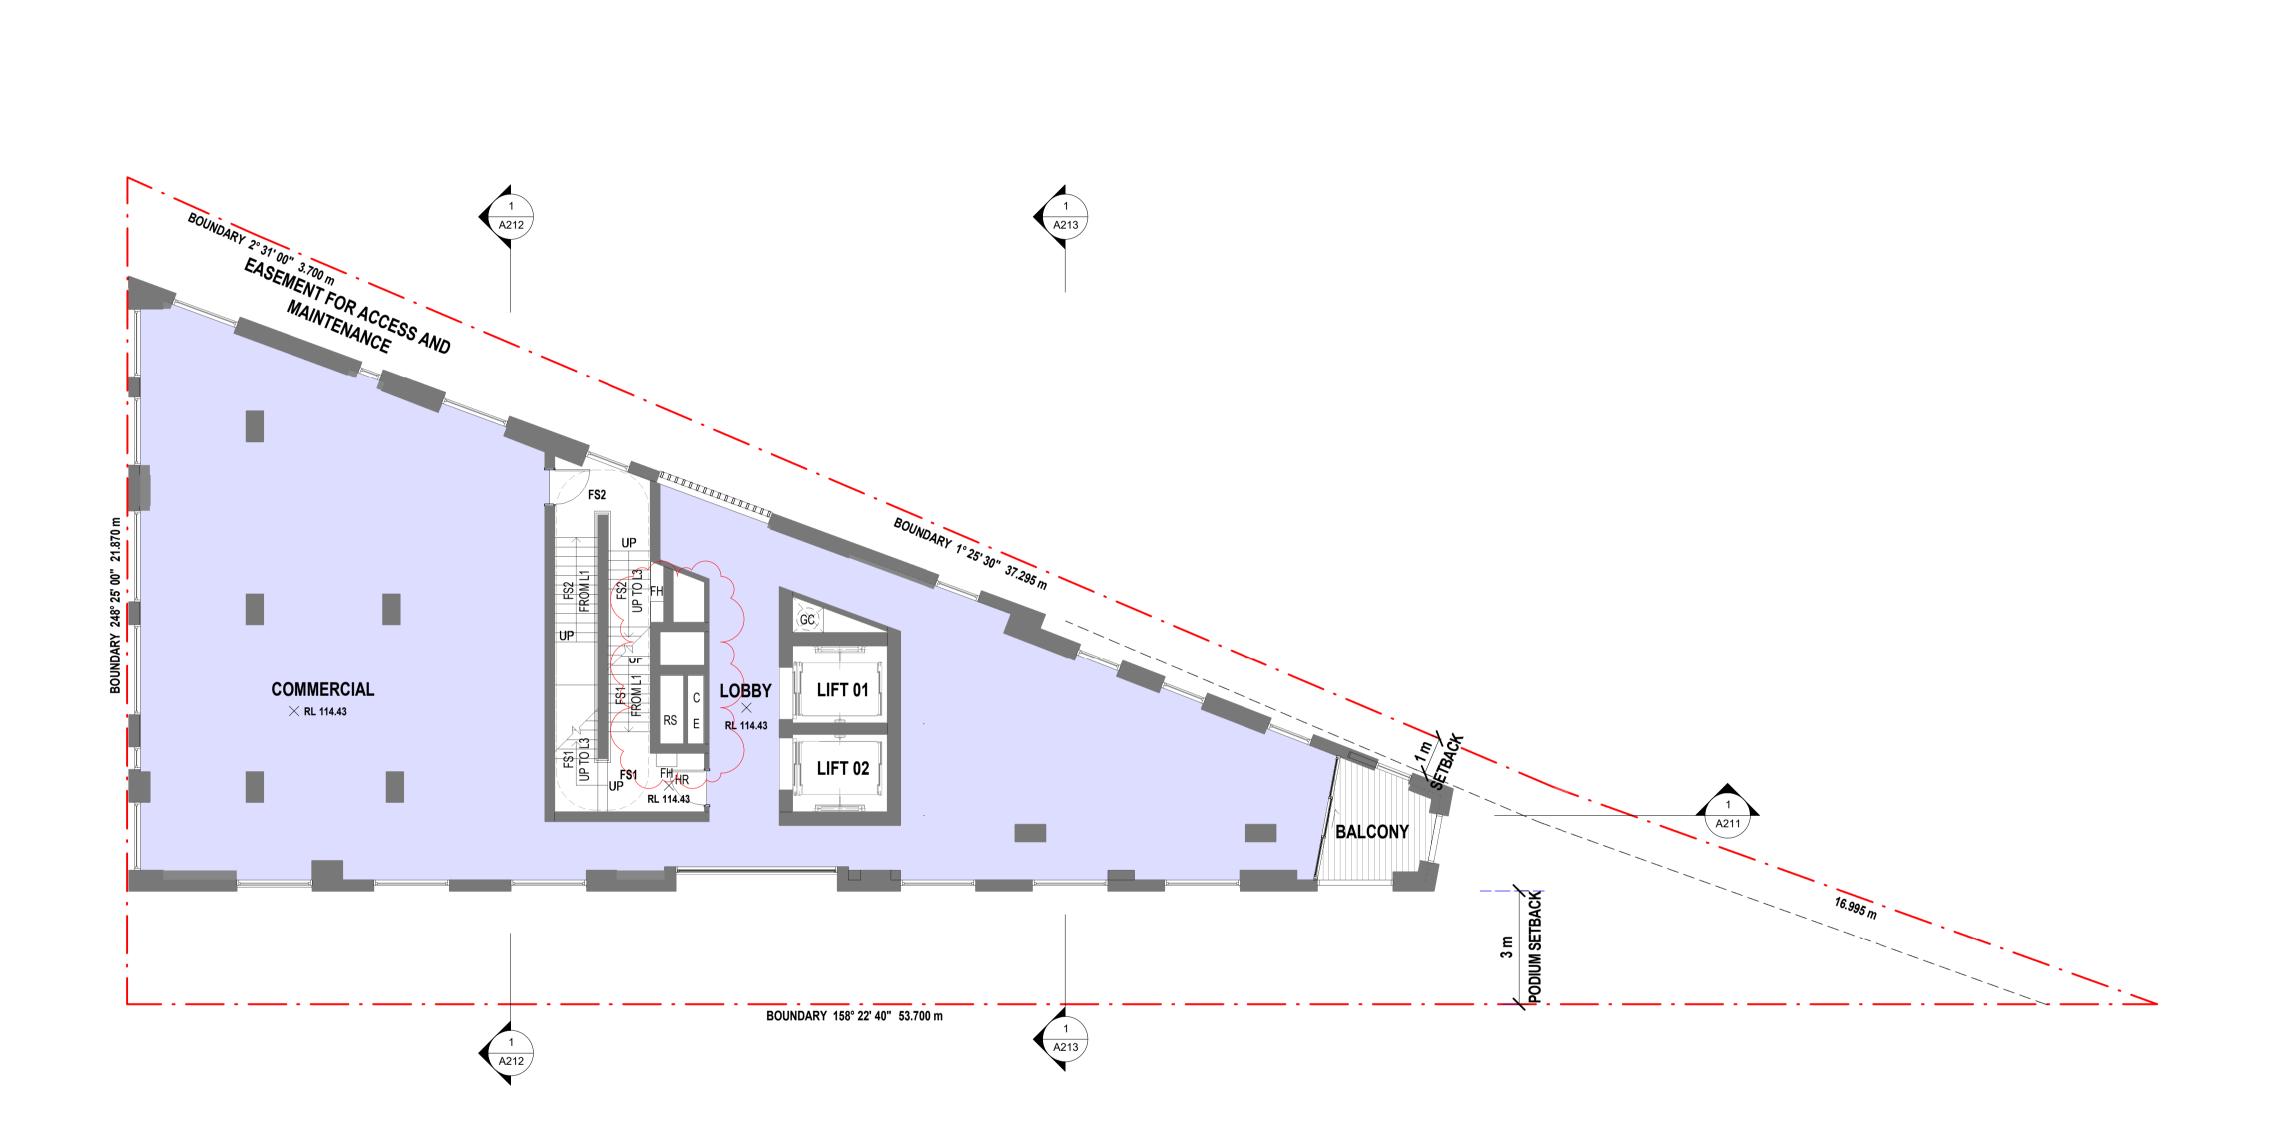





	Scale 1   - 0	: 100 	- 4	 6			
					Drawing Scale @ A1:	Date:	Drawn by:
PLAN					1 : 100	OCT 2022	KL
					Drawing Status:		-
					DEVELOPN	MENT APPLICATIO	)N
					Project / Job No:	Drawing No:	Revision:
					18014	A105	04

FIGURED DIMENSIONS SHALL BE USED IN THIS DRAWING HAS BEEN PREPARED FROM INFORMATION MADE PREFERENCE TO THOSE SCALED OFF. AVAILABLE FROM SURVEY DWGS. DETAIL SURVEY @ 58	Orientation:					
DETAIL DRAWINGS TO LARGER SCALES TAKE ANDERSON STREET, CHATSWOOD NSW 2067' JOB NO. 3823-17,		05	06/12/2024	ADDITIONAL INFORMATION SHOWN	EO	l
PRECEDENCE OVER SMALLER SCALE DRAWINGS PREPARED BY DAW & WALTON CONSULTING SURVEYORS. DATED: 03/10/2017 AND 'DETAIL SURVEY OF LOT 20 IN DP 1107551 No. 58		04	14/10/2024	ISSUE FOR COUNCIL RFI	EO	I
THIS DRAWING WAS PREPARED FROM DRAWING AND SURVEY INFORMATION AVAILABLE AT THE REV3, PREPARED BY EAST WEST SURVEYORS PTY LTD. DATED:		03	07/08/2024	ISSUED FOR COUNCIL RFI	EO	I
TIME OF DRAFTING AND MAY VARY FROM ACTUAL 04/02/2023. SITE MEASURED DIMENSIONS. VERIFY ALL		02	27/03/2024	ISSUED FOR COUNCIL RFI	EO	
DIMENSIONS & LEVELS ON SITE PRIOR TO REFER TO SURVEY DRAWINGS FOR MORE INFORMATION. FABRICATION OF COMPONENTS OR		01	23/02/2023	ISSUED FOR DEVELOPMENT APPLICATION	VE	
COMMENCEMENT OF WORK ON SITE.		ISSUE	DATE	DESCRIPTION	ISSUED BY	

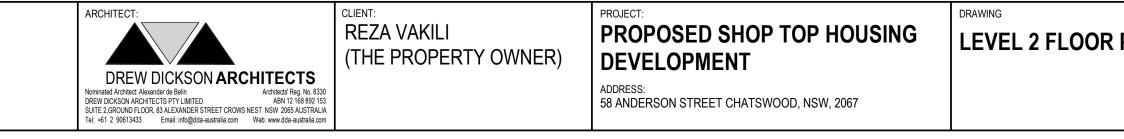


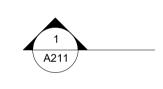

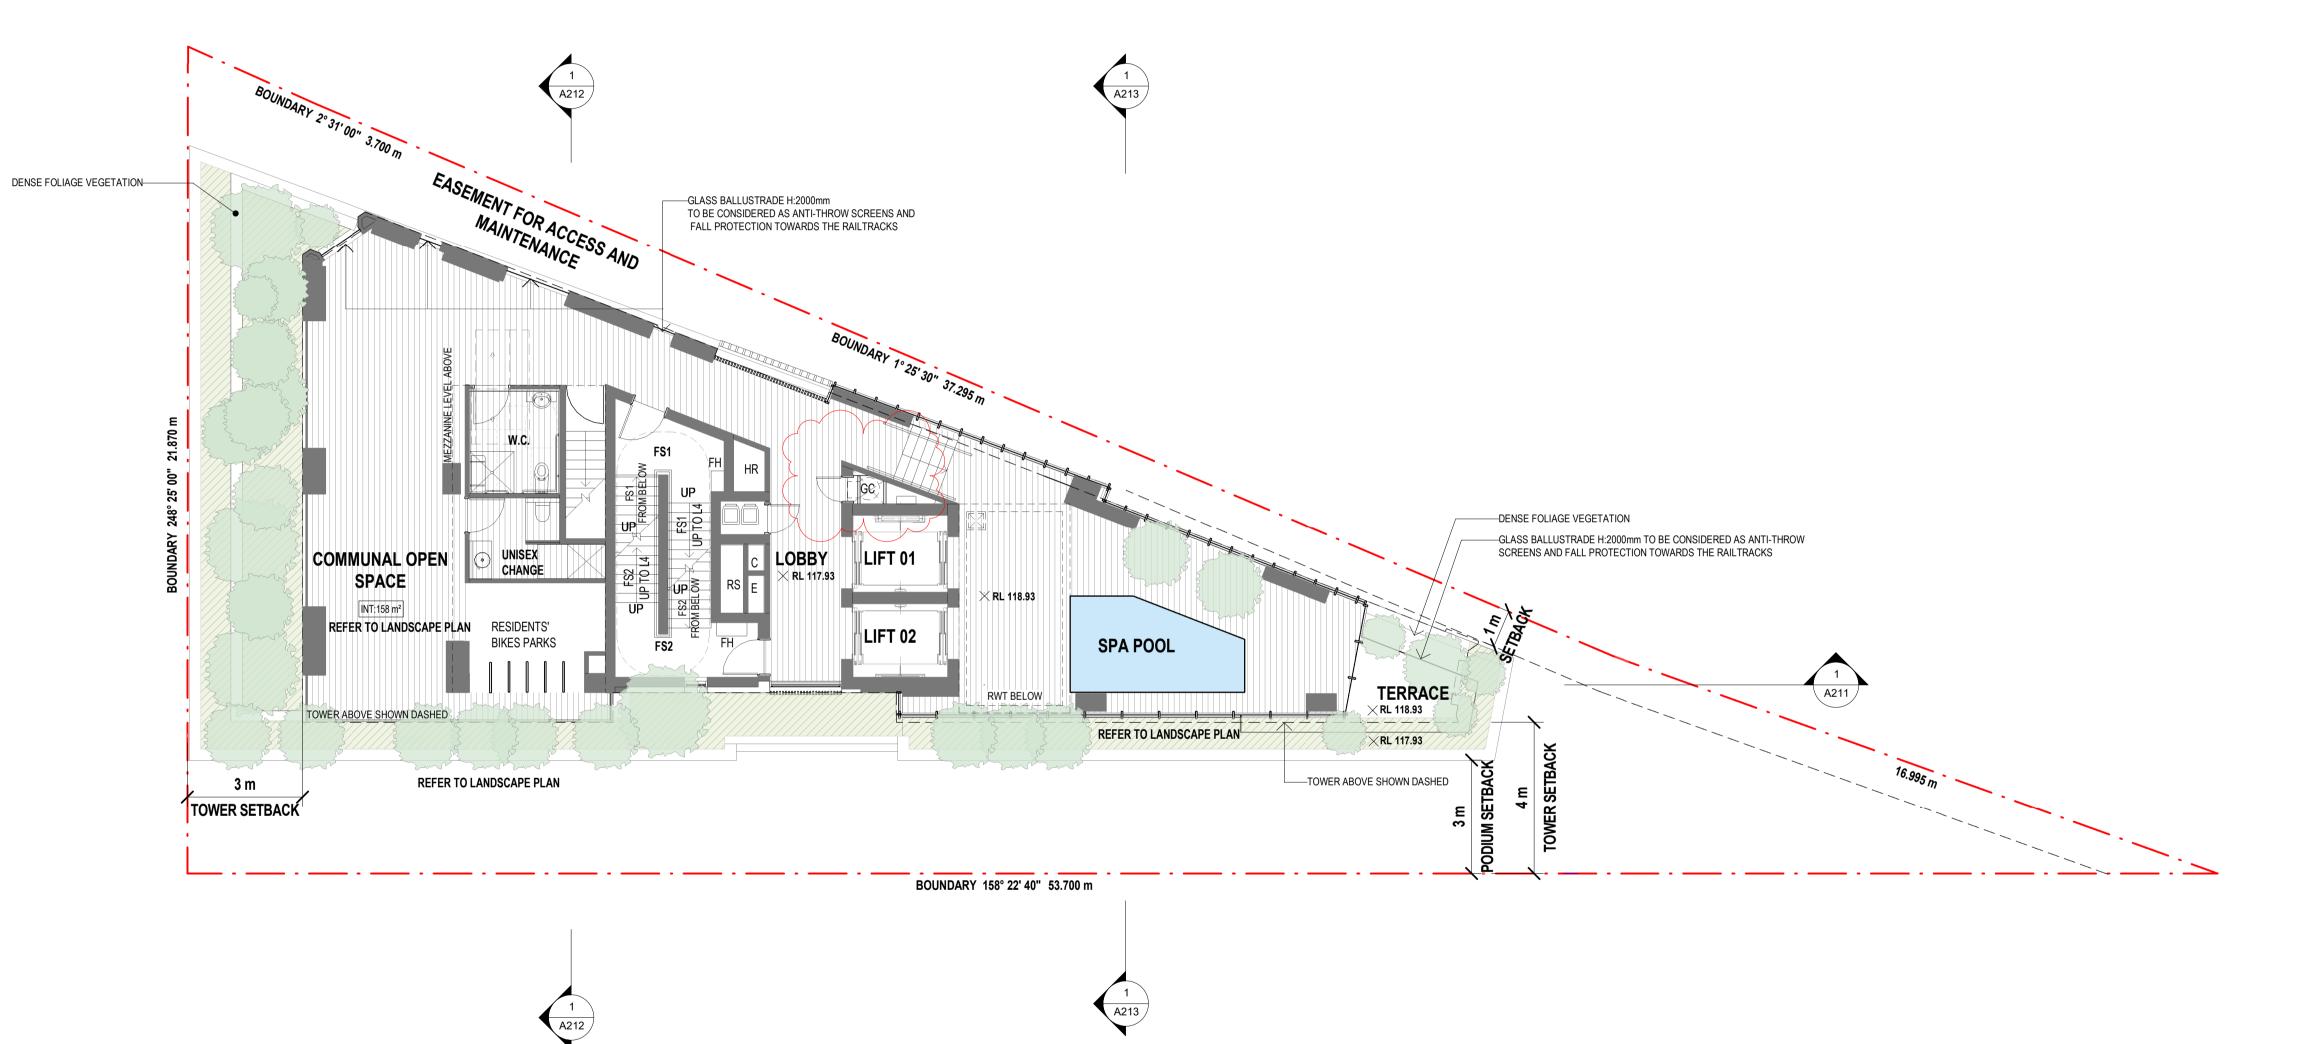


				Scale 1 : 100 			
ARCHITECT: DREW DICKSON ARCHITECTS	CLIENT: REZA VAKILI (THE PROPERTY OWNER)	DEVELOPMENT	DRAWING LEVEL 3 FLOOR PLAN		Drawing Scale @ A1: 1 : 100 Drawing Status: DEVELOPN	Date: OCT 2022 VENT APPLICATIC	Drawn by: KL
Nominated Architect: Alexander de Belin         Architects' Reg. No. 8330           DREW DICKSON ARCHITECTS PTY LIMITED         ABN 12 168 892 153           SUITE 2.GROUND FLOOR, 83 ALEXANDER STREET CROWS NEST NSW 2065 AUSTRALIA         Tel: +61 2 90613433           Tel: +61 2 90613433         Email: info@dda-australia.com		ADDRESS: 58 ANDERSON STREET CHATSWOOD, NSW, 2067			Project / Job No: 18014	Drawing No: A106	Revision: 05



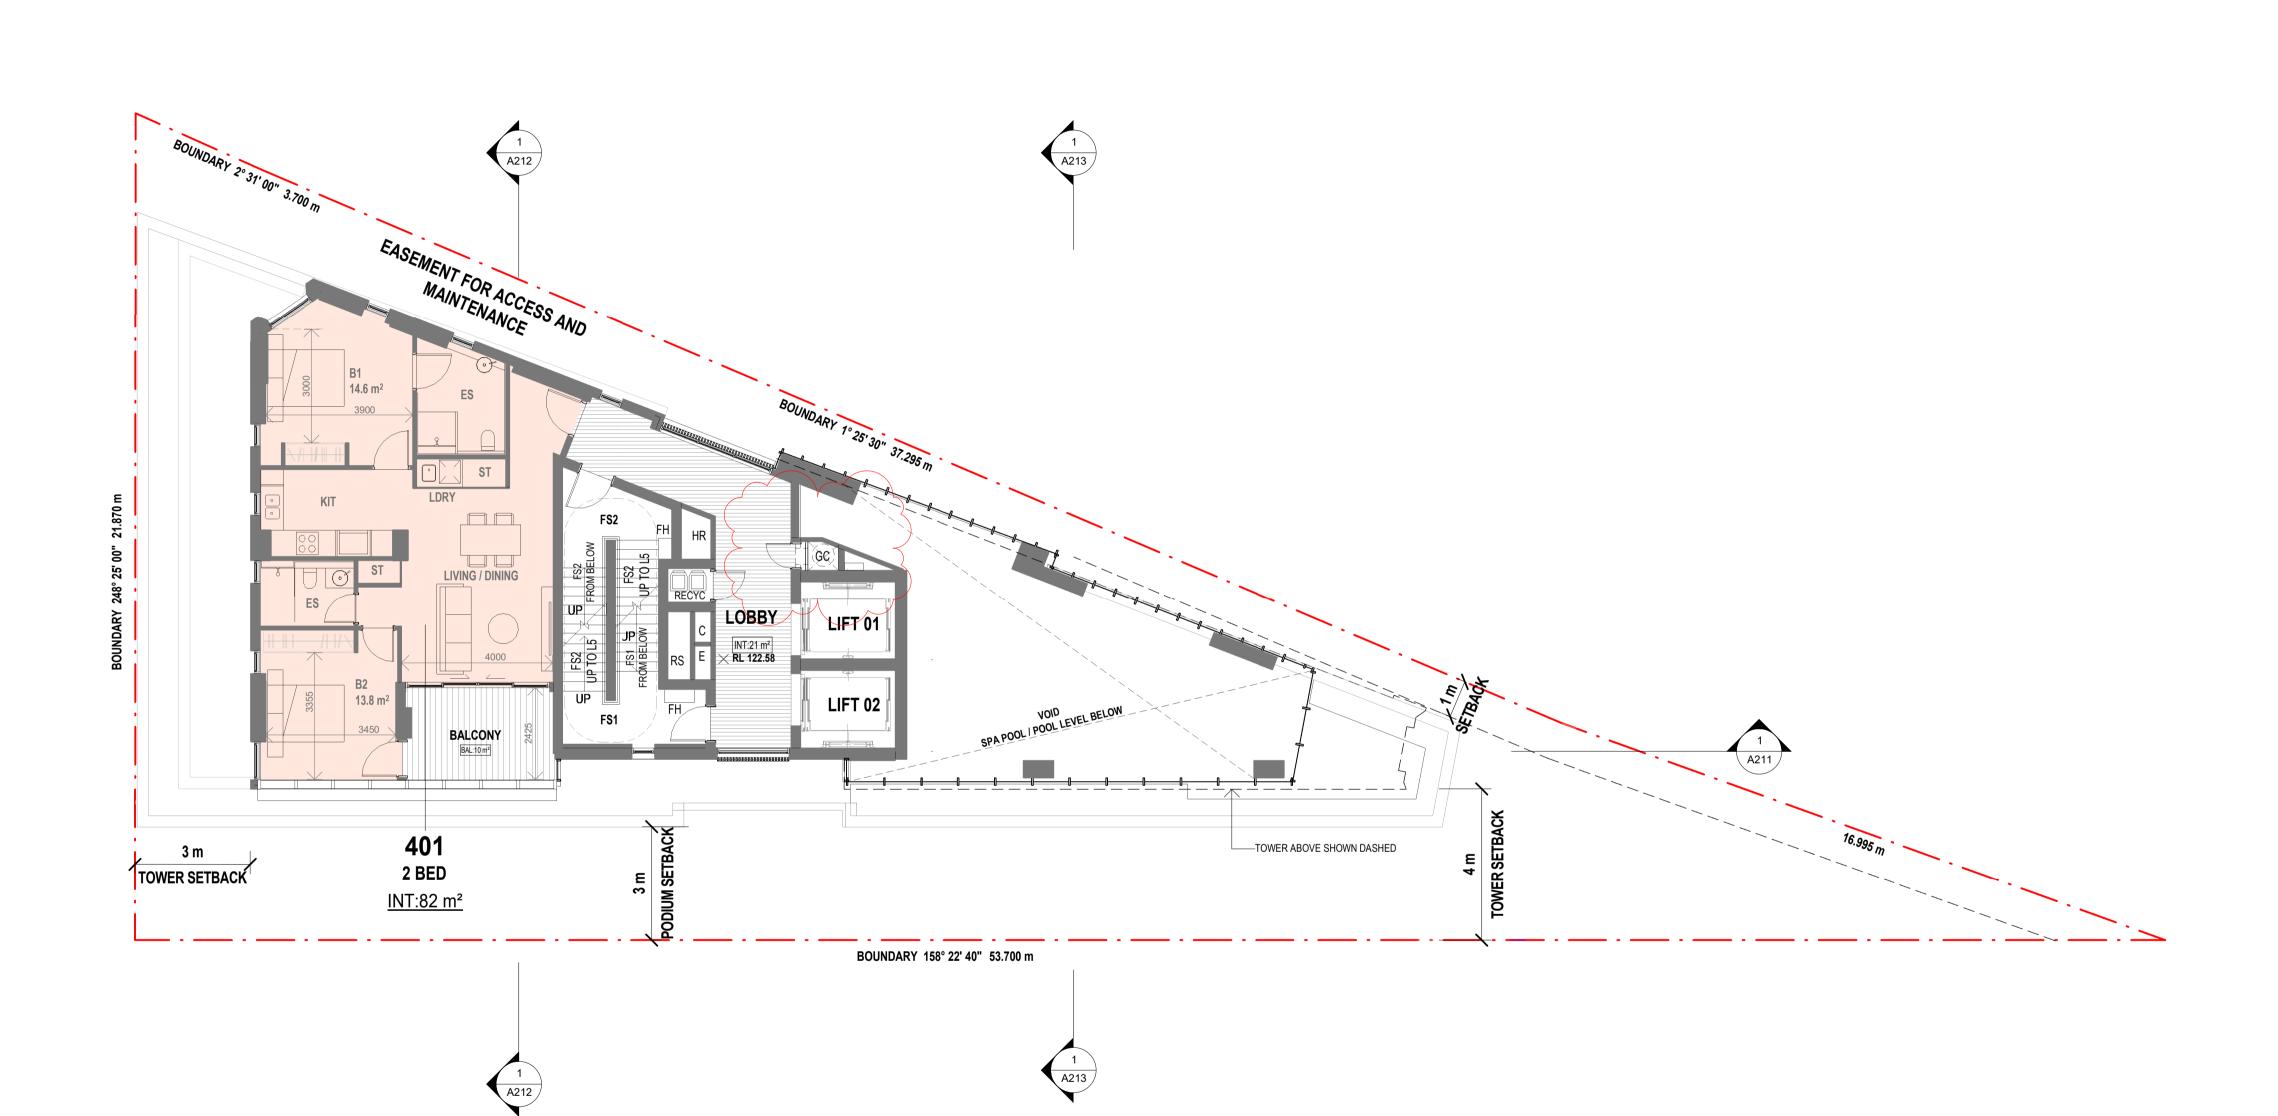




FIGURED DIMENSIONS SHALL BE USED IN	THIS DRAWING HAS BEEN PREPARED FROM INFORMATION MADE	Orientation:				
PREFERENCE TO THOSE SCALED OFF. DETAIL DRAWINGS TO LARGER SCALES TAKE	AVAILABLE FROM SURVEY DWGS. 'DETAIL SURVEY @ 58 ANDERSON STREET, CHATSWOOD NSW 2067' JOB NO. 3823-17,	$\frown$	05	06/12/2024	ADDITIONAL INFORMATION SHOWN	EO
PRECEDENCE OVER SMALLER SCALE DRAWINGS	PREPARED BY DAW & WALTON CONSULTING SURVEYORS. DATED: 03/10/2017 AND 'DETAIL SURVEY OF LOT 20 IN DP 1107551 No. 58		04	14/10/2024	ISSUE FOR COUNCIL RFI	EO
THIS DRAWING WAS PREPARED FROM DRAWING AND SURVEY INFORMATION AVAILABLE AT THE	ANDERSON STREET CHATSWOOD NSW 2067' REV NO. 22/5011 - DET REV3, PREPARED BY EAST WEST SURVEYORS PTY LTD. DATED:		03	07/08/2024	ISSUED FOR COUNCIL RFI	EO
TIME OF DRAFTING AND MAY VARY FROM ACTUAL SITE MEASURED DIMENSIONS. VERIFY ALL	04/02/2023.		02	27/03/2024	ISSUED FOR COUNCIL RFI	EO
DIMENSIONS & LEVELS ON SITE PRIOR TO FABRICATION OF COMPONENTS OR	REFER TO SURVEY DRAWINGS FOR MORE INFORMATION.	$\downarrow$	01	23/02/2023	ISSUED FOR DEVELOPMENT APPLICATION	VE
COMMENCEMENT OF WORK ON SITE.			ISSUE	DATE	DESCRIPTION	ISSUED BY

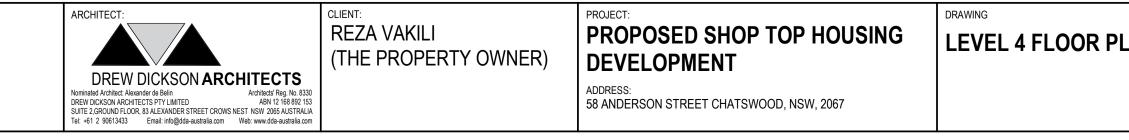

B#	BEDROOM
BA	BATHROOM
ES	ENSUITE BATHROOM
FS#	FIRE STAIR
KIT	KITCHEN
LDRY	LAUNDRY
S	STUDY ROOM
ST	STORAGE
WIR	WALK-IN ROBE



	Scale 1   - 0	1 1			
			Drawing Scale @ A1:	Date:	Drawn by:
PLAN			1 : 100	OCT 2022	KL
			Drawing Status: DEVELOPMENT APPLICATION		
			Project / Job No: 18014	Drawing No: A107	Revision:

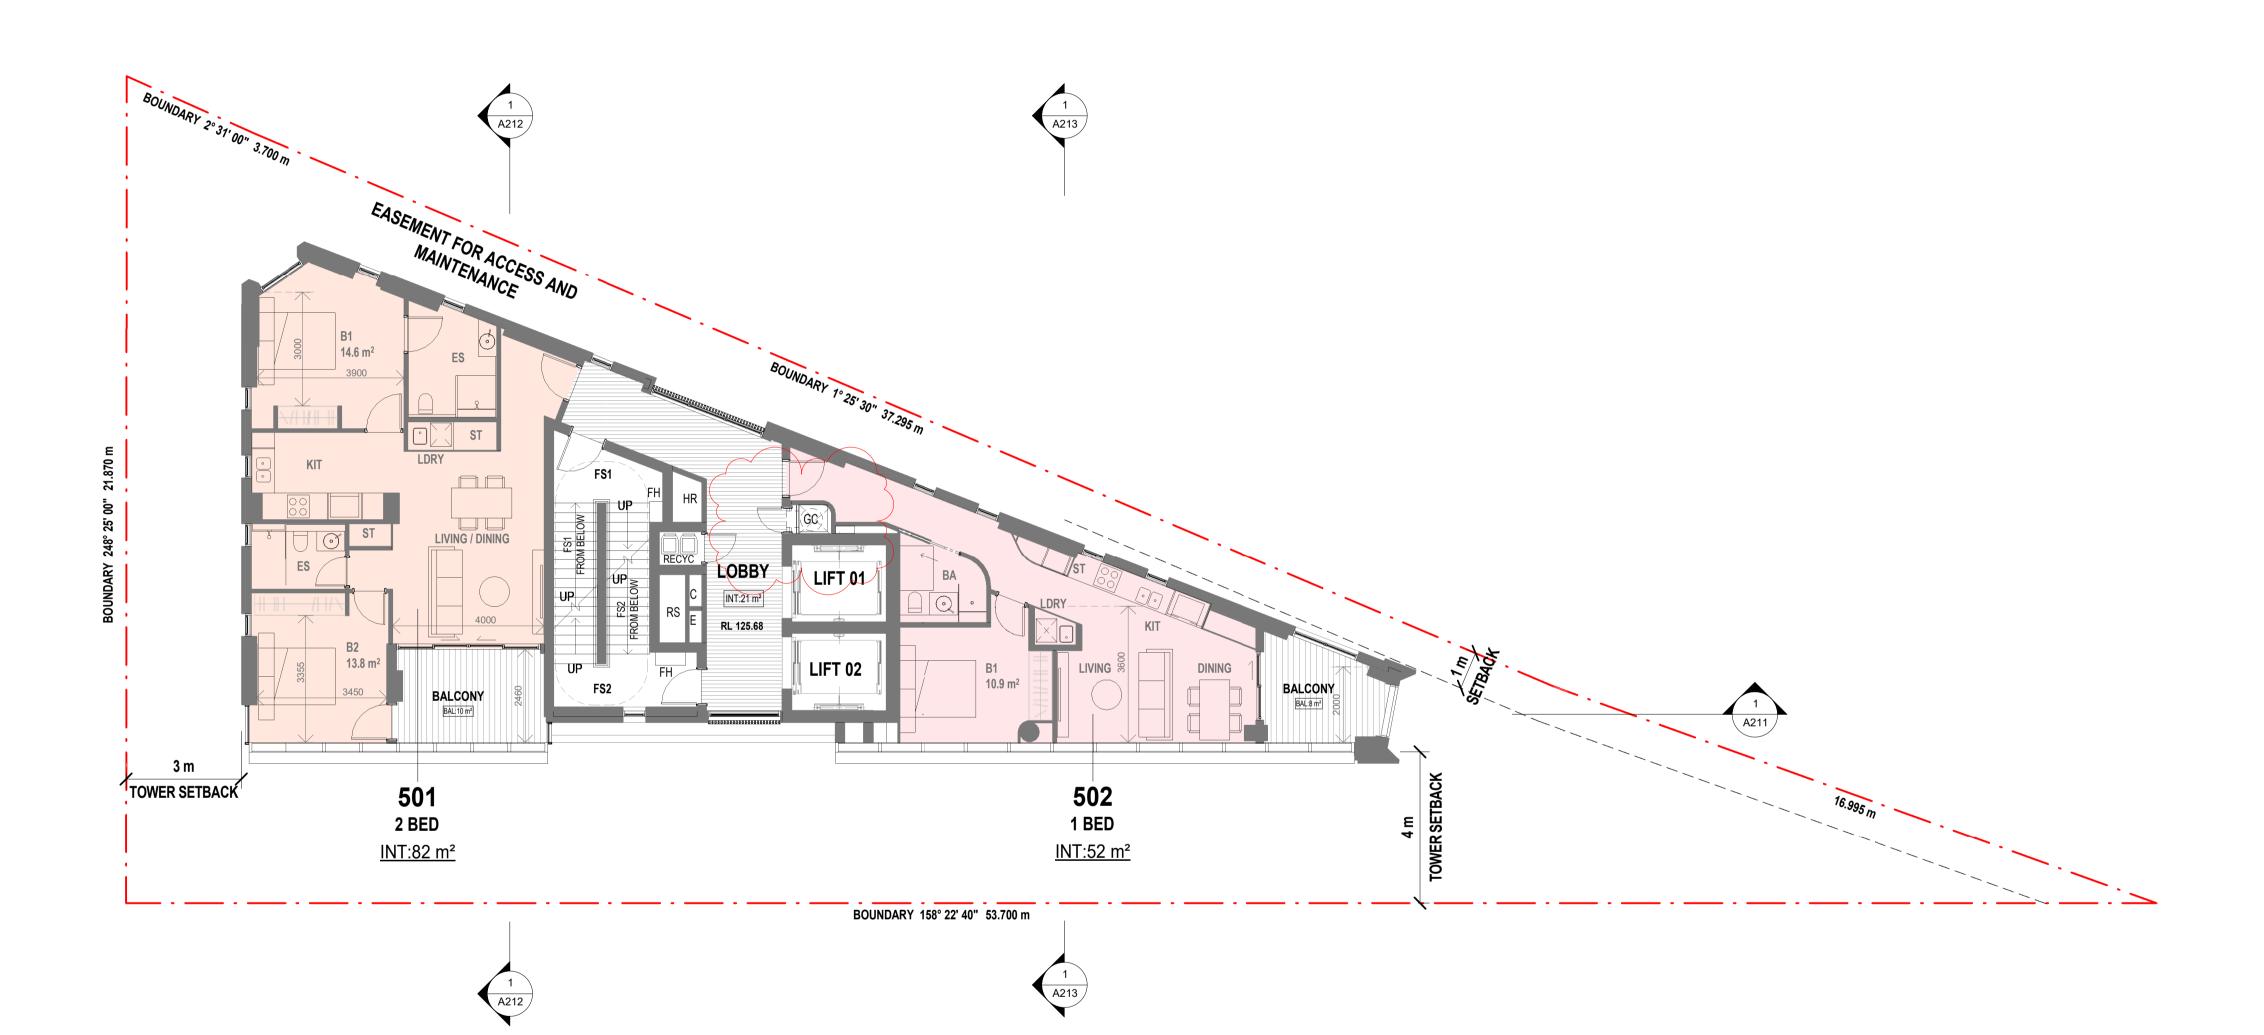




FIGURED DIMENSIONS SHALL BE USED IN	THIS DRAWING HAS BEEN PREPARED FROM INFORMATION MADE	Orientation:				
PREFERENCE TO THOSE SCALED OFF. DETAIL DRAWINGS TO LARGER SCALES TAKE	AVAILABLE FROM SURVEY DWGS. 'DETAIL SURVEY @ 58 ANDERSON STREET, CHATSWOOD NSW 2067' JOB NO. 3823-17,	$\frown$	05	06/12/2024	ADDITIONAL INFORMATION SHOWN	EO
PRECEDENCE OVER SMALLER SCALE DRAWINGS	PREPARED BY DAW & WALTON CONSULTING SURVEYORS. DATED: 03/10/2017 AND 'DETAIL SURVEY OF LOT 20 IN DP 1107551 No. 58		04	14/10/2024	ISSUE FOR COUNCIL RFI	EO
THIS DRAWING WAS PREPARED FROM DRAWING AND SURVEY INFORMATION AVAILABLE AT THE	ANDERSON STREET CHATSWOOD NSW 2067' REV NO. 22/5011 - DET REV3, PREPARED BY EAST WEST SURVEYORS PTY LTD. DATED:		03	07/08/2024	ISSUED FOR COUNCIL RFI	EO
TIME OF DRAFTING AND MAY VARY FROM ACTUAL SITE MEASURED DIMENSIONS. VERIFY ALL	04/02/2023.		02	27/03/2024	ISSUED FOR COUNCIL RFI	EO
DIMENSIONS & LEVELS ON SITE PRIOR TO FABRICATION OF COMPONENTS OR	REFER TO SURVEY DRAWINGS FOR MORE INFORMATION.	$\downarrow$	01	23/02/2023	ISSUED FOR DEVELOPMENT APPLICATION	VE
COMMENCEMENT OF WORK ON SITE.			ISSUE	DATE	DESCRIPTION	ISSUED BY

			Scale 1 : 100 		
ARCHITECT: DREW DICKSON ARCHITECTS DREW DICKSON ARCHITECTS DREW DICKSON ARCHITECTS PTY LIMITED DREW DICKSON ARCHITECTS PTY LIMITED DREW DICKSON ARCHITECTS PTY LIMITED DREW DICKSON ARCHITECTS PTY LIMITED LIMITED DREW DICKSON ARCHITECTS DTY LIMITED DREW DICKSON ARCHITECTS DTY LIMITED LIMITED DREW DICKSON ARCHITECTS DTY LIMITED DREW	CLIENT: REZA VAKILI (THE PROPERTY OWNER)	PROJECT: <b>PROPOSED SHOP TOP HOUSING</b> <b>DEVELOPMENT</b> ADDRESS: 58 ANDERSON STREET CHATSWOOD, NSW, 2067	DRAWING LEVEL 5 - 7 TYPICAL FLOOR PLANS	1:100 Drawing Status:	Drawn by: KL N Revision: 05

B#	BEDROOM
BA	BATHROOM
ES	ENSUITE BATHROOM
FS#	FIRE STAIR
KIT	KITCHEN
LDRY	LAUNDRY
S	STUDY ROOM
ST	STORAGE
WIR	WALK-IN ROBE



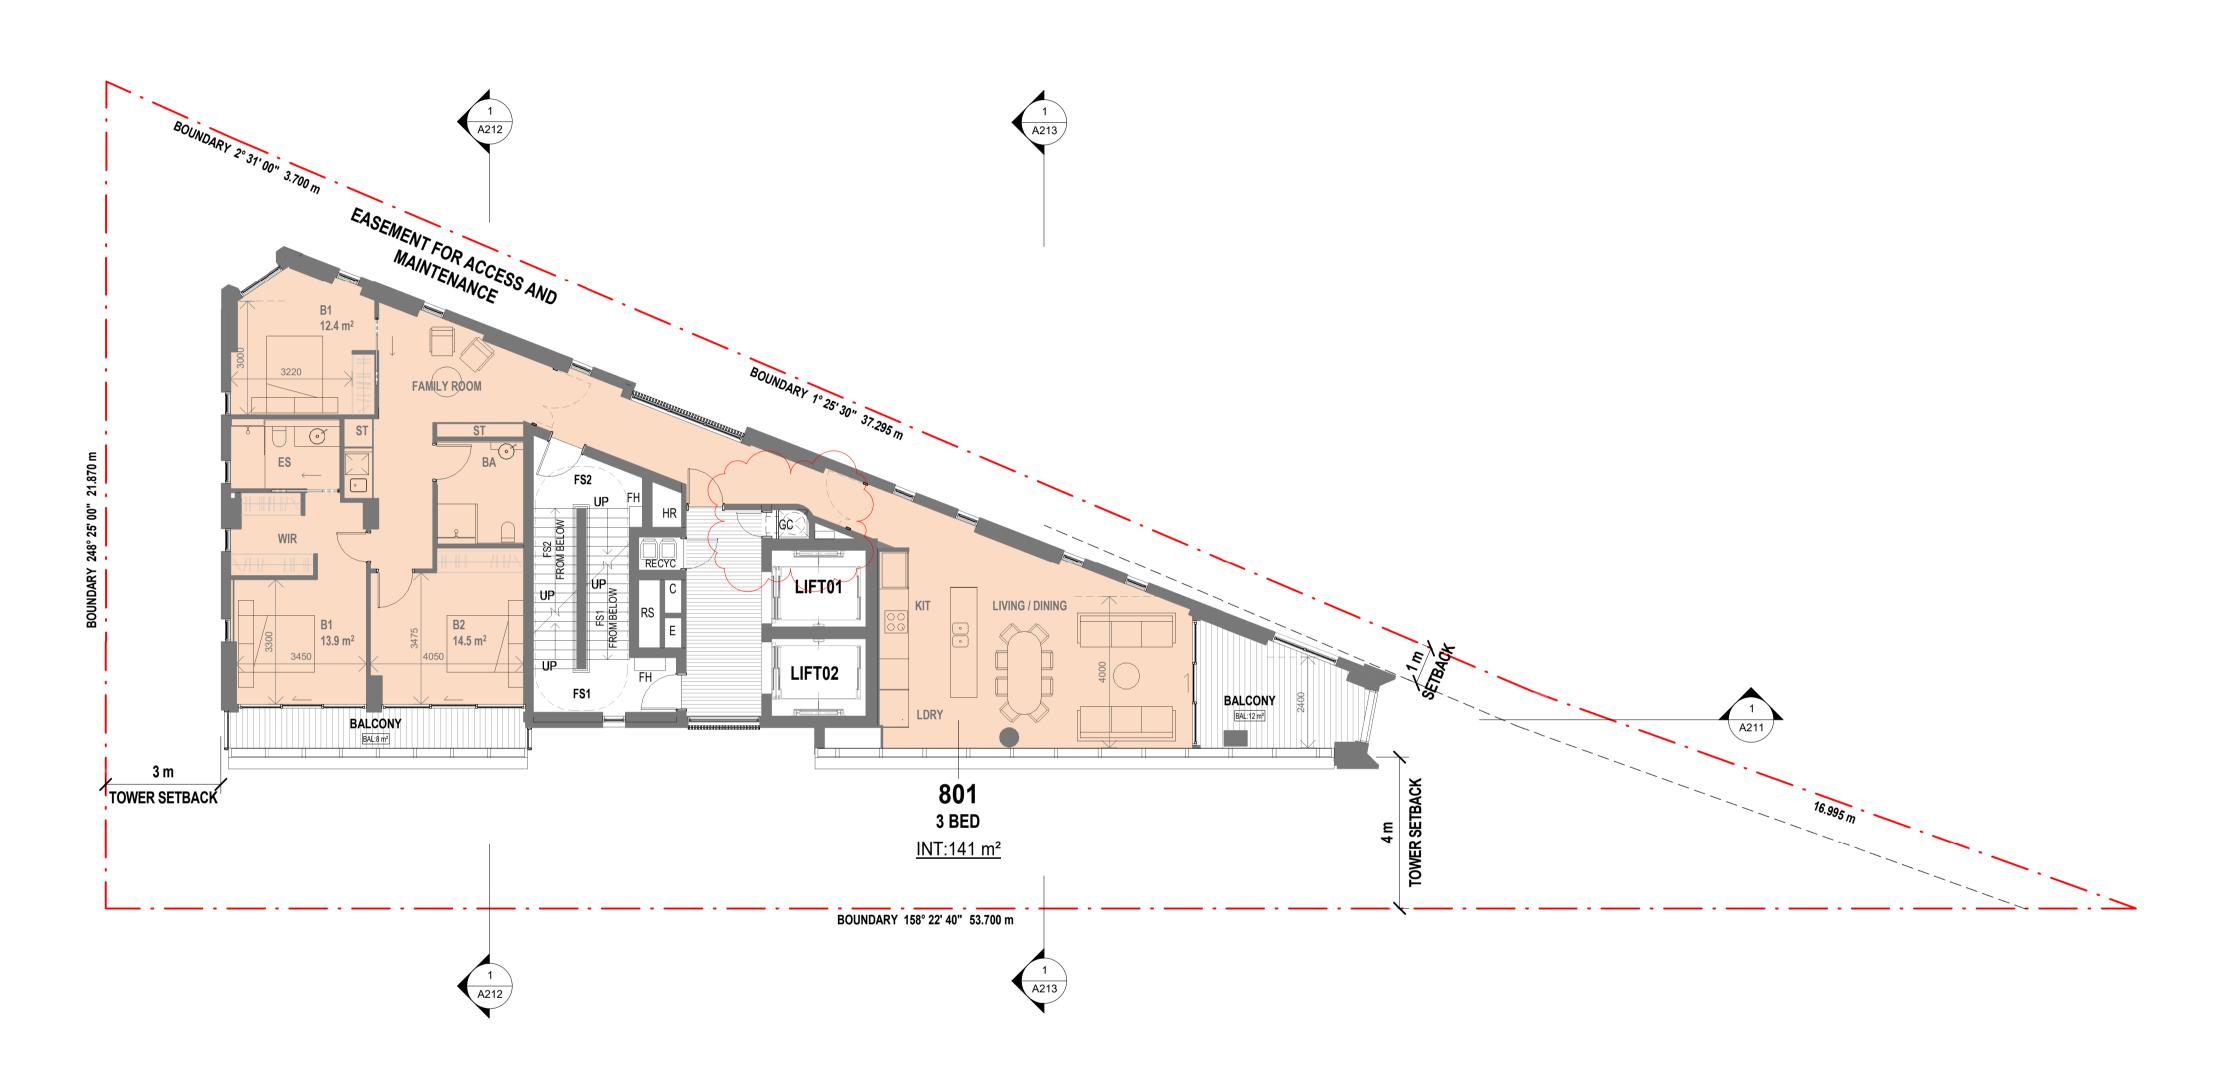

### 1 LEVEL 8-12 FLOOR PLAN 1 : 100


FIGURED DIMENSIONS SHALL BE USED IN PREFERENCE TO THOSE SCALED OFF. DETAIL DRAWINGS TO LARGER SCALES TAKE PRECEDENCE OVER SMALLER SCALE DRAWINGS THIS DRAWING WAS PREPARED FROM DRAWING	THIS DRAWING HAS BEEN PREPARED FROM INFORMATION MADE AVAILABLE FROM SURVEY DWGS. 'DETAIL SURVEY @ 58 ANDERSON STREET, CHATSWOOD NSW 2067' JOB NO. 3823-17, PREPARED BY DAW & WALTON CONSULTING SURVEYORS. DATED: 03/10/2017 AND 'DETAIL SURVEY OF LOT 20 IN DP 1107551 No. 58 ANDERSON STREET CHATSWOOD NSW 2067' REV NO. 22/5011 - DET	04	14/10/2024	ADDITIONAL INFORMATION SHOWN ISSUE FOR COUNCIL RFI	EO EO
THIS DRAWING WAS PREPARED FROM DRAWING AND SURVEY INFORMATION AVAILABLE AT THE TIME OF DRAFTING AND MAY VARY FROM ACTUAL SITE MEASURED DIMENSIONS. VERIFY ALL DIMENSIONS & LEVELS ON SITE PRIOR TO FABRICATION OF COMPONENTS OR	03/10/2017 AND 'DETAIL SURVEY OF LOT 20 IN DP 1107551 No. 58	03 02	07/08/2024 27/03/2024	ISSUE FOR COUNCIL RFI ISSUED FOR COUNCIL RFI ISSUED FOR COUNCIL RFI ISSUED FOR DEVELOPMENT APPLICATION	EO EO EO VE
COMMENCEMENT OF WORK ON SITE.		ISSUE	DATE	DESCRIPTION	ISSUED BY

			Scale 1: 100			
ARCHITECT: DREW DICKSON ARCHITECTS Nominated Architect: Alexander de Belin DREW DICKSON ARCHITECTS PTY LIMITED SUITE 2,GROUND FLOOR, 83 ALEXANDER STREET CROWS NEST NSW 2065 AUSTRALIA Tei: +61 2 90613433 Email: info@dda-australia.com Web: www.dda-australia.com	CLIENT: REZA VAKILI (THE PROPERTY OWNER)	PROJECT: <b>PROPOSED SHOP TOP HOUSING</b> <b>DEVELOPMENT</b> ADDRESS: 58 ANDERSON STREET CHATSWOOD, NSW, 2067	DRAWING LEVEL 8 - 12 TYPICAL FLOOR PLANS	Drawing Scale @ A1: 1 : 100 Drawing Status: DEVELOP Project / Job No: 18014	Date: OCT 2022 VENT APPLICATION Drawing No: A109	Drawn by: KL N Revision: 05

B#	BEDROOM
BA	BATHROOM
ES	ENSUITE BATHROOM
FS#	FIRE STAIR
KIT	KITCHEN
LDRY	LAUNDRY
S	STUDY ROOM
ST	STORAGE
WIR	WALK-IN ROBE




BOUNDARY 248° 25' 00" 21.870 m	BOUNDARY 2° 31' 0	P <sup>T</sup> 3,700 m EASEMENT FOR ACCESSS A S B B B B B B B B B B B B B B B B B B	ST 11.2 m <sup>2</sup> 50 50 50 50 50 50 50 50 50 50
	L		1 A212

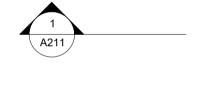



FIGURED DIMENSIONS SHALL BE USED IN	THIS DRAWING HAS BEEN PREPARED FROM INFORMATION MADE	Orientation:				
PREFERENCE TO THOSE SCALED OFF. DETAIL DRAWINGS TO LARGER SCALES TAKE	AVAILABLE FROM SURVEY DWGS. 'DETAIL SURVEY @ 58 ANDERSON STREET, CHATSWOOD NSW 2067' JOB NO. 3823-17,	$\frown$	05	06/12/2024	ADDITIONAL INFORMATION SHOWN	EO
PRECEDENCE OVER SMALLER SCALE DRAWINGS	PREPARED BY DAW & WALTON CONSULTING SURVEYORS. DATED: 03/10/2017 AND 'DETAIL SURVEY OF LOT 20 IN DP 1107551 No. 58		04	14/10/2024	ISSUE FOR COUNCIL RFI	EO
THIS DRAWING WAS PREPARED FROM DRAWING AND SURVEY INFORMATION AVAILABLE AT THE	ANDERSON STREET CHATSWOOD NSW 2067' REV NO. 22/5011 - DET REV3, PREPARED BY EAST WEST SURVEYORS PTY LTD. DATED:	$\left \left\langle \left\langle \left\langle \cdot\right\rangle \right\rangle \right\rangle \right $	03	07/08/2024	ISSUED FOR COUNCIL RFI	EO
TIME OF DRAFTING AND MAY VARY FROM ACTUAL SITE MEASURED DIMENSIONS. VERIFY ALL	04/02/2023.		02	27/03/2024	ISSUED FOR COUNCIL RFI	EO
DIMENSIONS & LEVELS ON SITE PRIOR TO FABRICATION OF COMPONENTS OR	REFER TO SURVEY DRAWINGS FOR MORE INFORMATION.	$\downarrow$	01	23/02/2023	ISSUED FOR DEVELOPMENT APPLICATION	VE
COMMENCEMENT OF WORK ON SITE.			ISSUE	DATE	DESCRIPTION	ISSUED BY

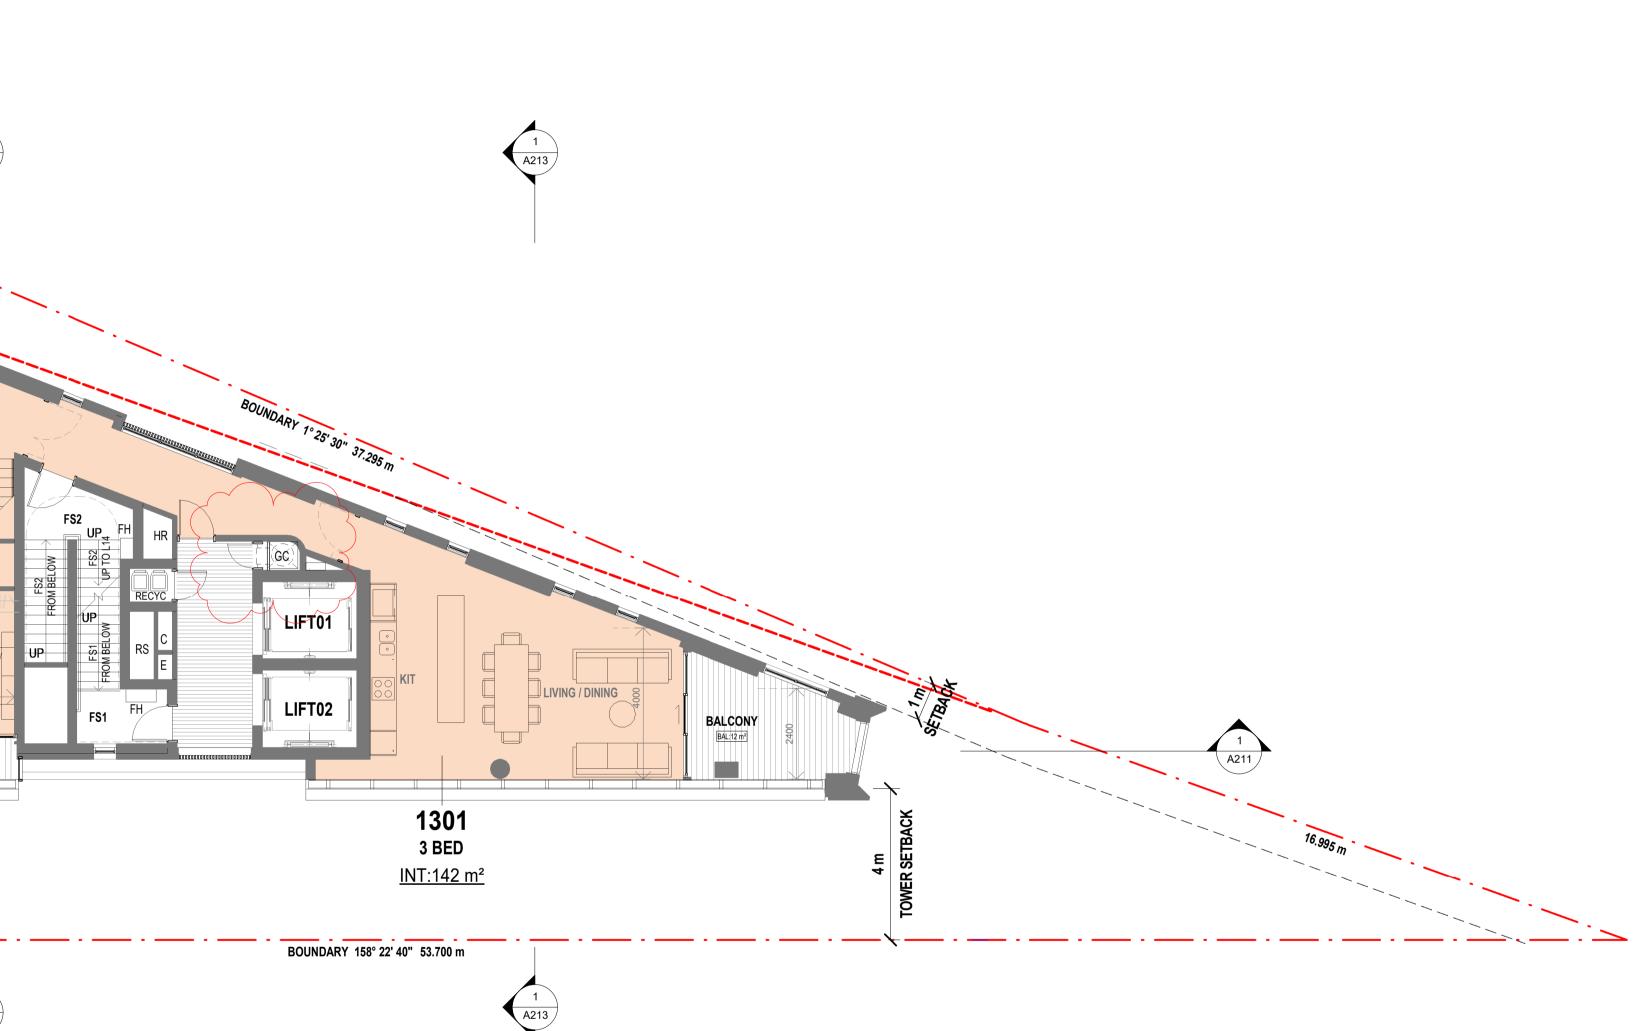


ARCHITECT:	CLIENT:	PROJECT:	DRAWING
	REZA VAKILI	PROPOSED SHOP TOP HOUSING	LEVEL 13 PENTHOU
DREW DICKSON ARCHITECTS Nominated Architect: Alexander de Belin DREW DICKSON ARCHITECTS PTY LIMITED Architects' Reg. No. 8330 ARChitects' Reg. No. 8330 ARCHITECTS PTY LIMITED	(THE PROPERTY OWNER)		
DREW DICKSOW RKCHITECTS PTY LIMITED SUITE 2,GROUND FLOOR, 83 ALEXANDER STREET CROWS NEST NSW 2065 AUSTRALIA Tel: +61 2 90613433 Email: info@dda-australia.com Web: www.dda-australia.com		58 ANDERSON STREET CHATSWOOD, NSW, 2067	

B#	BEDROOM
BA	BATHROOM
ES	ENSUITE BATHROOM
FS#	FIRE STAIR
KIT	KITCHEN
LDRY	LAUNDRY
S	STUDY ROOM
ST	STORAGE
WIR	WALK-IN ROBE




	Scale 1   - 0	1 1	  6				
DUSE				Drawing Scale @ A1: 1:100	Date: OCT 2022	Drawr KL	ı by:
JUOL				Drawing Status: DEVELOPN	MENT APPLICA		
				Project / Job No: 18014	Drawing No: A110		Revision: 05

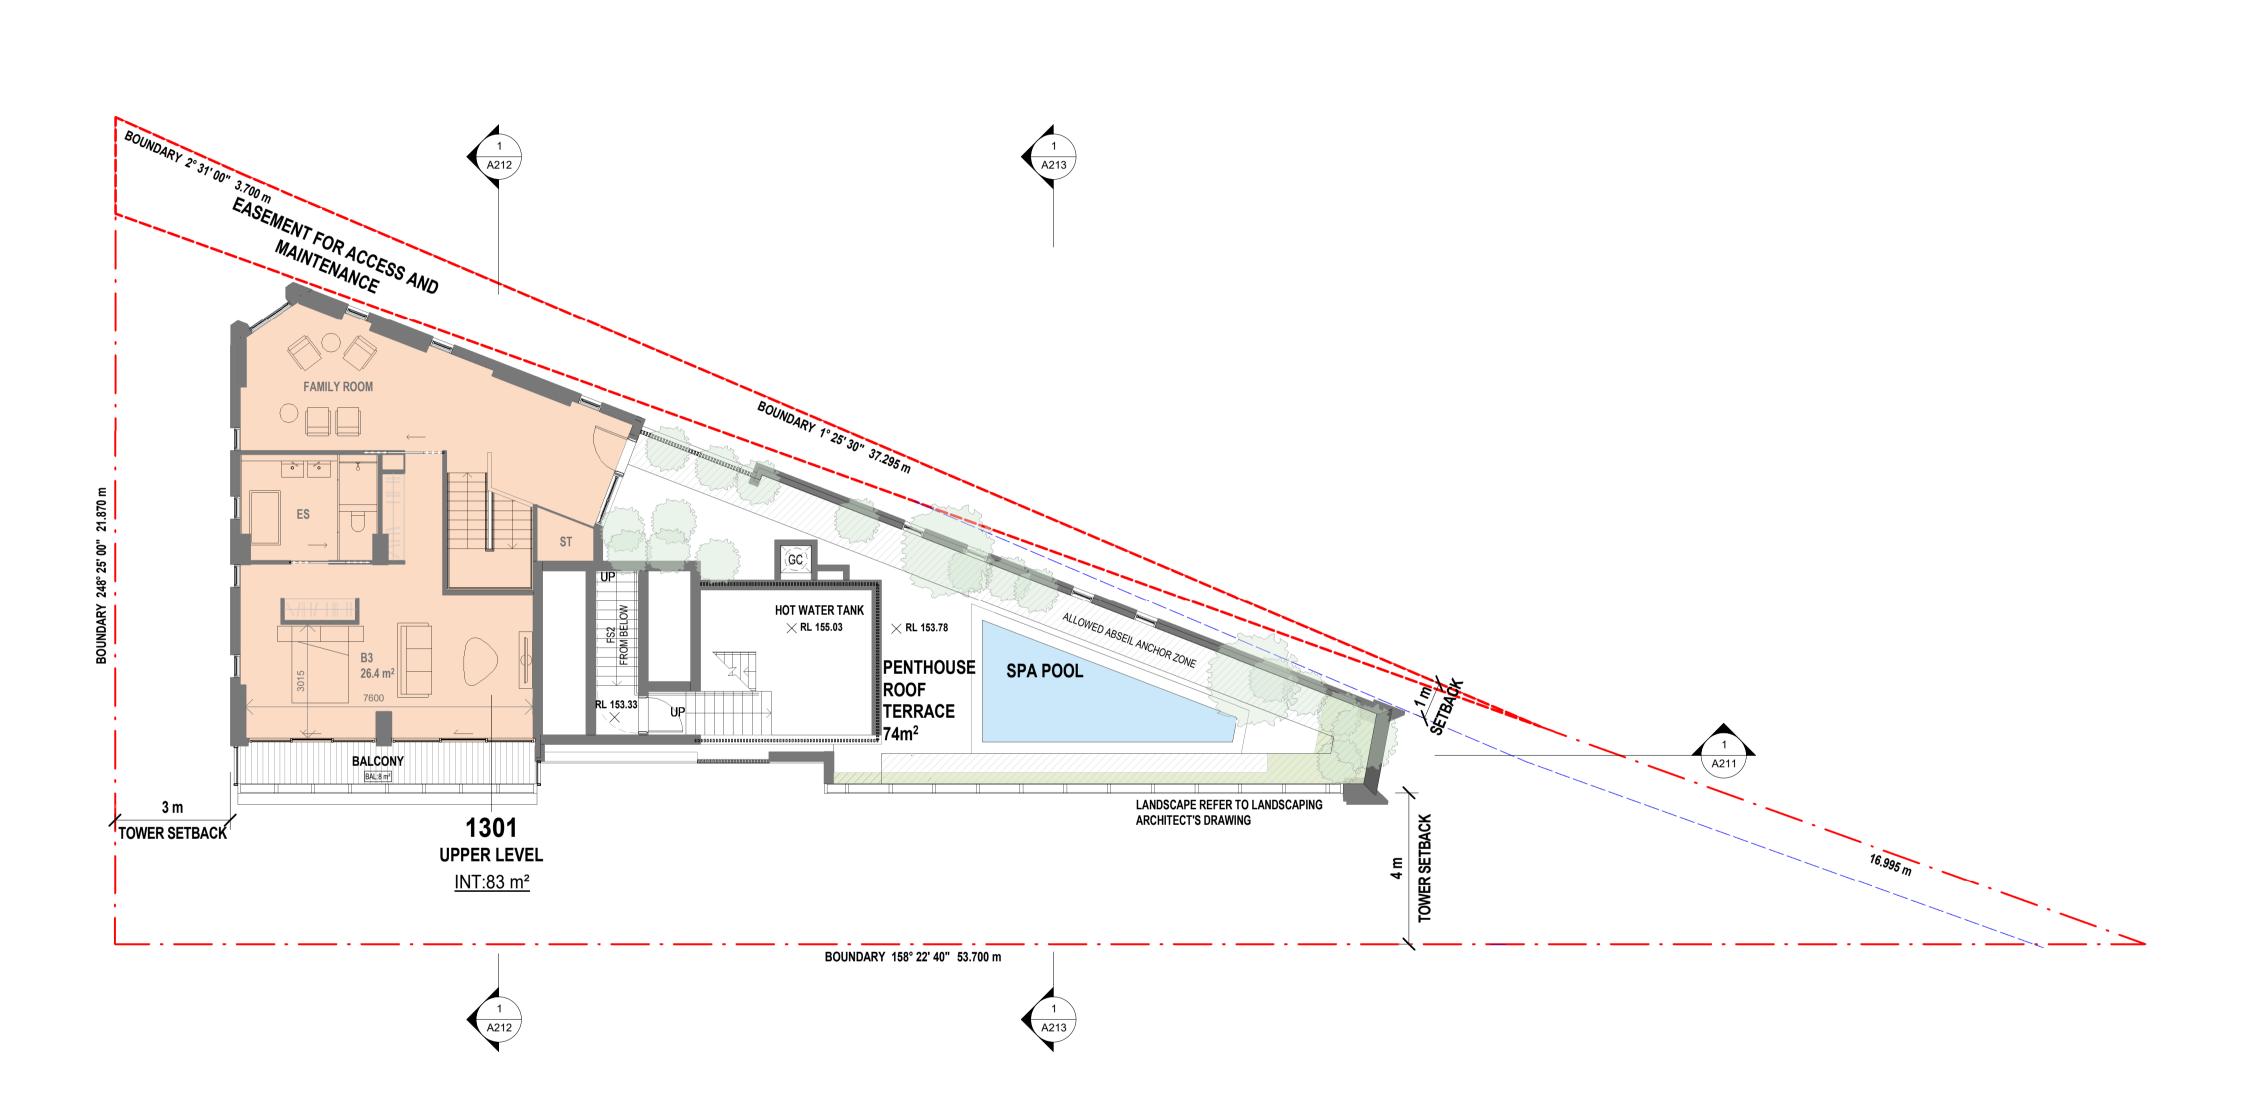




FIGURED DIMENSIONS SHALL BE USED IN THIS DRAWING HAS BEEN PREPARED FROM						
PREFERENCE TO THOSE SCALED OFF. AVAILABLE FROM SURVEY DWGS. 'DETAIL S DETAIL DRAWINGS TO LARGER SCALES TAKE ANDERSON STREET. CHATSWOOD NSW 206						
PRECEDENCE OVER SMALLER SCALE DRAWINGS PRECEDENCE OVER SMALLER SCALE DRAWINGS 03/10/2017 AND 'DETAIL SURVEY OF LOT 20 I	SURVEYORS. DATED:					
THIS DRAWING WAS PREPARED FROM DRAWING AND SURVEY INFORMATION AVAILABLE AT THE REV3, PREPARED BY EAST WEST SURVEYO		03	07/08/2024	ISSUED FOR COUNCIL RFI	EO	
TIME OF DRAFTING AND MAY VARY FROM ACTUAL 04/02/2023. SITE MEASURED DIMENSIONS. VERIFY ALL		02	27/03/2024	ISSUED FOR COUNCIL RFI	EO	
DIMENSIONS & LEVELS ON SITE PRIOR TO REFER TO SURVEY DRAWINGS FOR MORE IN FABRICATION OF COMPONENTS OR	FORMATION.	01	23/02/2023	ISSUED FOR DEVELOPMENT APPLICATION	VE	
COMMENCEMENT OF WORK ON SITE.		ISSUE	DATE	DESCRIPTION	ISSUED BY	

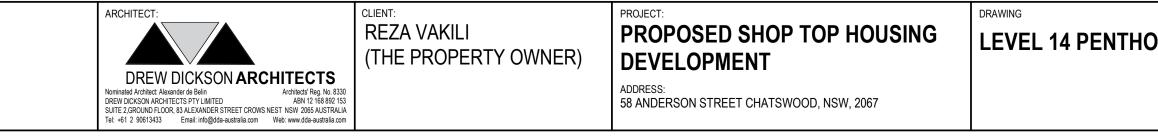


B#	BEDROOM
BA	BATHROOM
ES	ENSUITE BATHROOM
FS#	FIRE STAIR
KIT	KITCHEN
LDRY	LAUNDRY
S	STUDY ROOM
ST	STORAGE
WIR	WALK-IN ROBE



	Scale 1 : <i>*</i>    0	1 1	 l 6			
OUSE				Drawing Scale @ A1: 1:100	Date: OCT 2022	Drawn by: KL
OUUL				Drawing Status: DEVELOPMENT APPLICATION		
				Project / Job No: 18014	Drawing No: A111	Revision:

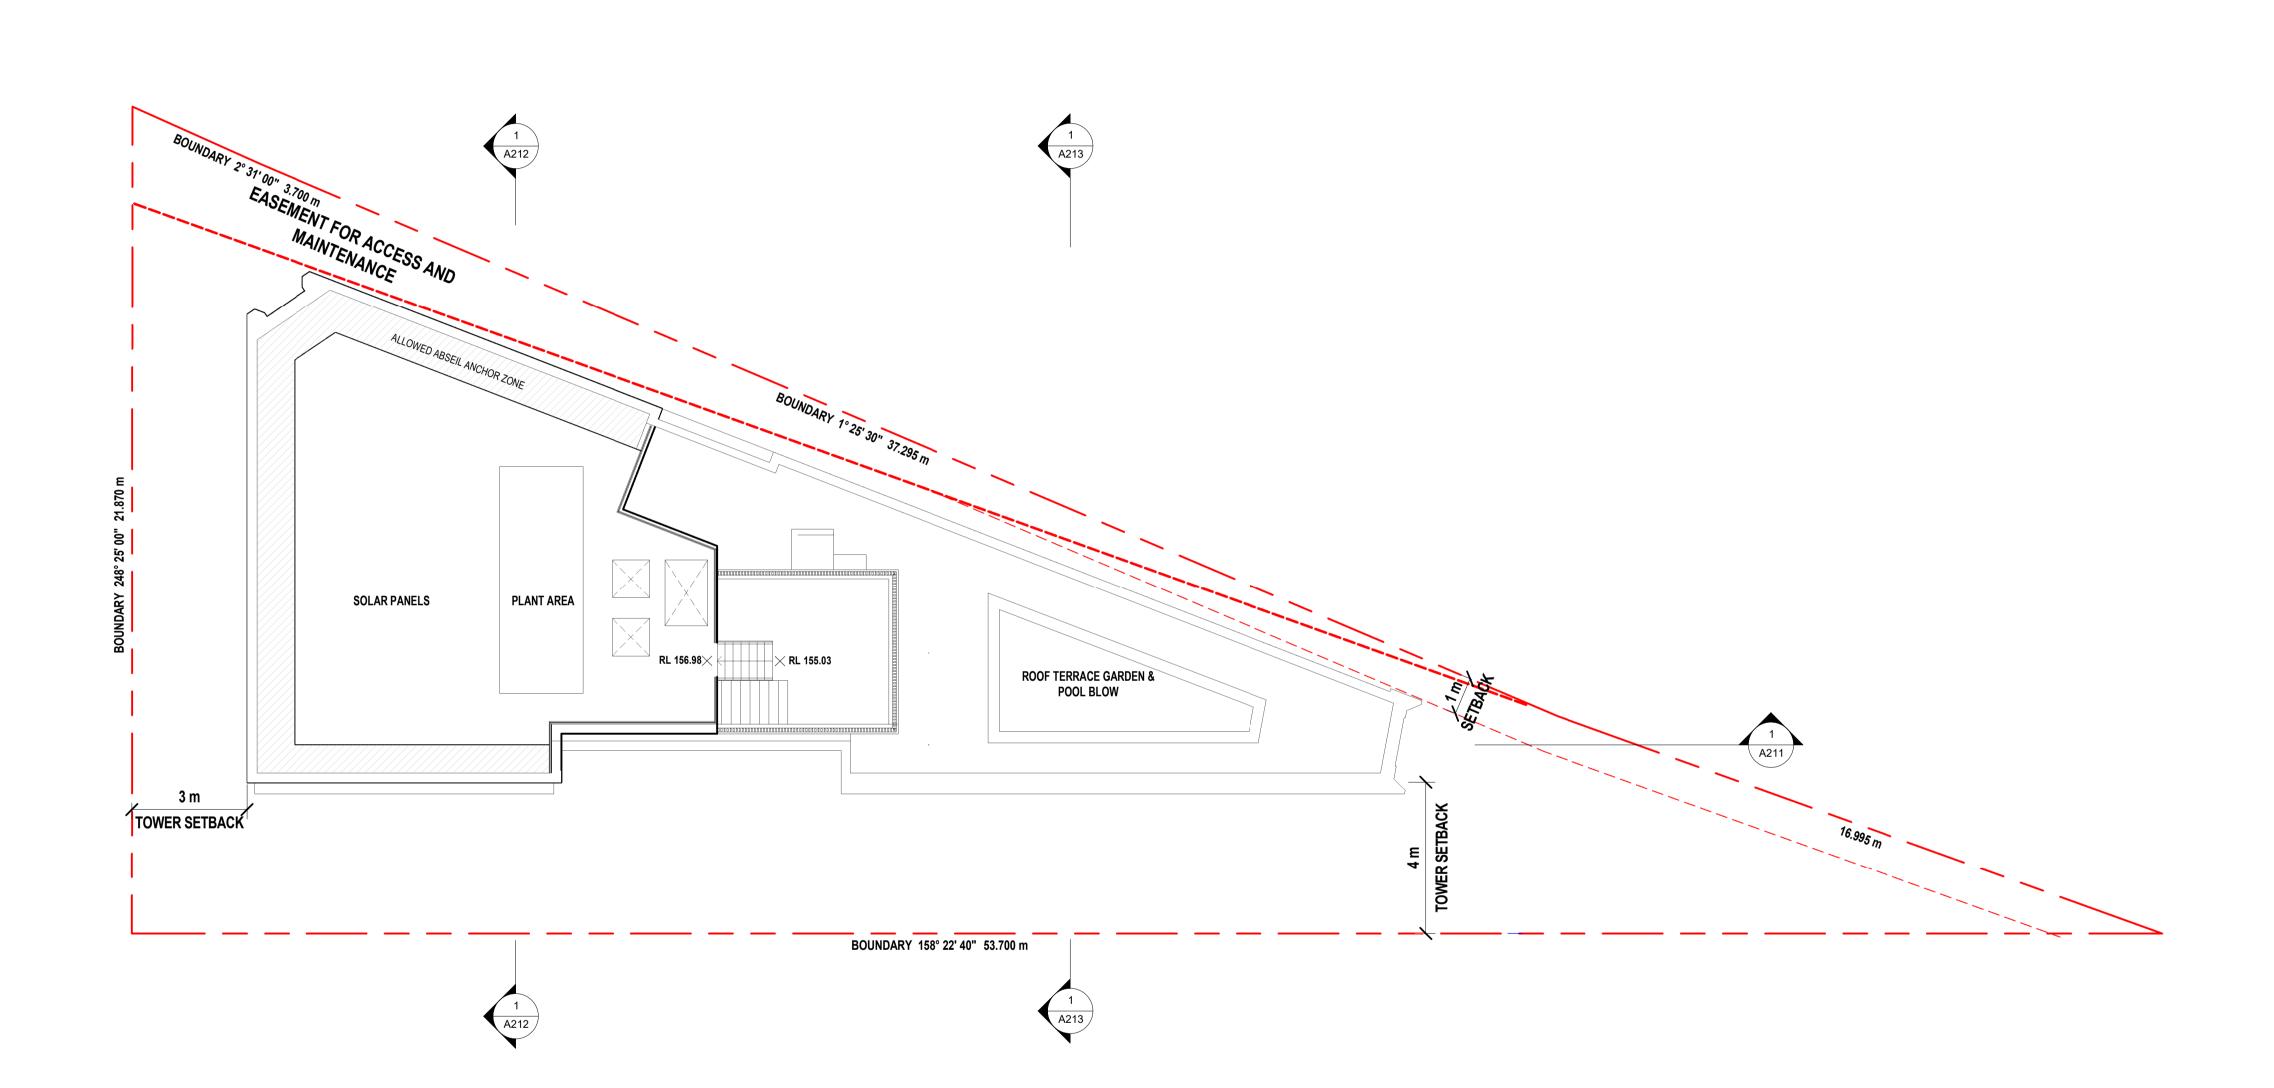

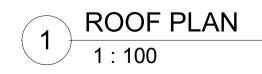


PREFERENCE TO THOSE SCALED OFF. AVA DETAIL DRAWINGS TO LARGER SCALES TAKE AND	IS DRAWING HAS BEEN PREPARED FROM INFORMATION MADE AILABLE FROM SURVEY DWGS. 'DETAIL SURVEY @ 58 IDERSON STREET, CHATSWOOD NSW 2067' JOB NO. 3823-17,	Drientation:					
03/11 THIS DRAWING WAS PREPARED FROM DRAWING AND	XEPARED BY DAW & WALTON CONSULTING SURVEYORS. DATED: /10/2017 AND 'DETAIL SURVEY OF LOT 20 IN DP 1107551 No. 58 IDERSON STREET CHATSWOOD NSW 2067' REV NO. 22/5011 - DET EV3, PREPARED BY EAST WEST SURVEYORS PTY LTD. DATED:		03	07/08/2024	ISSUED FOR COUNCIL RFI	EO	
TIME OF DRAFTING AND MAY VARY FROM ACTUAL 04/03 SITE MEASURED DIMENSIONS. VERIFY ALL	/02/2023.		02	27/03/2024	ISSUED FOR COUNCIL RFI	EO	
DIMENSIONS & LEVELS ON SITE PRIOR TO REF FABRICATION OF COMPONENTS OR	FER TO SURVEY DRAWINGS FOR MORE INFORMATION.		01	23/02/2023	ISSUED FOR DEVELOPMENT APPLICATION	VE	
COMMENCEMENT OF WORK ON SITE.			ISSUE	DATE	DESCRIPTION	ISSUED BY	

1 A211


ARCHITECT:	CLIENT:	PROJECT:	DRAWING
	REZA VAKILI	PROPOSED SHOP TOP HOUSING	ROOF PLAN
	(THE PROPERTY OWNER)	DEVELOPMENT	
DREW DICKSON ARCHITECTS Nominated Architect: Alexander de Belin Architects Reg. No. 8330 DREW DICKSON ARCHITECTS PTY LIMITED ABN 12 168 892 153 SUITE 2,GROUND FLOOR, 83 ALEXANDER STREET CROWS NEST NSW 2065 AUSTRALIA Tel: +61 2 90613433 Email: info@dda-australia.com Web: www.dda-australia.com	, , , , , , , , , , , , , , , , , , ,	ADDRESS: 58 ANDERSON STREET CHATSWOOD, NSW, 2067	

Drawing Scale @ A1: 1:100	Date: OCT 2022	Drawn by: KL		
Drawing Status: DEVELOPMENT APPLICATION				
Project / Job No: 18014	Drawing No: A112	Revision:		

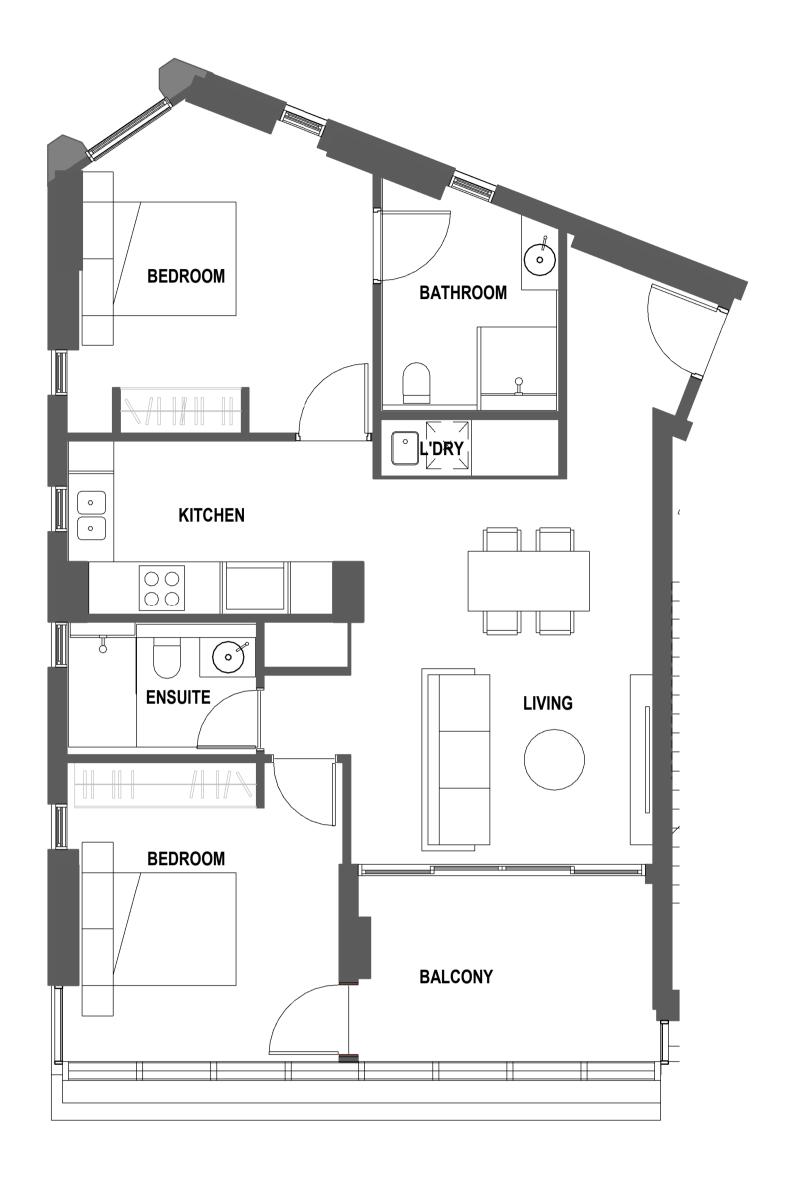

1 PRE -ADAPTABLE UNIT 501 (601,701) 1 : 50

DETAIL DRAWINGS TO LARGER SCALES TAKE PRECEDENCE OVER SMALLER SCALE DRAWINGS THIS DRAWING WAS PREPARED FROM DRAWING AND SURVEY INFORMATION AVAILABLE AT THE TIME OF DRAFTING AND MAY VARY FROM ACTUAL SITE MEASURED DIMENSIONS. VERIEY ALL DIMENSIONS & LEVELS ON SITE PRIOR TO FABBRICATION OF COMPONENTS OR COMMENCEMENT OF WORK ON SITE.	T0307/08/2024ISSUED FOR COUNCIL RFIEO0227/03/2024ISSUED FOR COUNCIL RFIEO0123/02/2023ISSUED FOR DEVELOPMENT APPLICATIONVE
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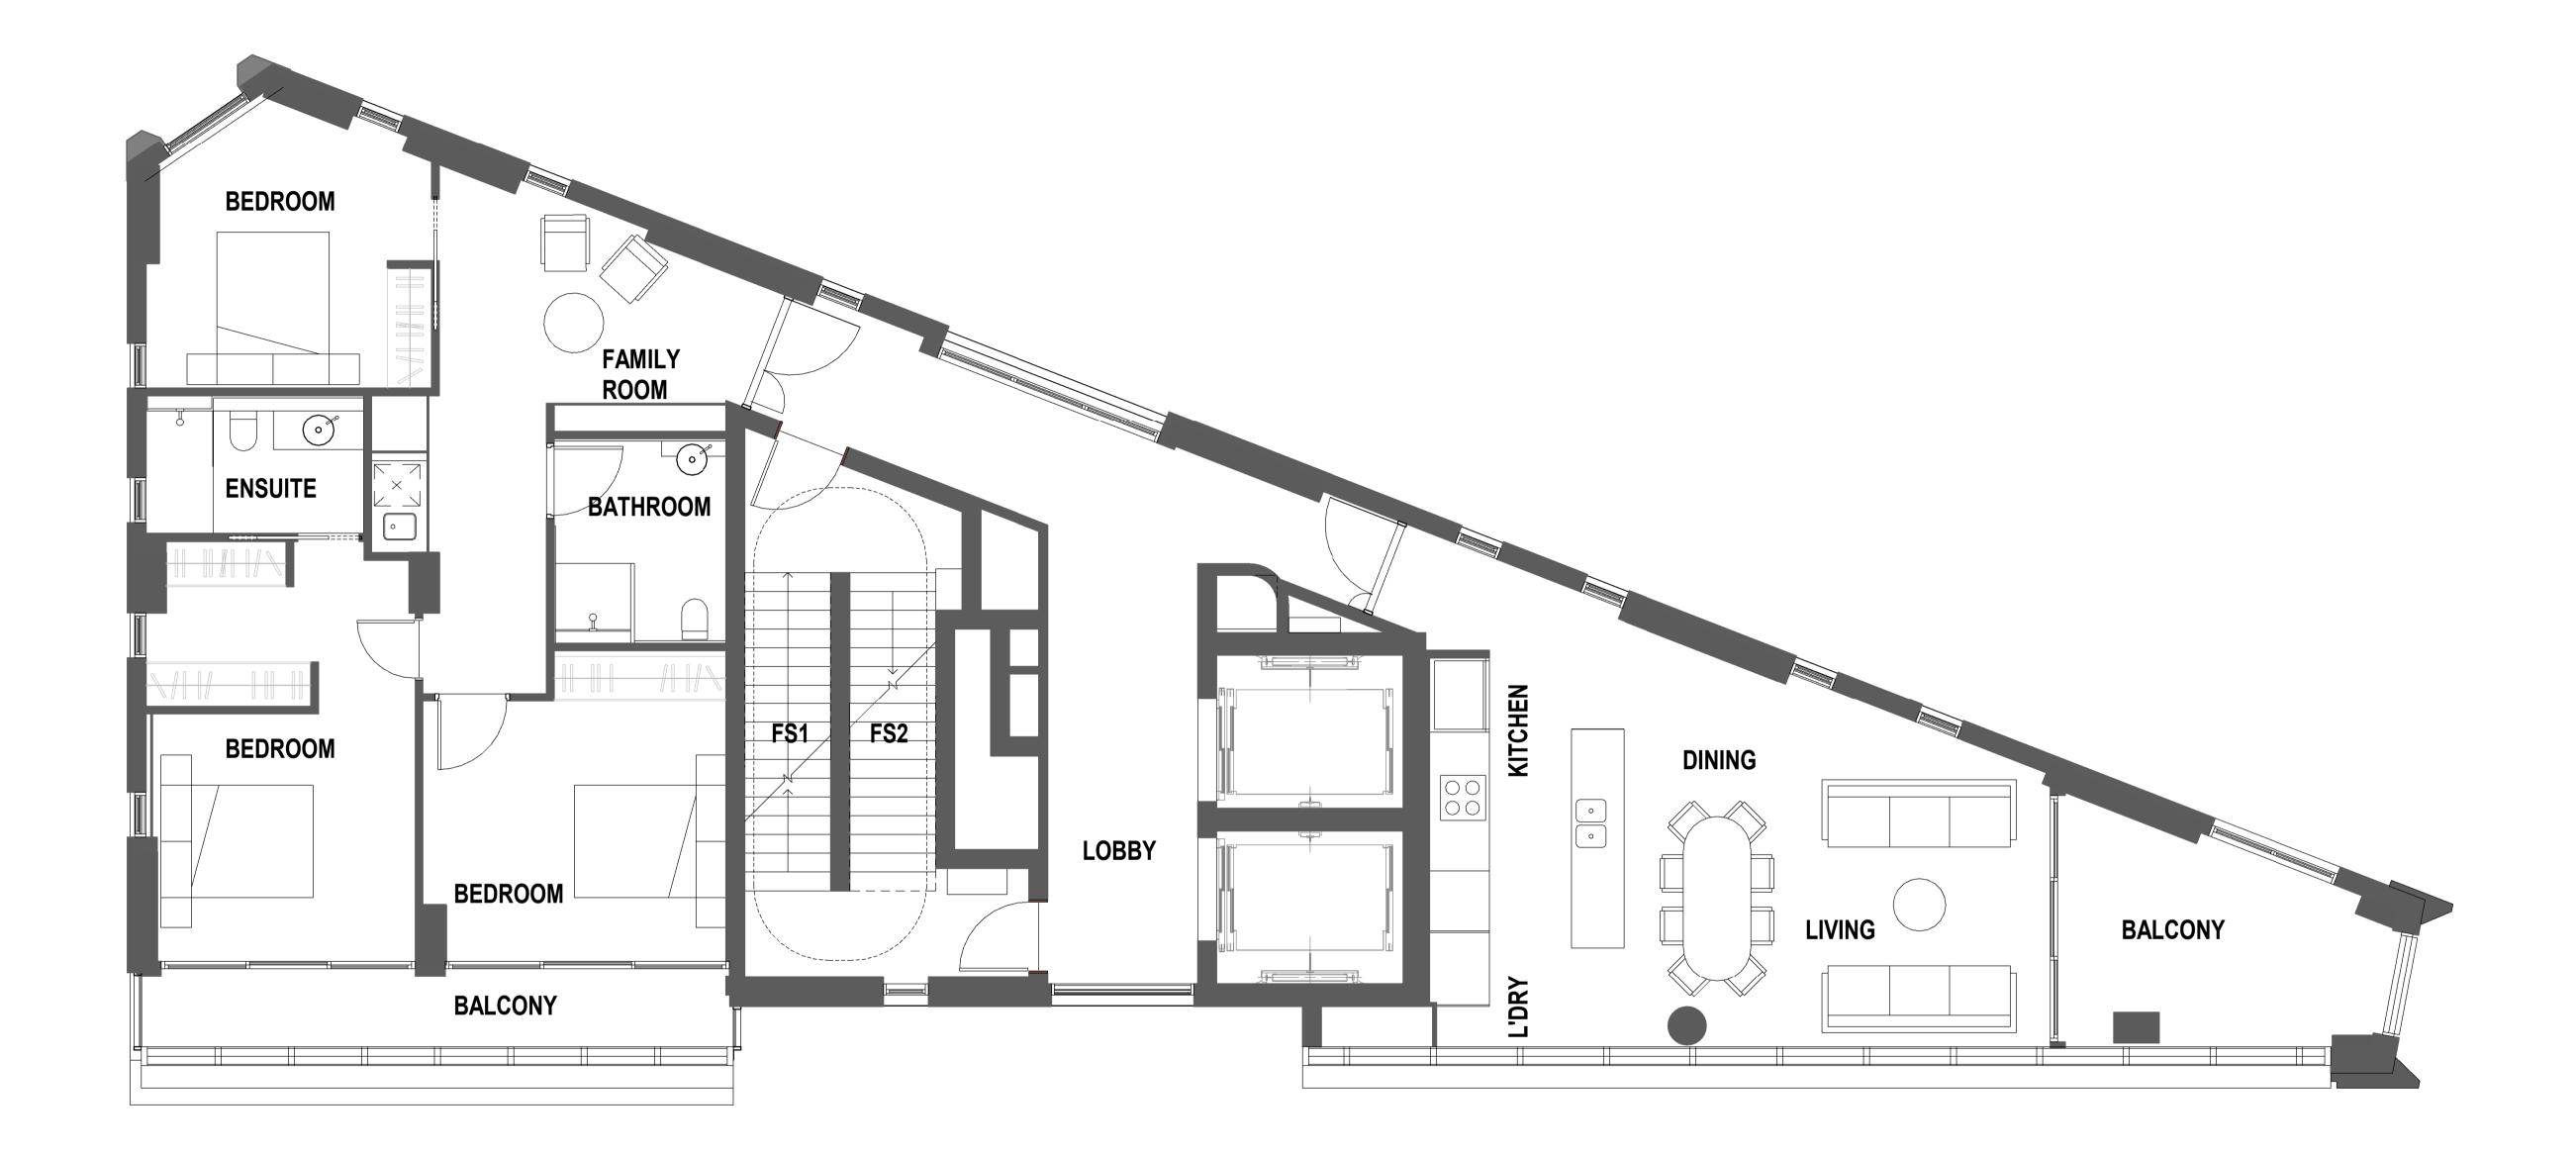


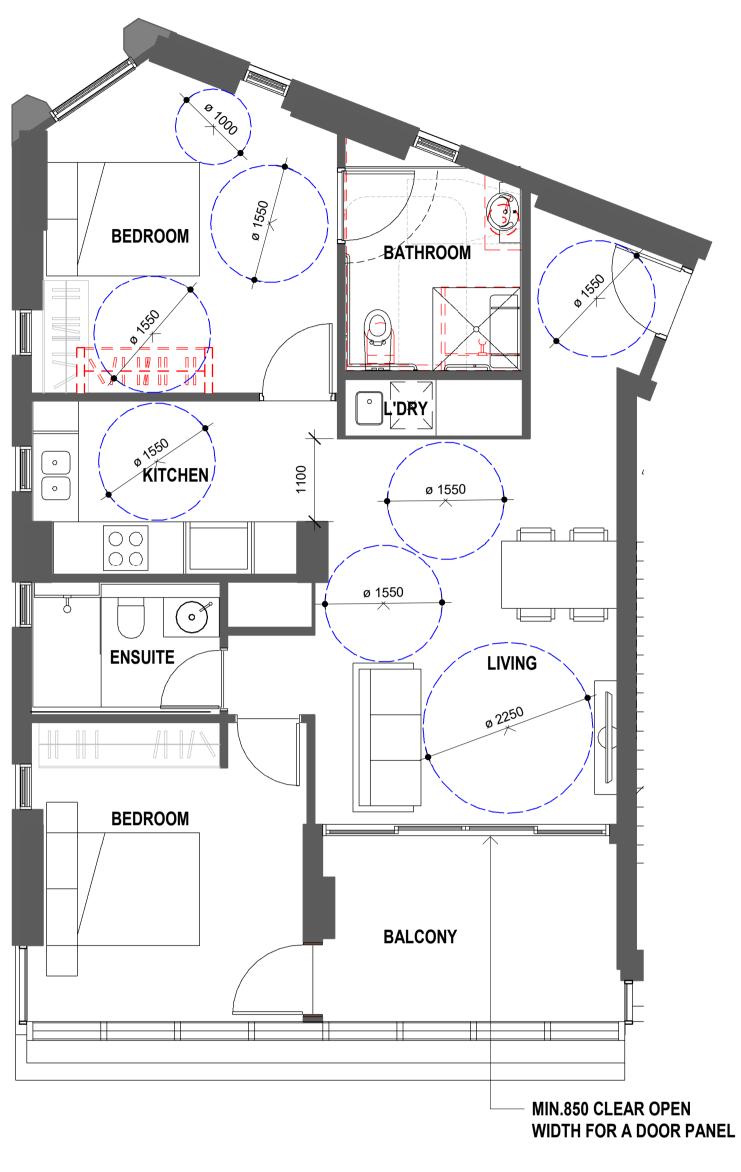2 POST -ADAPTBALE UNIT 501 (601, 701) 1:50


ARCHITECT: DREW DICKSON ARCHITECTS Nominated Architect: Alexander de Belin DREW DICKSON ARCHITECTS PTY LIMITED DREW DICKSON ARCHITECTS PTY LIMITED ABN 12 168 823 153 SUITE 2,GROUND FLOOR, 83 ALEXANDER STREET CROWS NEST NSW 2065 AUSTRALIA Tel: +61 2 90613433 Email: info@dda-australia.com	CLIENT: REZA VAKILI (THE PROPERTY OWNER)	PROJECT: <b>PROPOSED SHOP TOP HOUSING</b> <b>DEVELOPMENT</b> ADDRESS: 58 ANDERSON STREET CHATSWOOD, NSW, 2067	DRAWING ADAPTABLE UN

### NOTES: - ALL CIRCULATION SPACES AT DOOR, IN FRONT OR BESIDE APPLIANCES AND AROUND WC PANS, WASHBASINS AND SHOWER TO BE IN ACCORDANCE WITH AS 1428.1. - ALL INTERNAL FLOOR AND EXTERNAL PAVED SURFACES TO BE SLIP - RESISTANT TO COMPLY WITH AS/NZS 3661.1.

Drawing Scale @ A1: Date: Draw As indicated OCT 2022 KL Drawing Status: DEVELOPMENT APPLICATION Drawn by: KL UNIT PLANS- SHEET 1 Revision: Project / Job No: Drawing No: 18014 A113




# 1 PRE -ADAPTABLE UNIT 801 (901,1001,1101,1201) 1 : 50

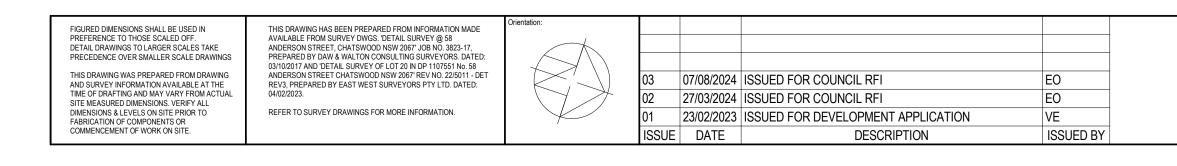

				$\begin{bmatrix} 1 & 2 & 3 \end{bmatrix}$			
	ARCHITECT: DREW DICKSON ARCHITECTS Nominated Architect: Alexander de Belin DREW DICKSON ARCHITECTS PTY LIMITED Architects' Reg. No. 8330 ABM 12 168 882 153	(THE PROPERTY OWNER)	DEVELOPMENT ADDRESS:	ADAPTABLE UNIT PLANS- SHEET 2			Drawn by: KL DN Revision:
DREW DICKSON ARCHITECTS PTY LIMITED ABN 12 168 892 153 SUITE 2,GROUND FLOOR, 83 ALEXANDER STREET CROWS NEST NSW 2065 AUSTRALIA Tel: +61 2 90613433 Email: info@dda-australia.com Web: www.dda-australia.com			58 ANDERSON STREET CHATSWOOD, NSW, 2067		18014	A114	03

### NOTES: - ALL CIRCULATION SPACES AT DOOR, IN FRONT OR BESIDE APPLIANCES AND AROUND WC PANS, WASHBASINS AND SHOWER TO BE IN ACCORDANCE WITH AS 1428.1. - ALL INTERNAL FLOOR AND EXTERNAL PAVED SURFACES TO BE SLIP - RESISTANT TO COMPLY WITH AS/NZS 3661.1.

Scale 1:50

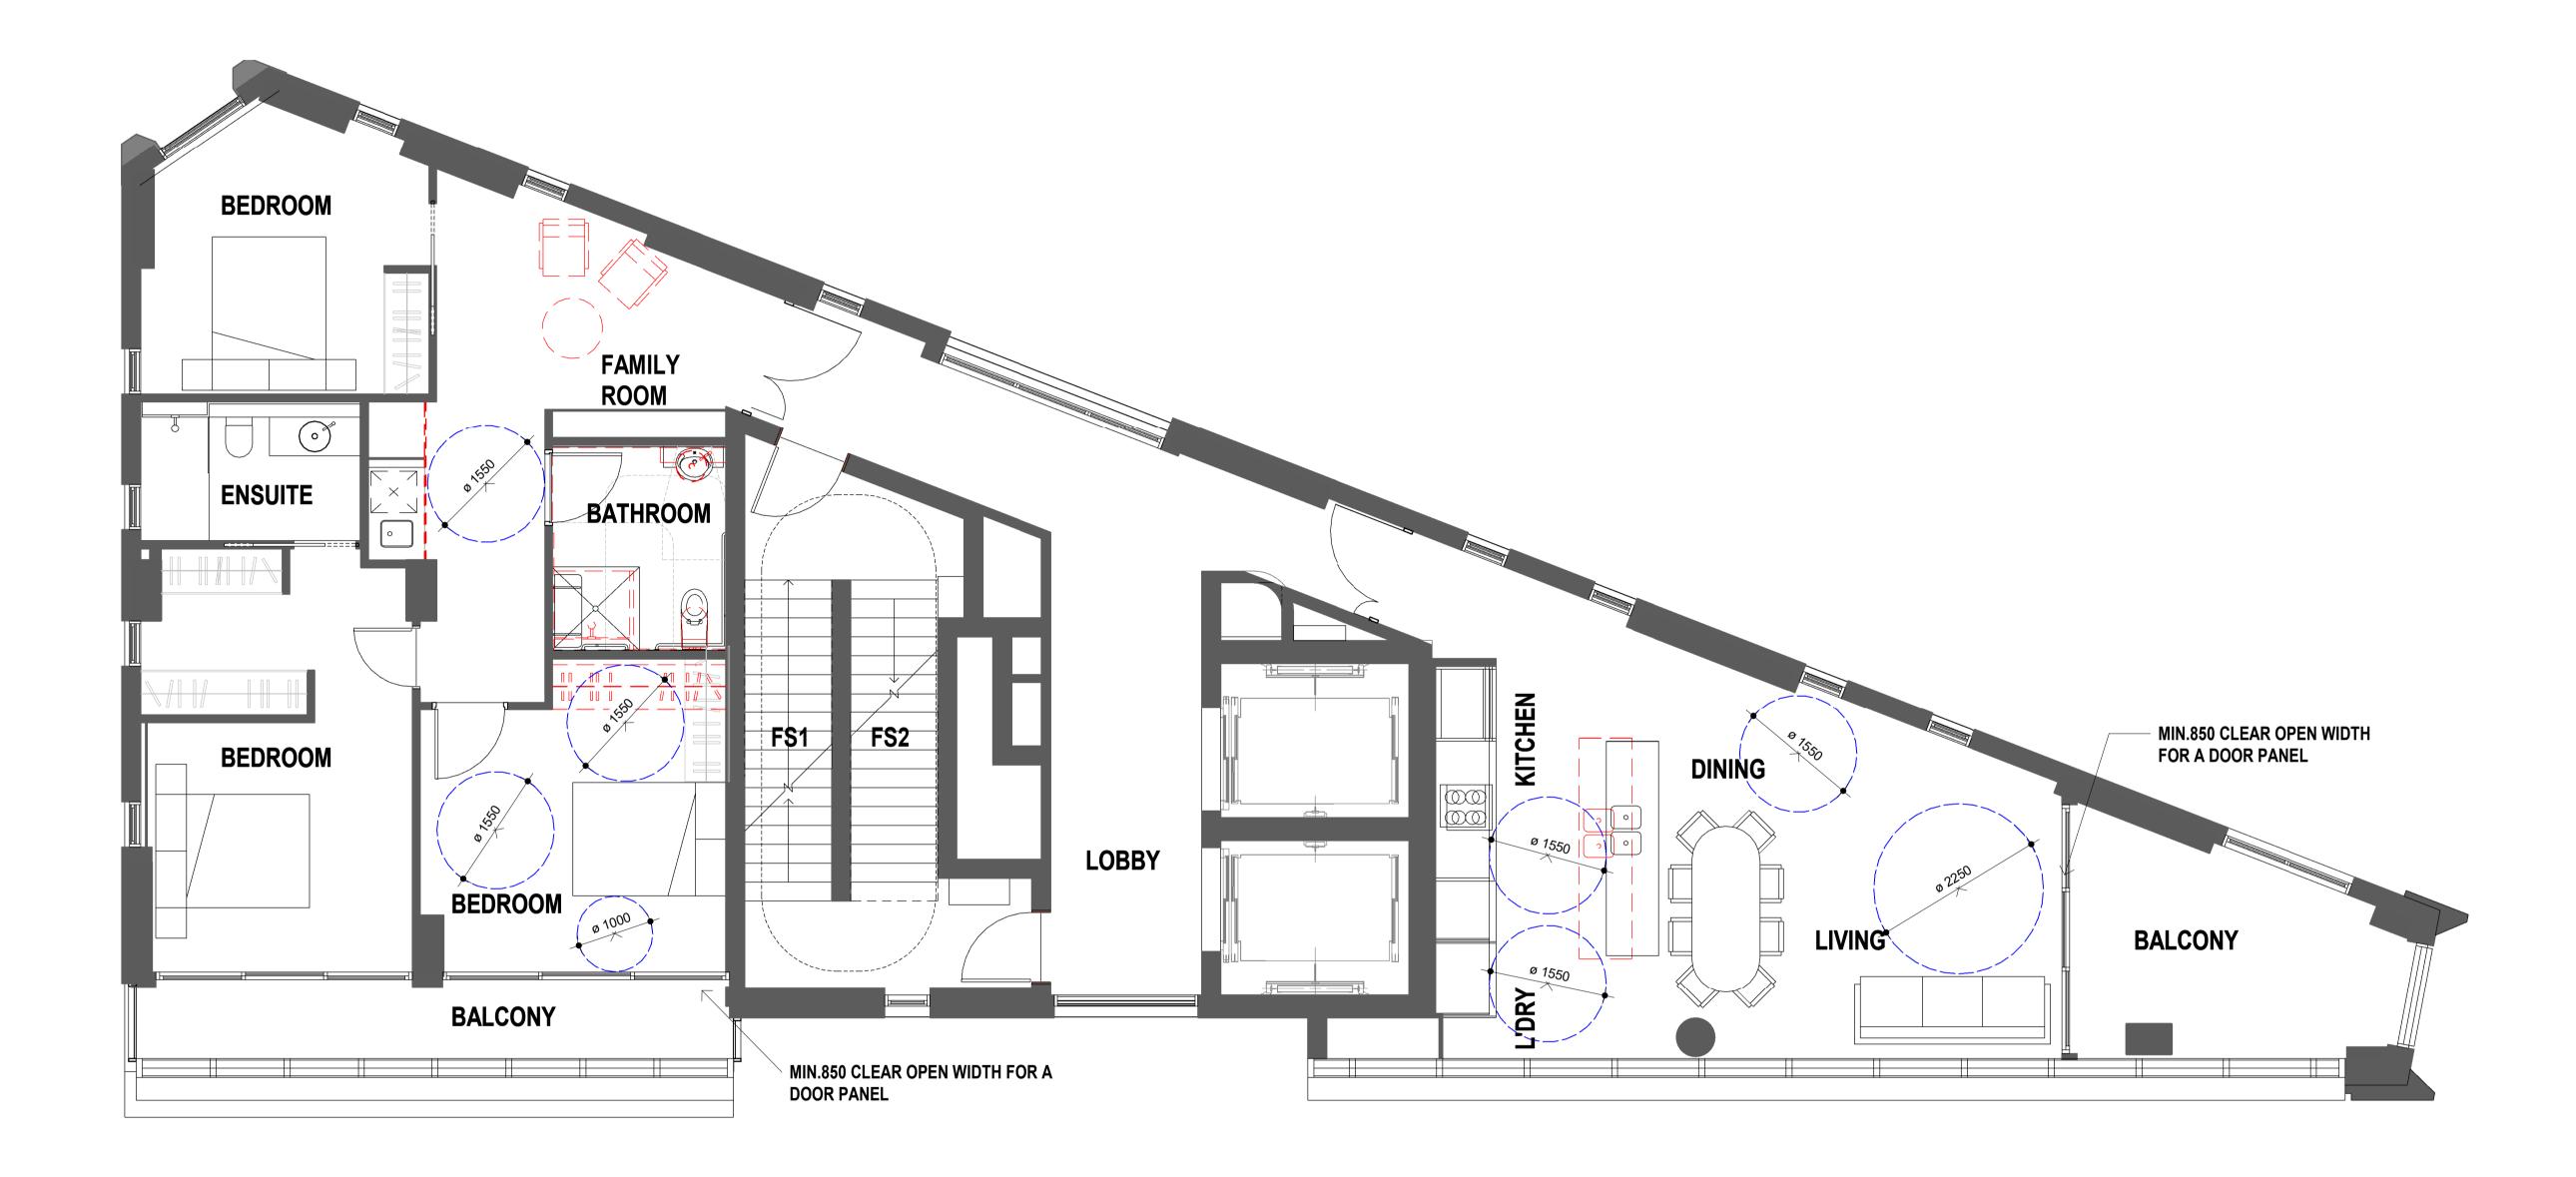

# 1 POST -ADAPTABLE UNIT 801 (901, 1001, 1101, 1201) 1 : 50


FIGURED DIMENSIONS SHALL BE USED IN	THIS DRAWING HAS BEEN PREPARED FROM INFORMATION MADE	Orientation:				
PREFERENCE TO THOSE SCALED OFF. DETAIL DRAWINGS TO LARGER SCALES TAKE	AVAILABLE FROM SURVEY DWGS. 'DETAIL SURVEY @ 58 ANDERSON STREET. CHATSWOOD NSW 2067' JOB NO. 3823-17.					
PRECEDENCE OVER SMALLER SCALE DRAWINGS	PREPARED BY DAW & WALTON CONSULTING SURVEYORS. DATED: 03/10/2017 AND 'DETAIL SURVEY OF LOT 20 IN DP 1107551 №. 58					
THIS DRAWING WAS PREPARED FROM DRAWING AND SURVEY INFORMATION AVAILABLE AT THE	ANDERSON STREET CHATSWOOD NSW 2067' REV NO. 22/5011 - DET REV3, PREPARED BY EAST WEST SURVEYORS PTY LTD. DATED:		03	07/08/2024	ISSUED FOR COUNCIL RFI	EO
TIME OF DRAFTING AND MAY VARY FROM ACTUAL SITE MEASURED DIMENSIONS. VERIFY ALL	04/02/2023.		02	27/03/2024	ISSUED FOR COUNCIL RFI	EO
DIMENSIONS & LEVELS ON SITE PRIOR TO FABRICATION OF COMPONENTS OR	REFER TO SURVEY DRAWINGS FOR MORE INFORMATION.		01	23/02/2023	ISSUED FOR DEVELOPMENT APPLICATION	VE
COMMENCEMENT OF WORK ON SITE.			ISSUE	DATE	DESCRIPTION	ISSUED BY

			Scale 1 : 50 			
ARCHITECT:	CLIENT: REZA VAKILI (THE PROPERTY OWNER)	PROJECT: PROPOSED SHOP TOP HOUSING DEVELOPMENT	ADAPTABLE UNIT PLANS- SHEET 3	Drawing Scale @ A1: As indicated Drawing Status:		Drawn by: KL
DREW DICKSON ARCHITECTS Nominated Architect: Alexander de Belin DREW DICKSON ARCHITECTS PTY LIMITED SUITE 2,GROUND FLOOR, 83 ALEXANDER STREET CROWS NEST NSW 2065 AUSTRALIA Tel: +61 2 90613433 Email: info@dda-australia.com		DEVELOPMENT ADDRESS: 58 ANDERSON STREET CHATSWOOD, NSW, 2067		DEVELOPI Project / Job No: 18014	MENT APPLICATIO Drawing No: A115	DN Revision: 03

### NOTES: - ALL CIRCULATION SPACES AT DOOR, IN FRONT OR BESIDE APPLIANCES AND AROUND WC PANS, WASHBASINS AND SHOWER TO BE IN ACCORDANCE WITH AS 1428.1. - ALL INTERNAL FLOOR AND EXTERNAL PAVED SURFACES TO BE SLIP - RESISTANT TO COMPLY WITH AS/NZS 3661.1.


FIGURED DIMENSIONS SHALL BE USED IN PREFERENCE TO THOSE SCALED OFF.     THIS DRAWING HAS BEEN PREPARED FROM INFORMATION MADE DETAIL DRAWINGS TO LARGER SCALES TARE PRECEDENCE OVER SMALLER SCALE DRAWINGS ANDERSON STREET I CHARWINGS. 'DETAIL SUPPEY @ 58 ANDERSON STREET I CHARWINGS' DU NOS 3023-17. PREPARED BY DAW & WALTON CONSULTING SURVEYORS. DATED: OVER SMALLER SCALE DRAWING AND SURVEY INFORMATION AVALABLE AT THE TIME OF DRAFTING AND MAY VARY FROM ACTUAL SITE INFESSION STREET CHARWING DIMENSIONS VERTYALL DIMENSIONS & LEVELS ON SITE PROR TO FABRICATION OF COMPORENTS OR COMMENCEMENT OF WORK ON SITE.     THIS DRAWING HAS BEEN PREPARED BY DAW & WALTON CONSULTING SURVEYORS. DATED: OVER SURVEY INFORMATION.     Orientation:	LEGEND         WWE         WWE         WWE         WWE         UST         WWE         WWE <t< th=""><th>PODIUM:104BRICK TYPE 01 TOWER 1 PODIUM (CORNER WILSON AND ANDERSON STREET) COLOUR: DORCHESTER105BRICK TYPE 02 TOWER 2 PODIUM (ANDERSON NORTH) COLOUR: WESTMINSTER106AWNING STEEL FRAME COLOUR: DARK BROWN107GLAZING TYPE LIGHT GREY TINTED108GLAZING TYPE RETAIL CLEAR GLAZING</th></t<>	PODIUM:104BRICK TYPE 01 TOWER 1 PODIUM (CORNER WILSON AND ANDERSON STREET) COLOUR: DORCHESTER105BRICK TYPE 02 TOWER 2 PODIUM (ANDERSON NORTH) COLOUR: WESTMINSTER106AWNING STEEL FRAME COLOUR: DARK BROWN107GLAZING TYPE LIGHT GREY TINTED108GLAZING TYPE RETAIL CLEAR GLAZING
Image: Note of the sector of	BOUNDARY © MLINE OF 53M HEIGHT PLANE	$\frac{\text{THE CROWN}}{158.05}$ $\frac{\text{ROOF}}{156.98}$ $\frac{\text{Level 14}}{153.58}$


-(107)

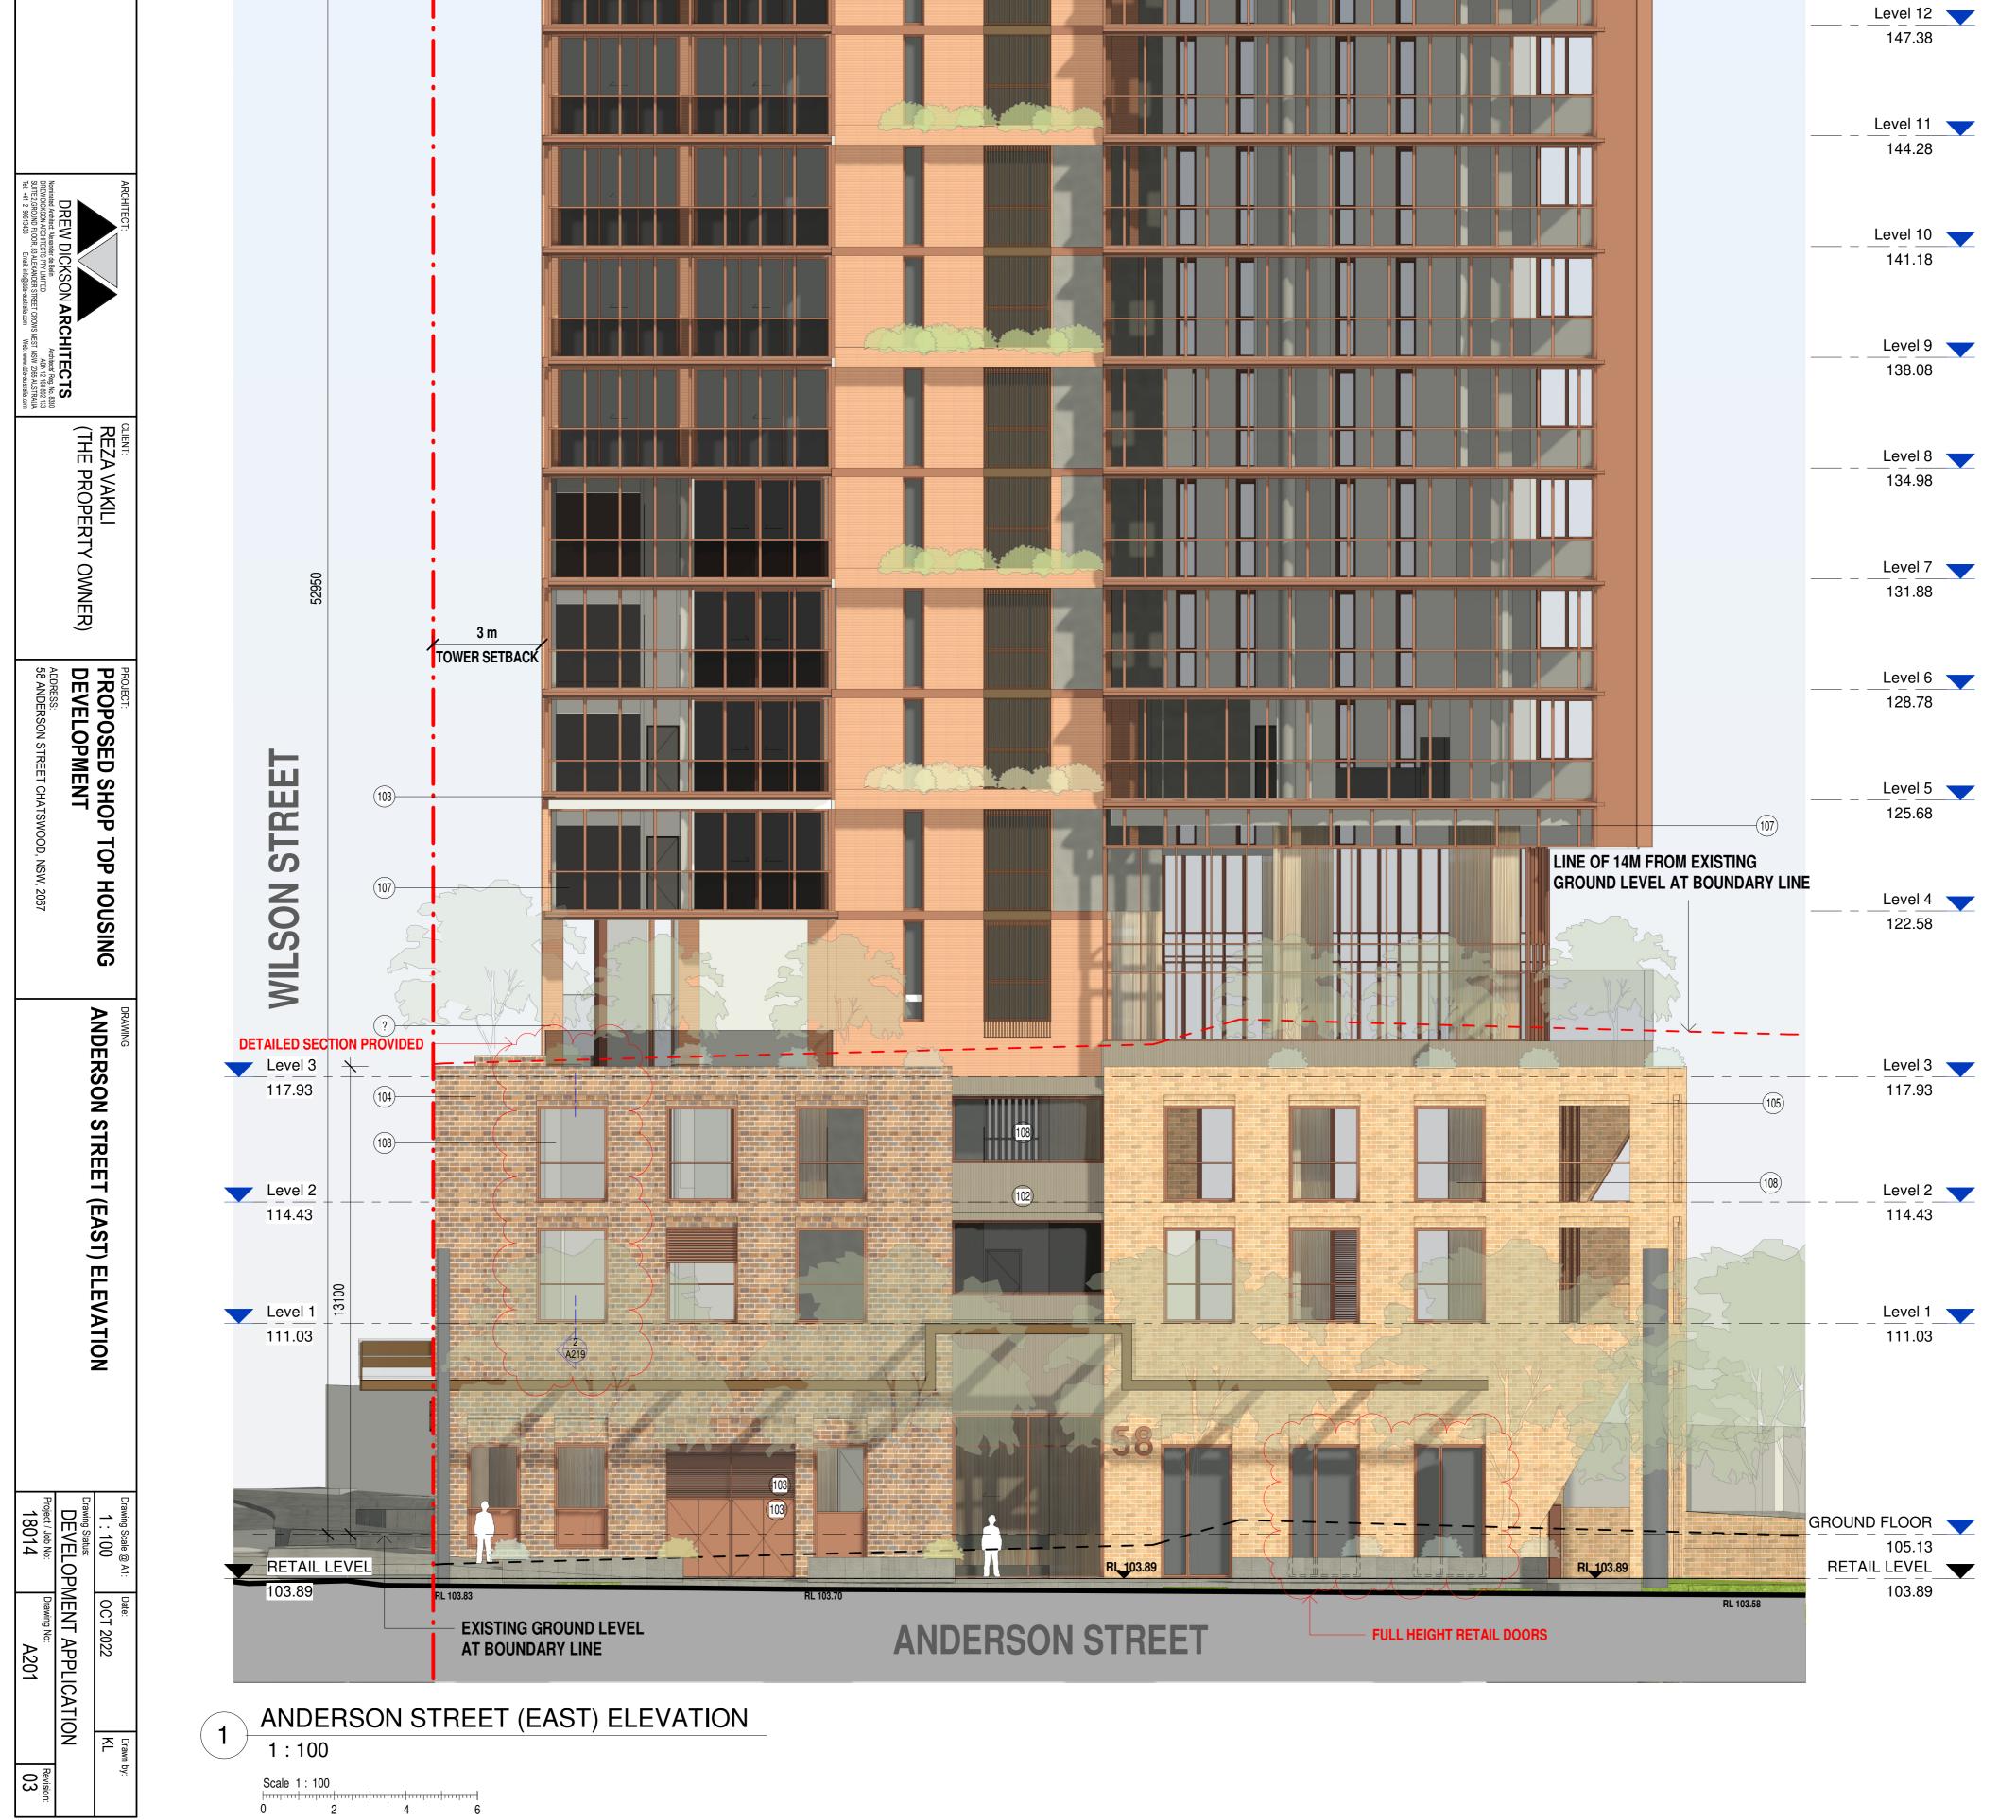


4 2


Revision 03

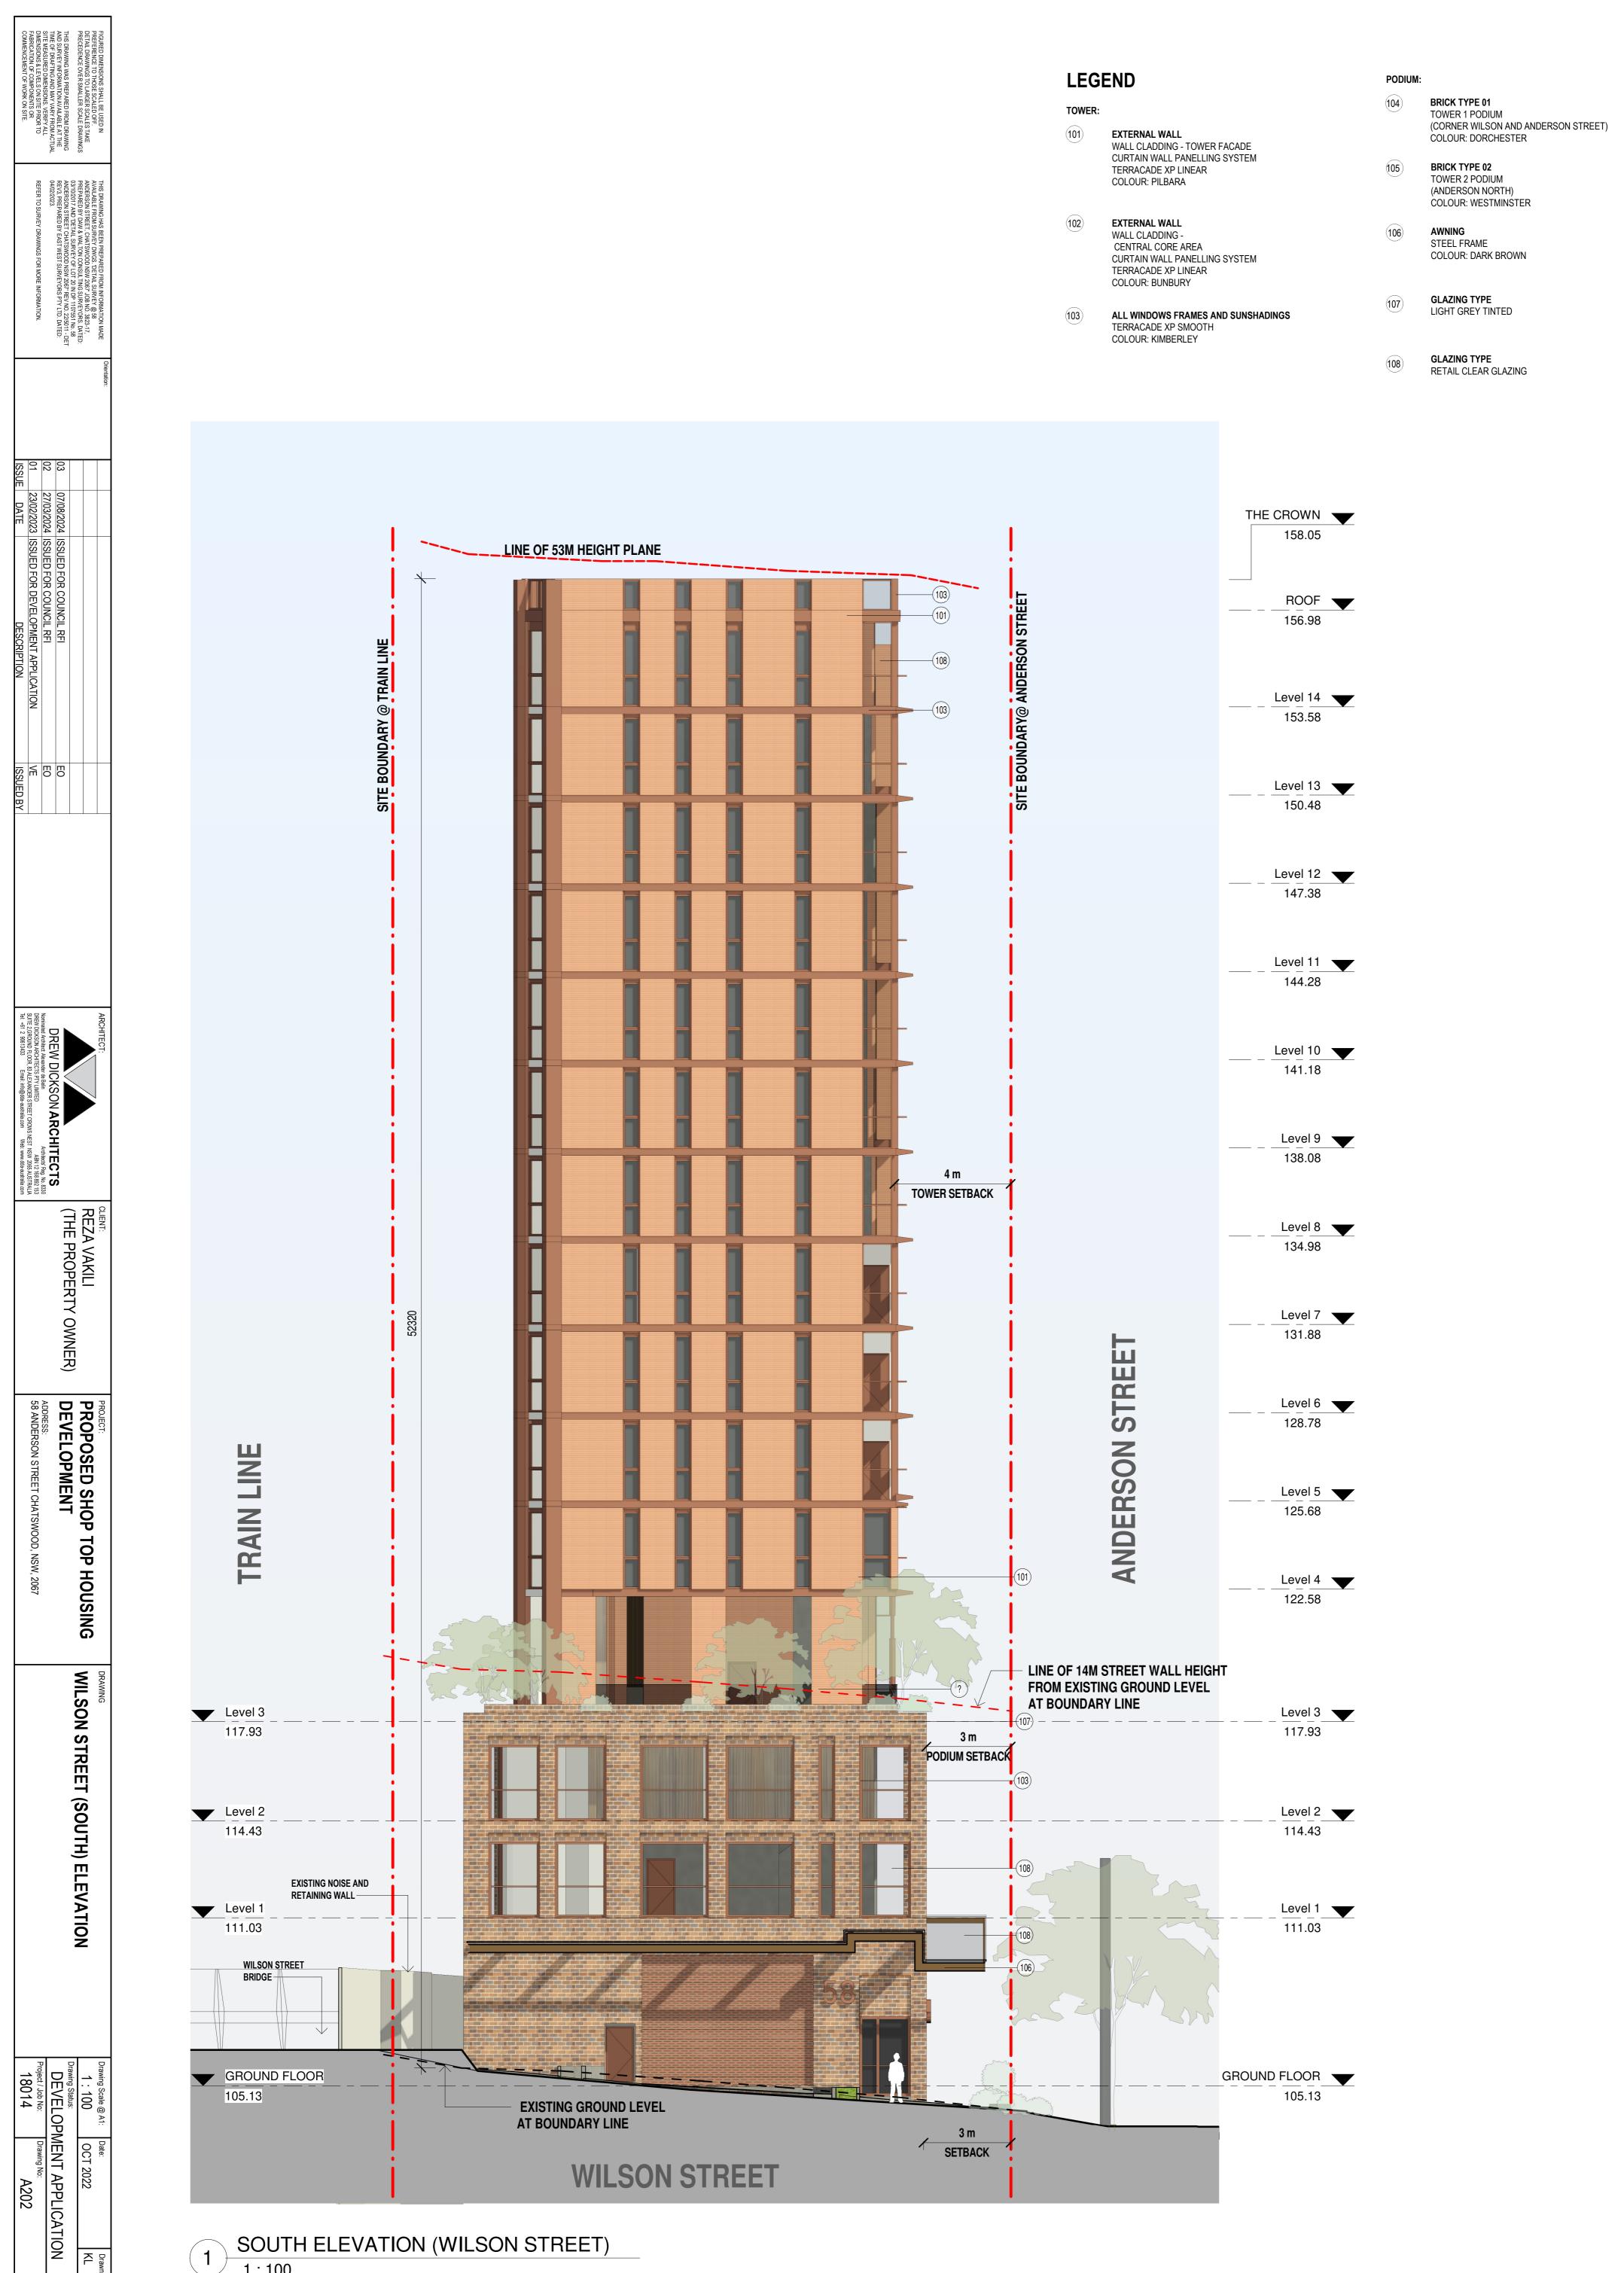

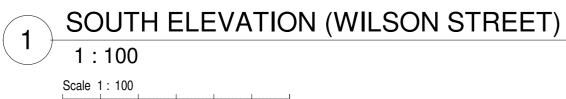

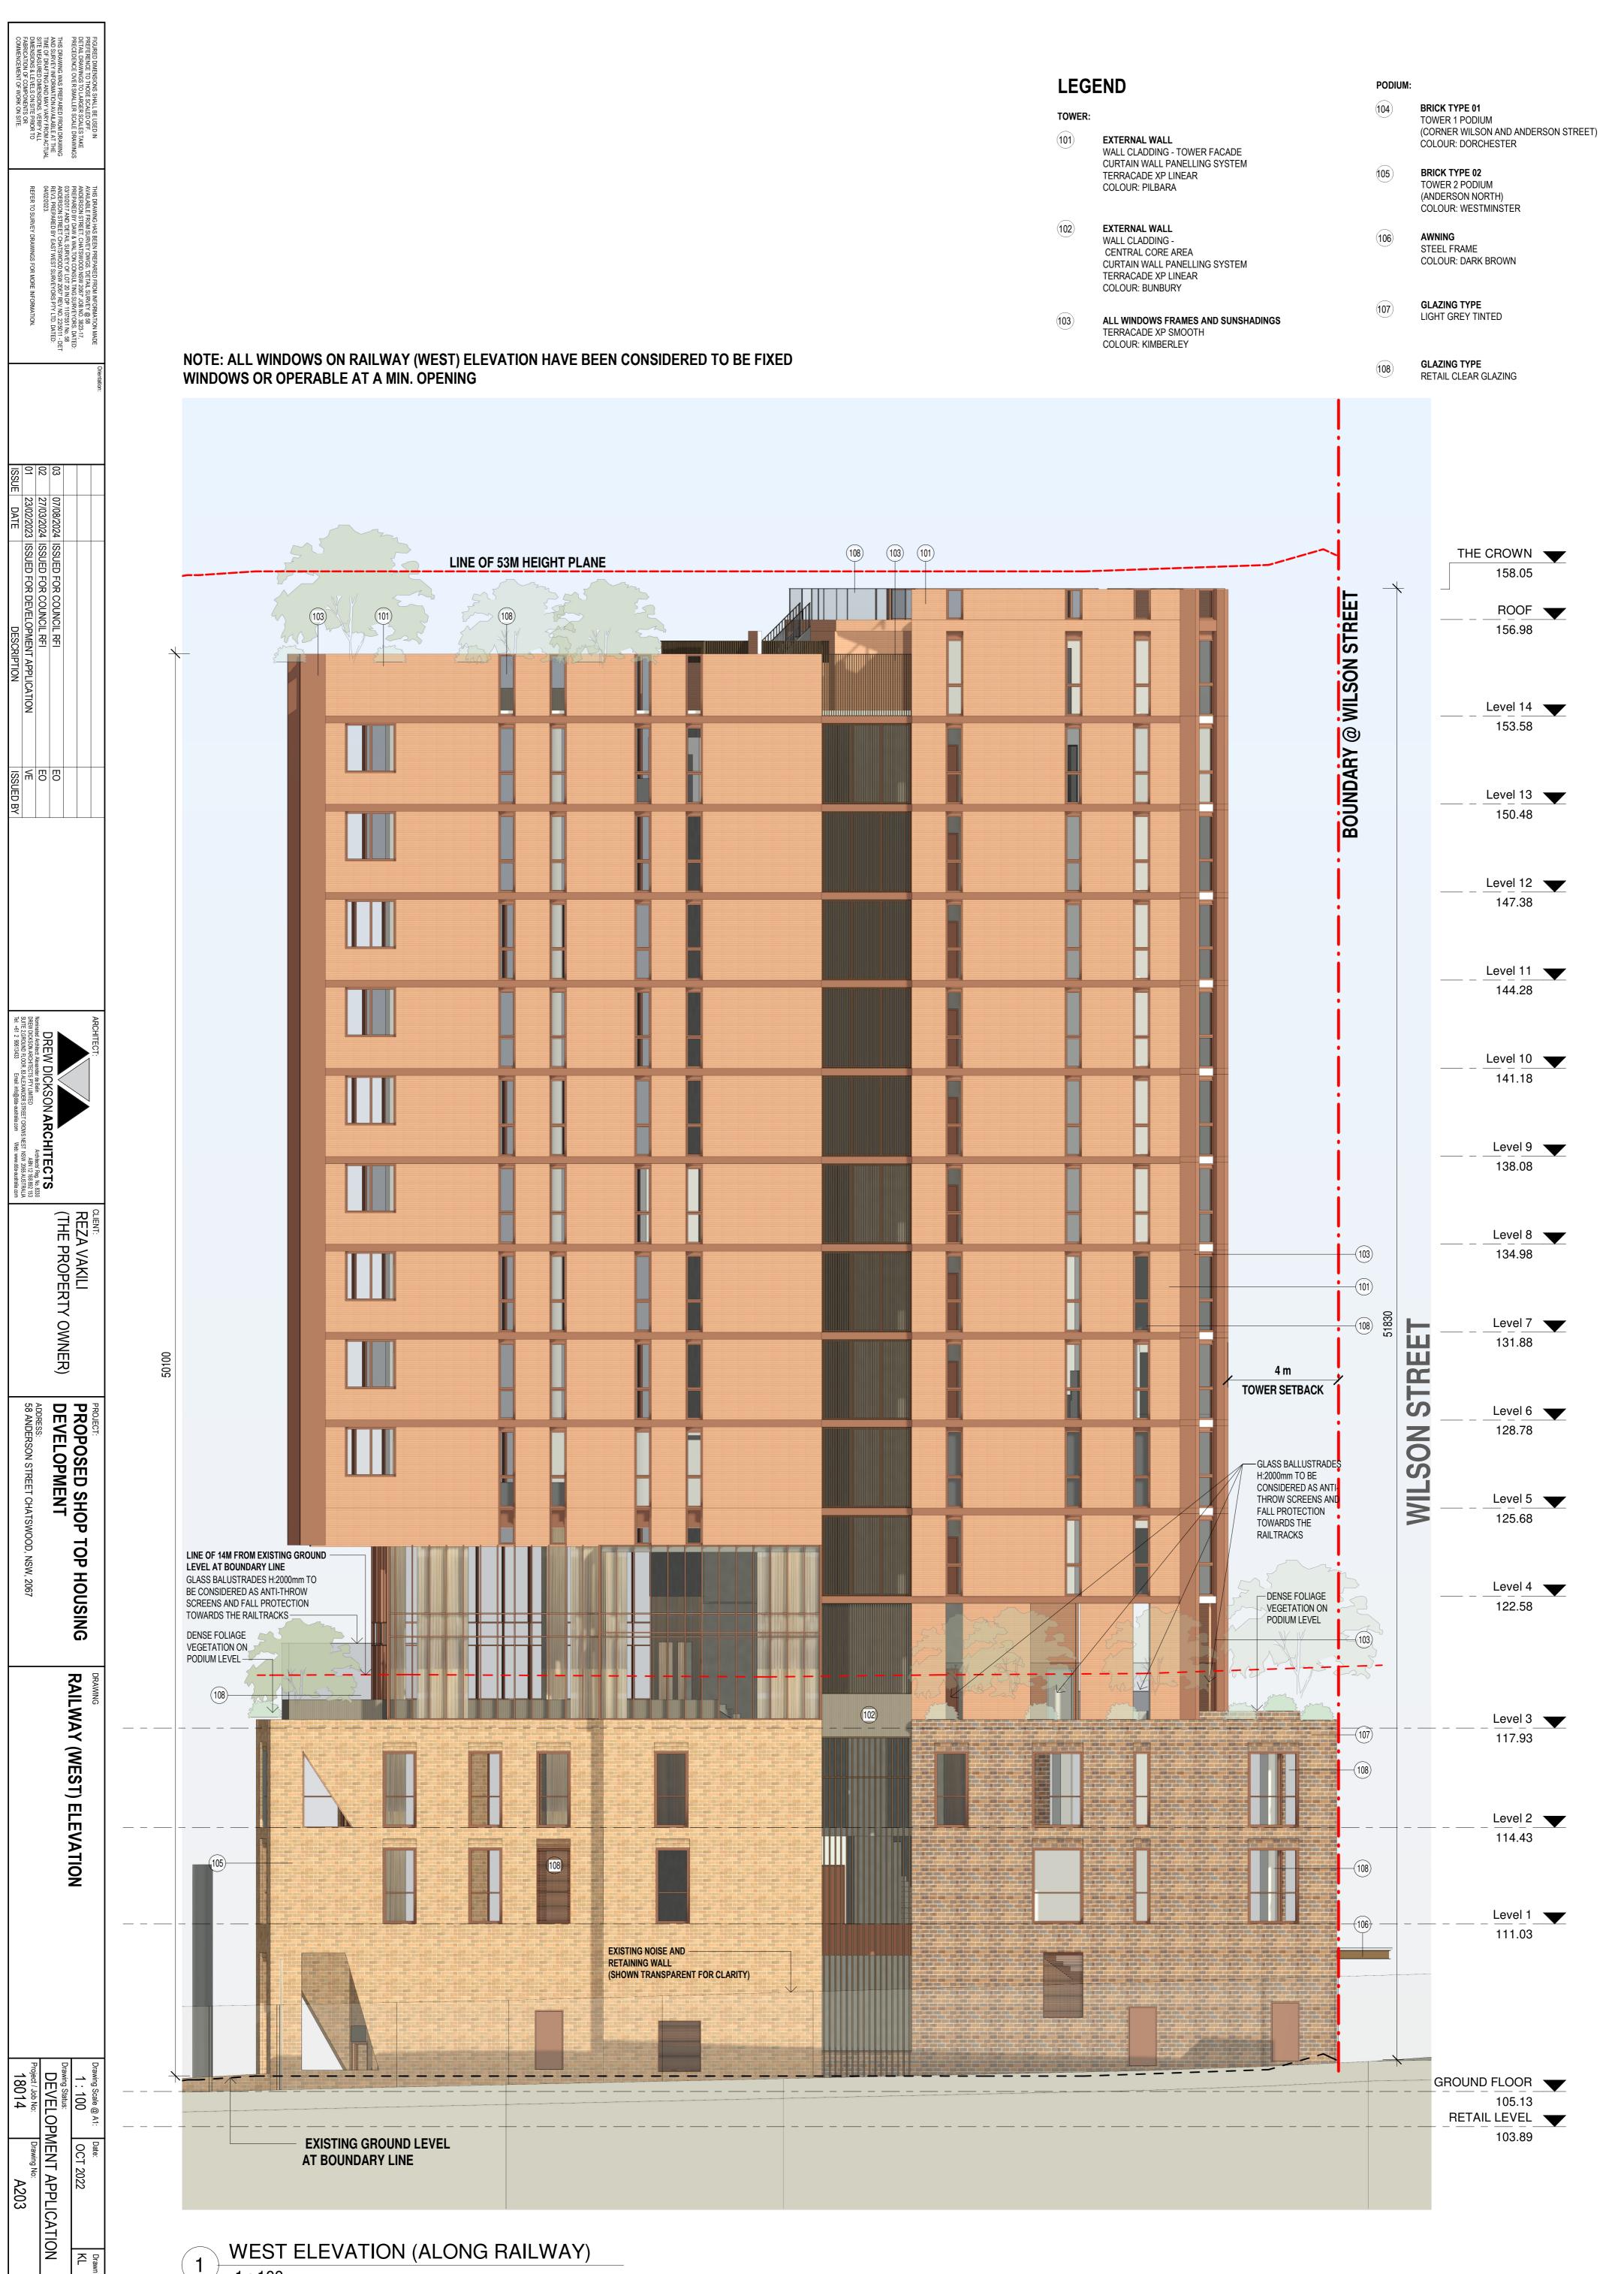

1:100 Scale 1:100 

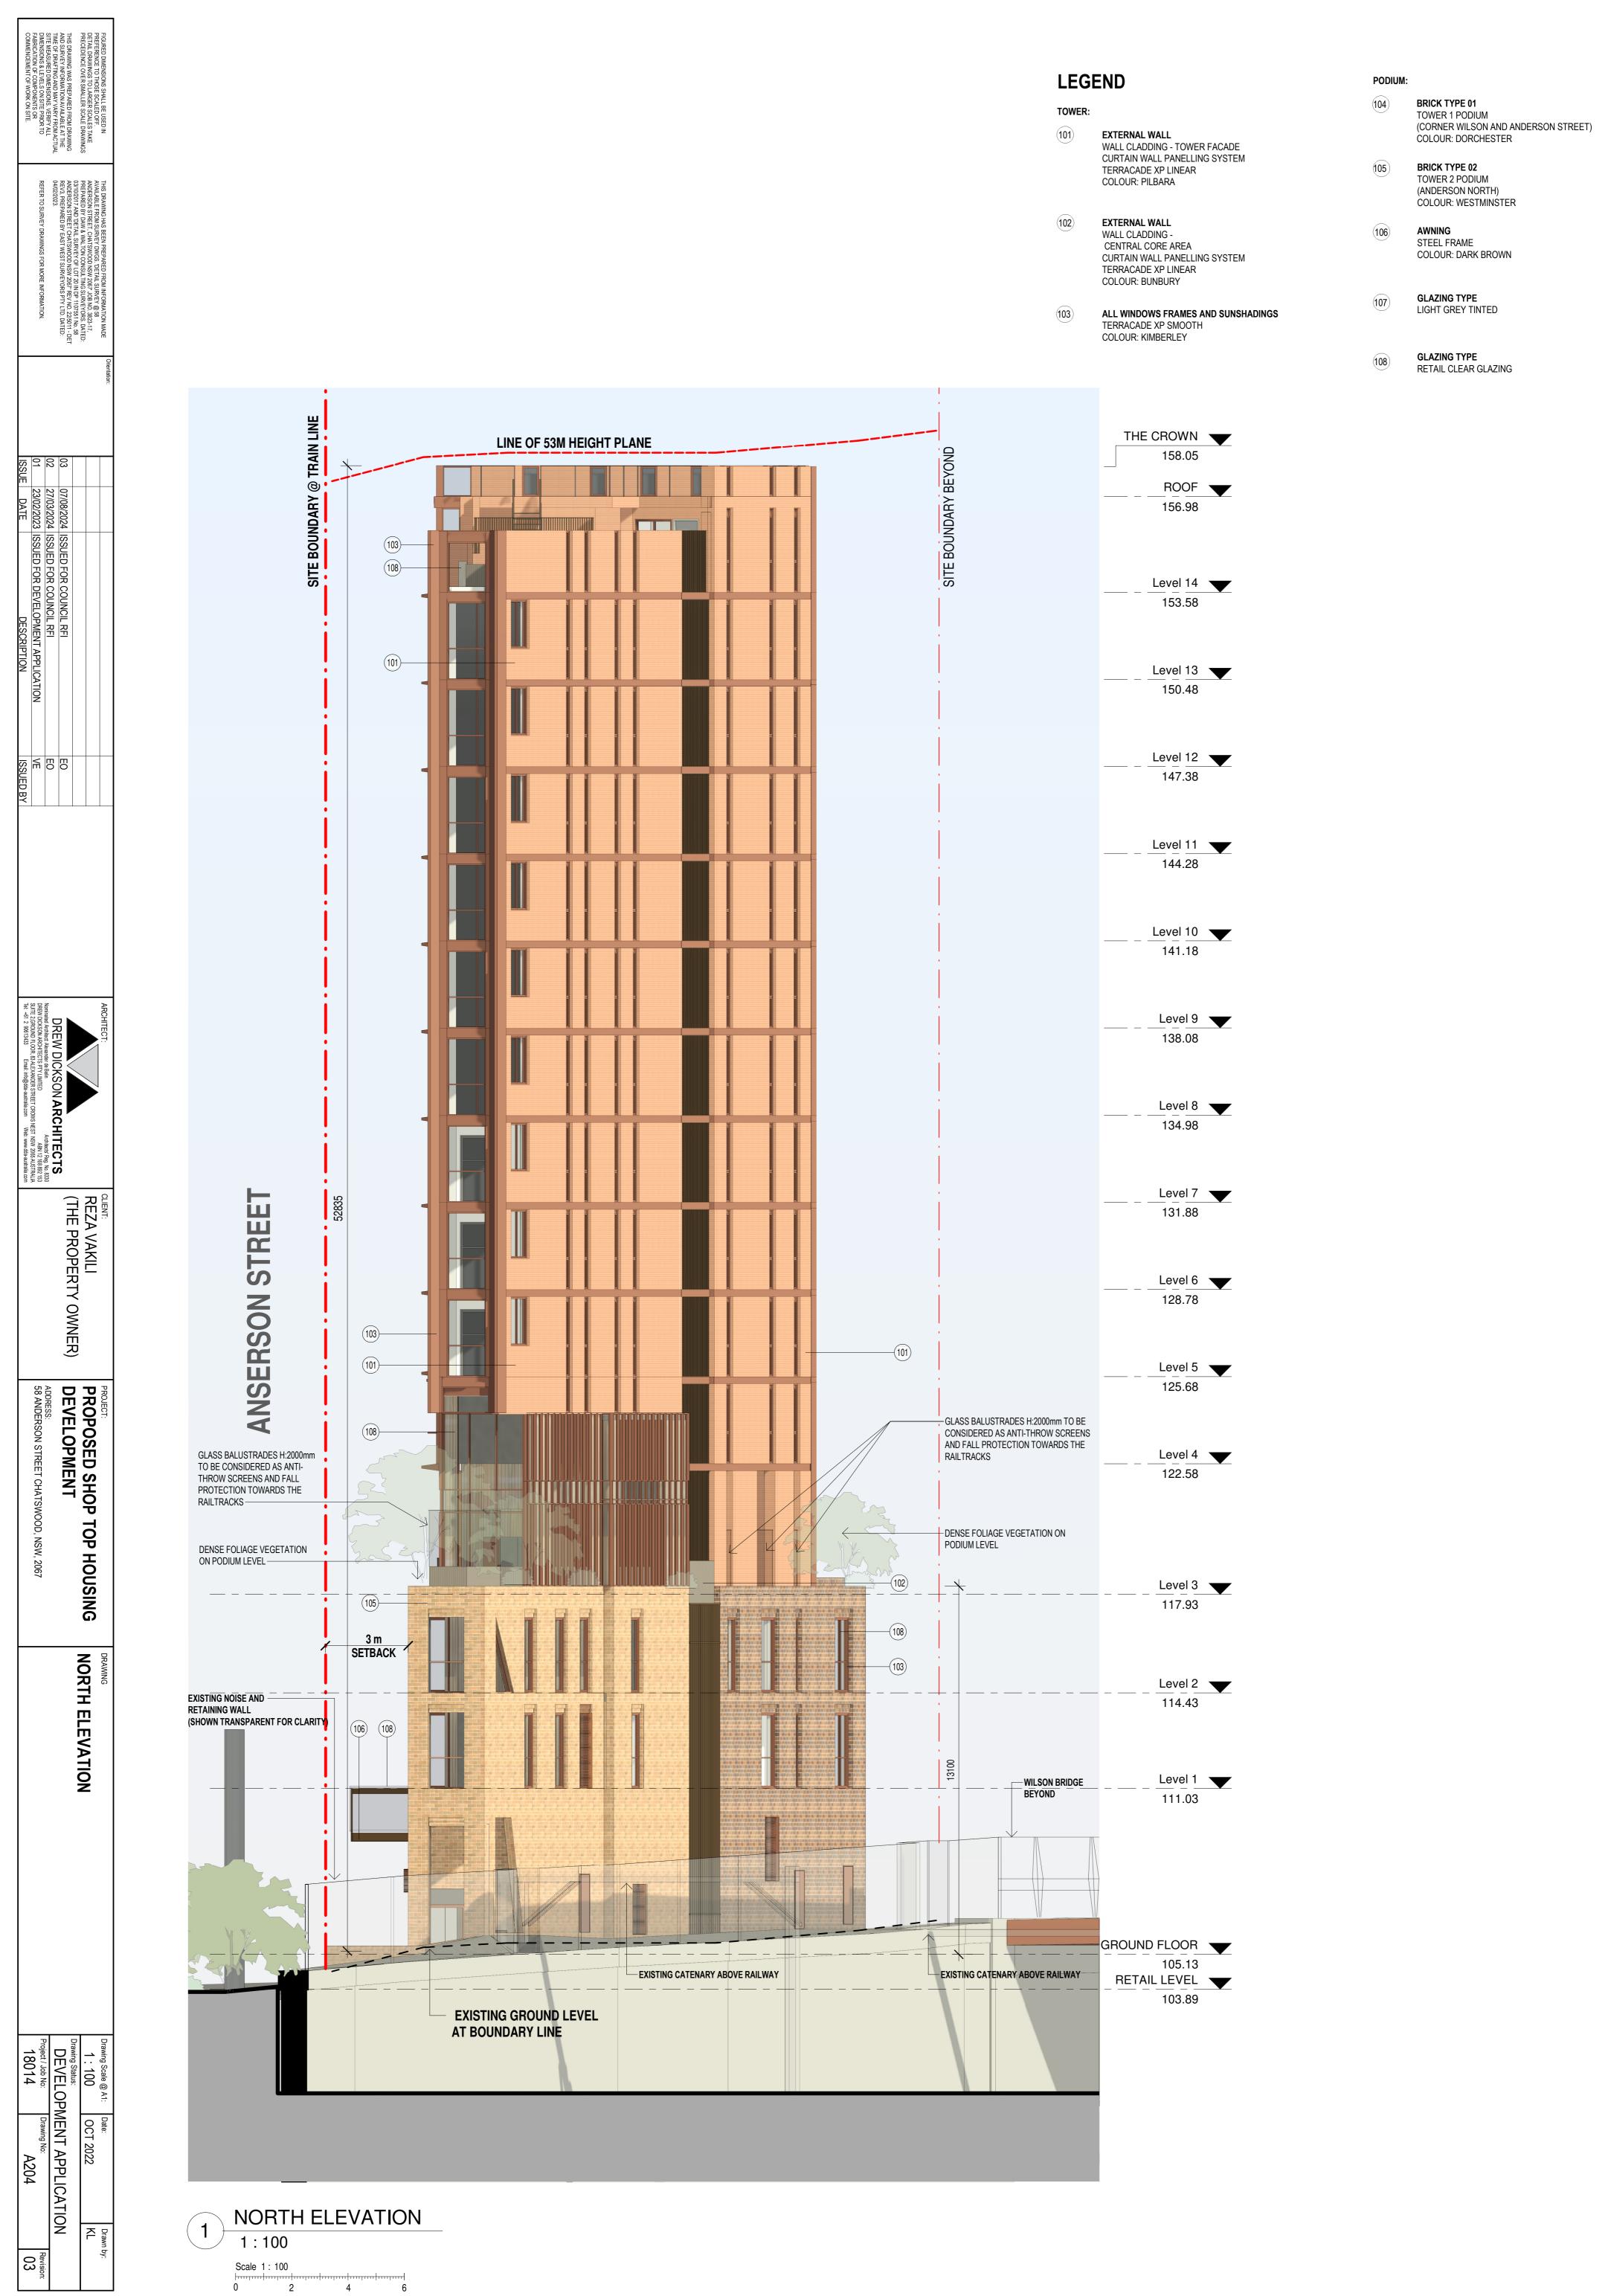

## TOWER






CURTAIN WALL PANELLING SYSTEM TERRACADE XP LINEAR COLOUR: PILBARA

### PODIUM



(104)

BRICK TYPE 01 TOWER 1 PODIUM (CORNER WILSON AND ANDERSON STREET) BRAND: AUSTRALBRICKS COLOUR: PARK LANE DORCHESTER  $\sim$  $\sim$ 

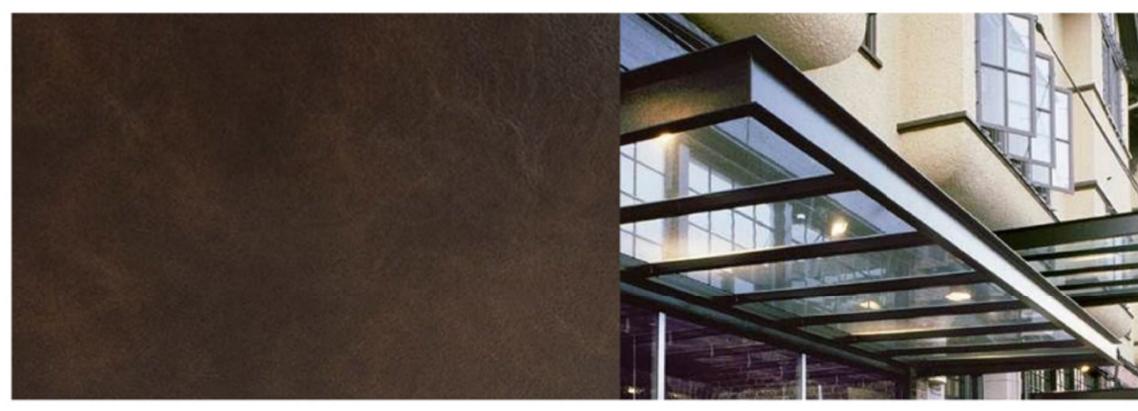



AWNING STEEL FRAME COLOUR: DARK BROWN

FIGURED DIMENSIONS SHALL BE USED IN PREFERENCE TO THOSE SCALED OFF.	THIS DRAWING HAS BEEN PREPARED FROM INFORMATION MADE AVAILABLE FROM SURVEY DWGS. 'DETAIL SURVEY @ 58	Orientation:				
DETAIL DRAWINGS TO LARGER SCALES TAKE PRECEDENCE OVER SMALLER SCALE DRAWINGS	ANDERSON STREET, CHATSWOOD NSW 2067' JOB NO. 3823-17, PREPARED BY DAW & WALTON CONSULTING SURVEYORS, DATED: 03(40/212 AND DETAIL CITYON OF LOT 20 NJ DR 40/2561 NJ - 68					
THIS DRAWING WAS PREPARED FROM DRAWING AND SURVEY INFORMATION AVAILABLE AT THE	03/10/2017 AND 'DETAIL SURVEY OF LOT 20 IN DP 1107551 No. 58 ANDERSON STREET CHATSWOOD NSW 2067' REV NO. 22/5011 - DET REV3, PREPARED BY EAST WEST SURVEYORS PTY LTD. DATED:		03	07/08/2024	ISSUED FOR COUNCIL RFI	EO
TIME OF DRAFTING AND MAY VARY FROM ACTUAL SITE MEASURED DIMENSIONS. VERIFY ALL	04/02/2023.		02	27/03/2024	ISSUED FOR COUNCIL RFI	EO
DIMENSIONS & LEVELS ON SITE PRIOR TO FABRICATION OF COMPONENTS OR	REFER TO SURVEY DRAWINGS FOR MORE INFORMATION.		01	23/02/2023	ISSUED FOR DEVELOPMENT APPLICATION	VE
COMMENCEMENT OF WORK ON SITE.			ISSUE	DATE	DESCRIPTION	ISSUED BY



WINDOW FRAMES, MULLIONS, SUN-SHADING












GLAZING TYPE 1 LIGHT GREY TINTED

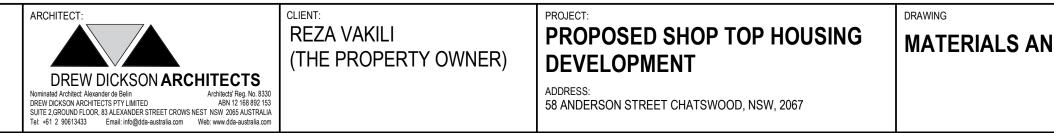




102 CURTAIN WALL PANELLING SYSTEM TERRACADE XP LINEAR COLOUR: BUNBURY




GLAZING TYPE RETAIL CLEAR GLAZING

AND FINISHES	Drawing Scale @ A1:	Date: OCT 2022	Drawn by: VE		
	Drawing Status: DEVELOPMENT APPLICATION				
	Project / Job No: 18014	Drawing No: A205	Revision: 03		



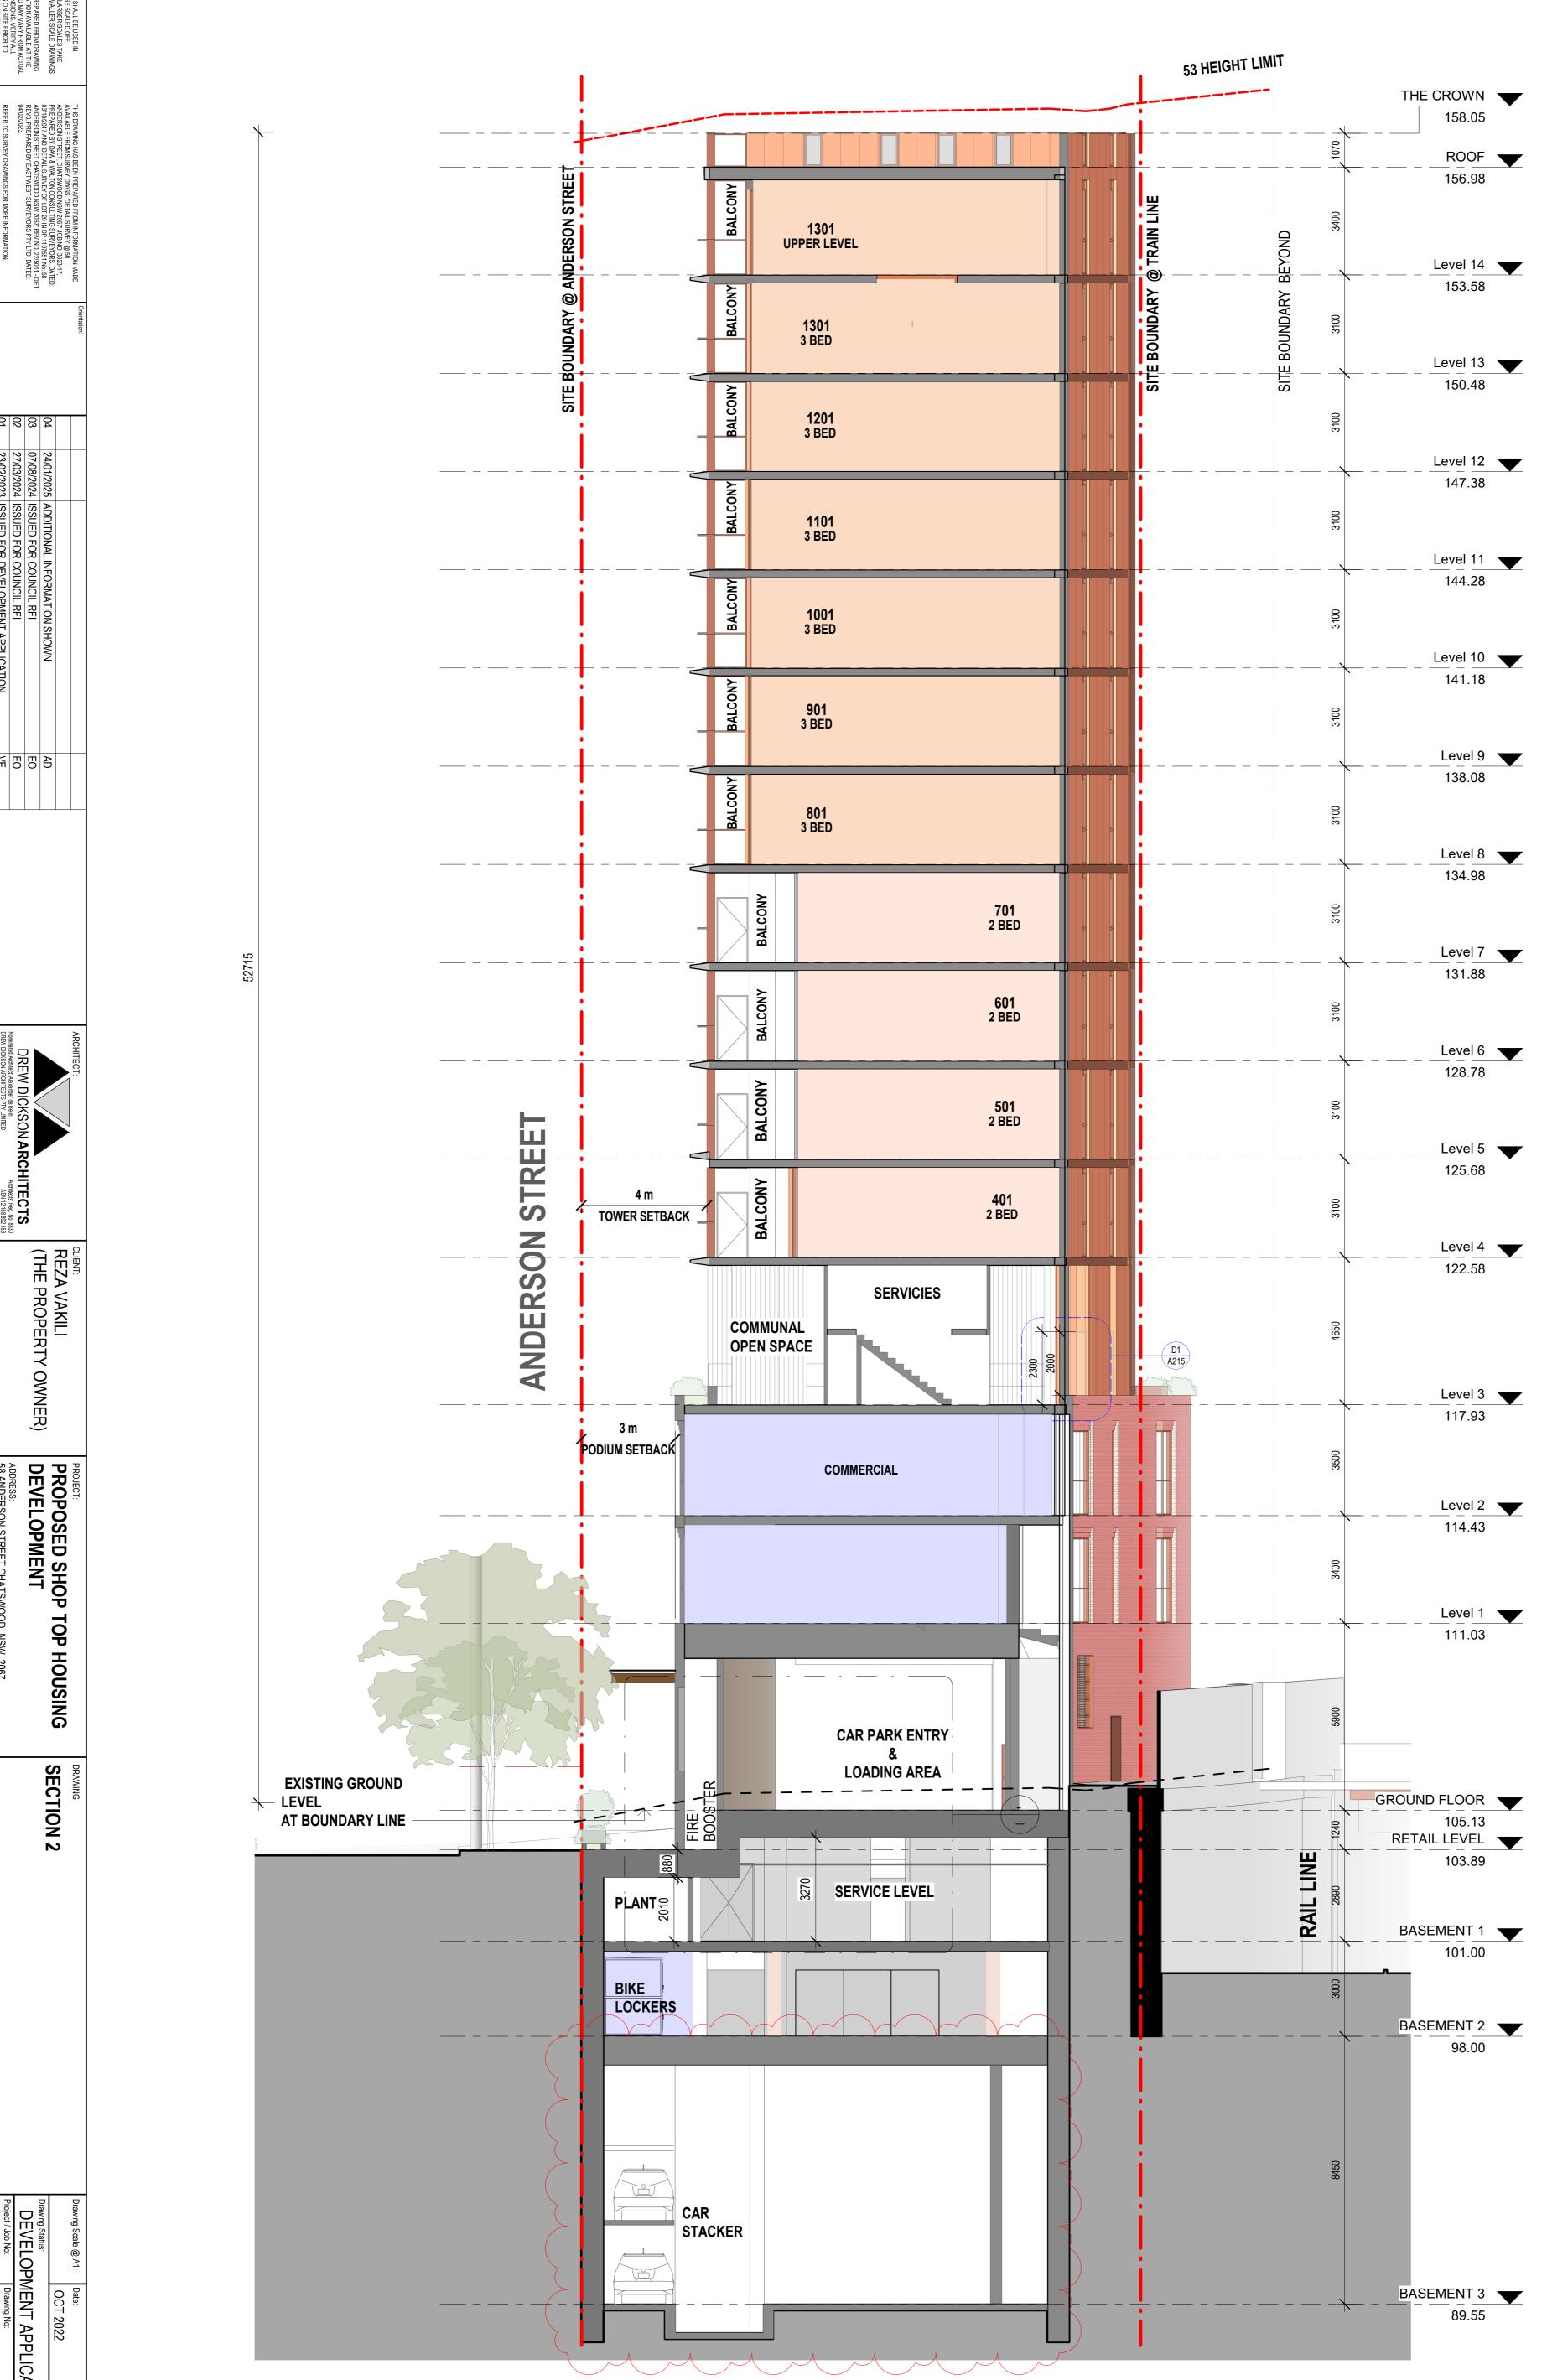


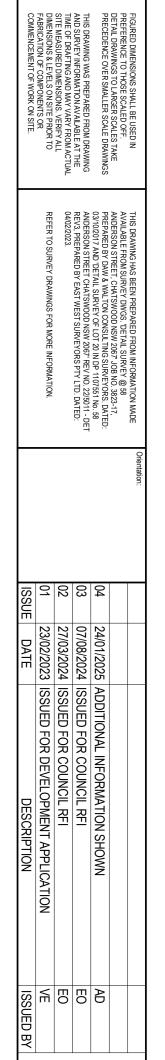


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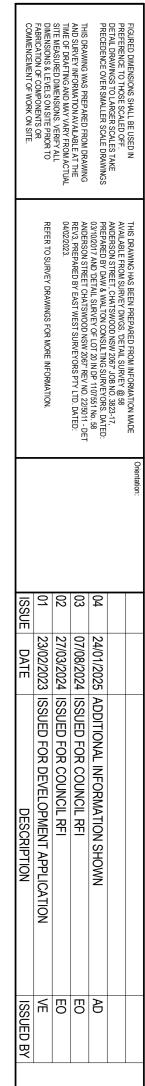
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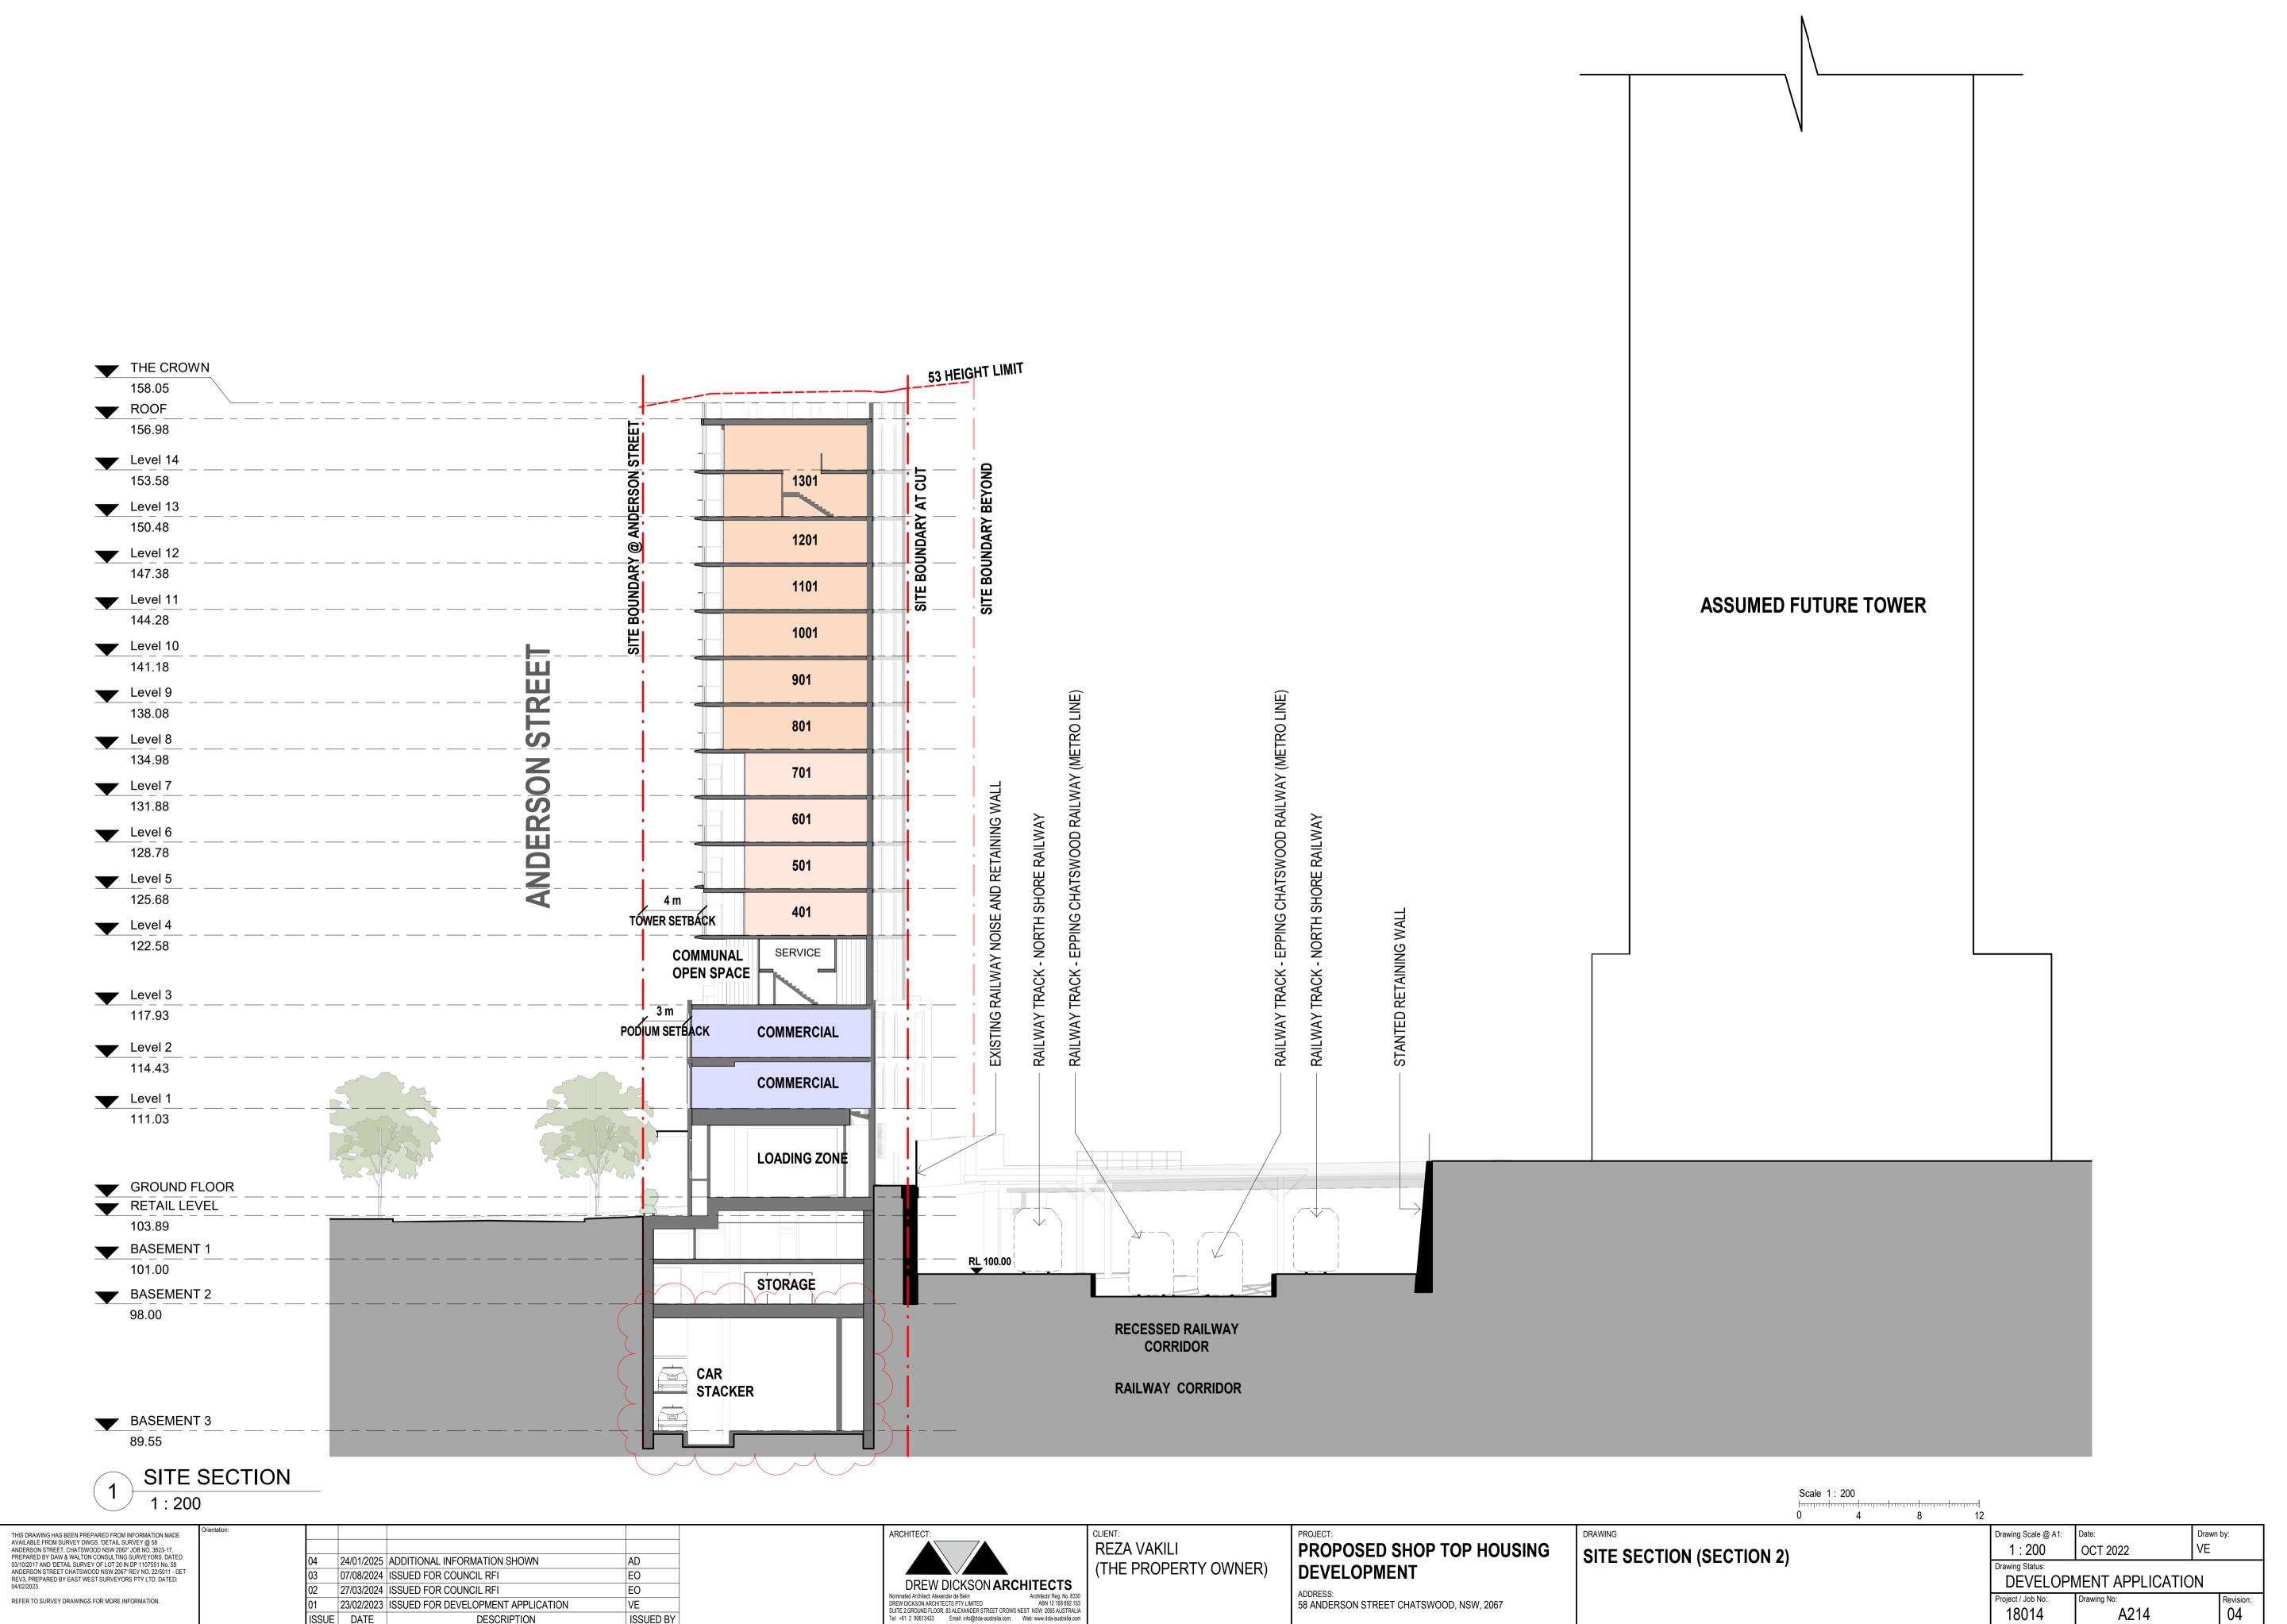
ADDRESS: 58 ANDERSON STREET CHATSWOOD, NSW, 2067



_	Proje		Drawi	
18014	Project / Job No:	EVELOPN	Drawing Status:	
A212	Drawing No:	DEVELOPMENT APPLICATION		OCT 2022
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04	Revision			

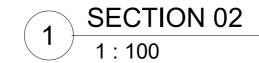



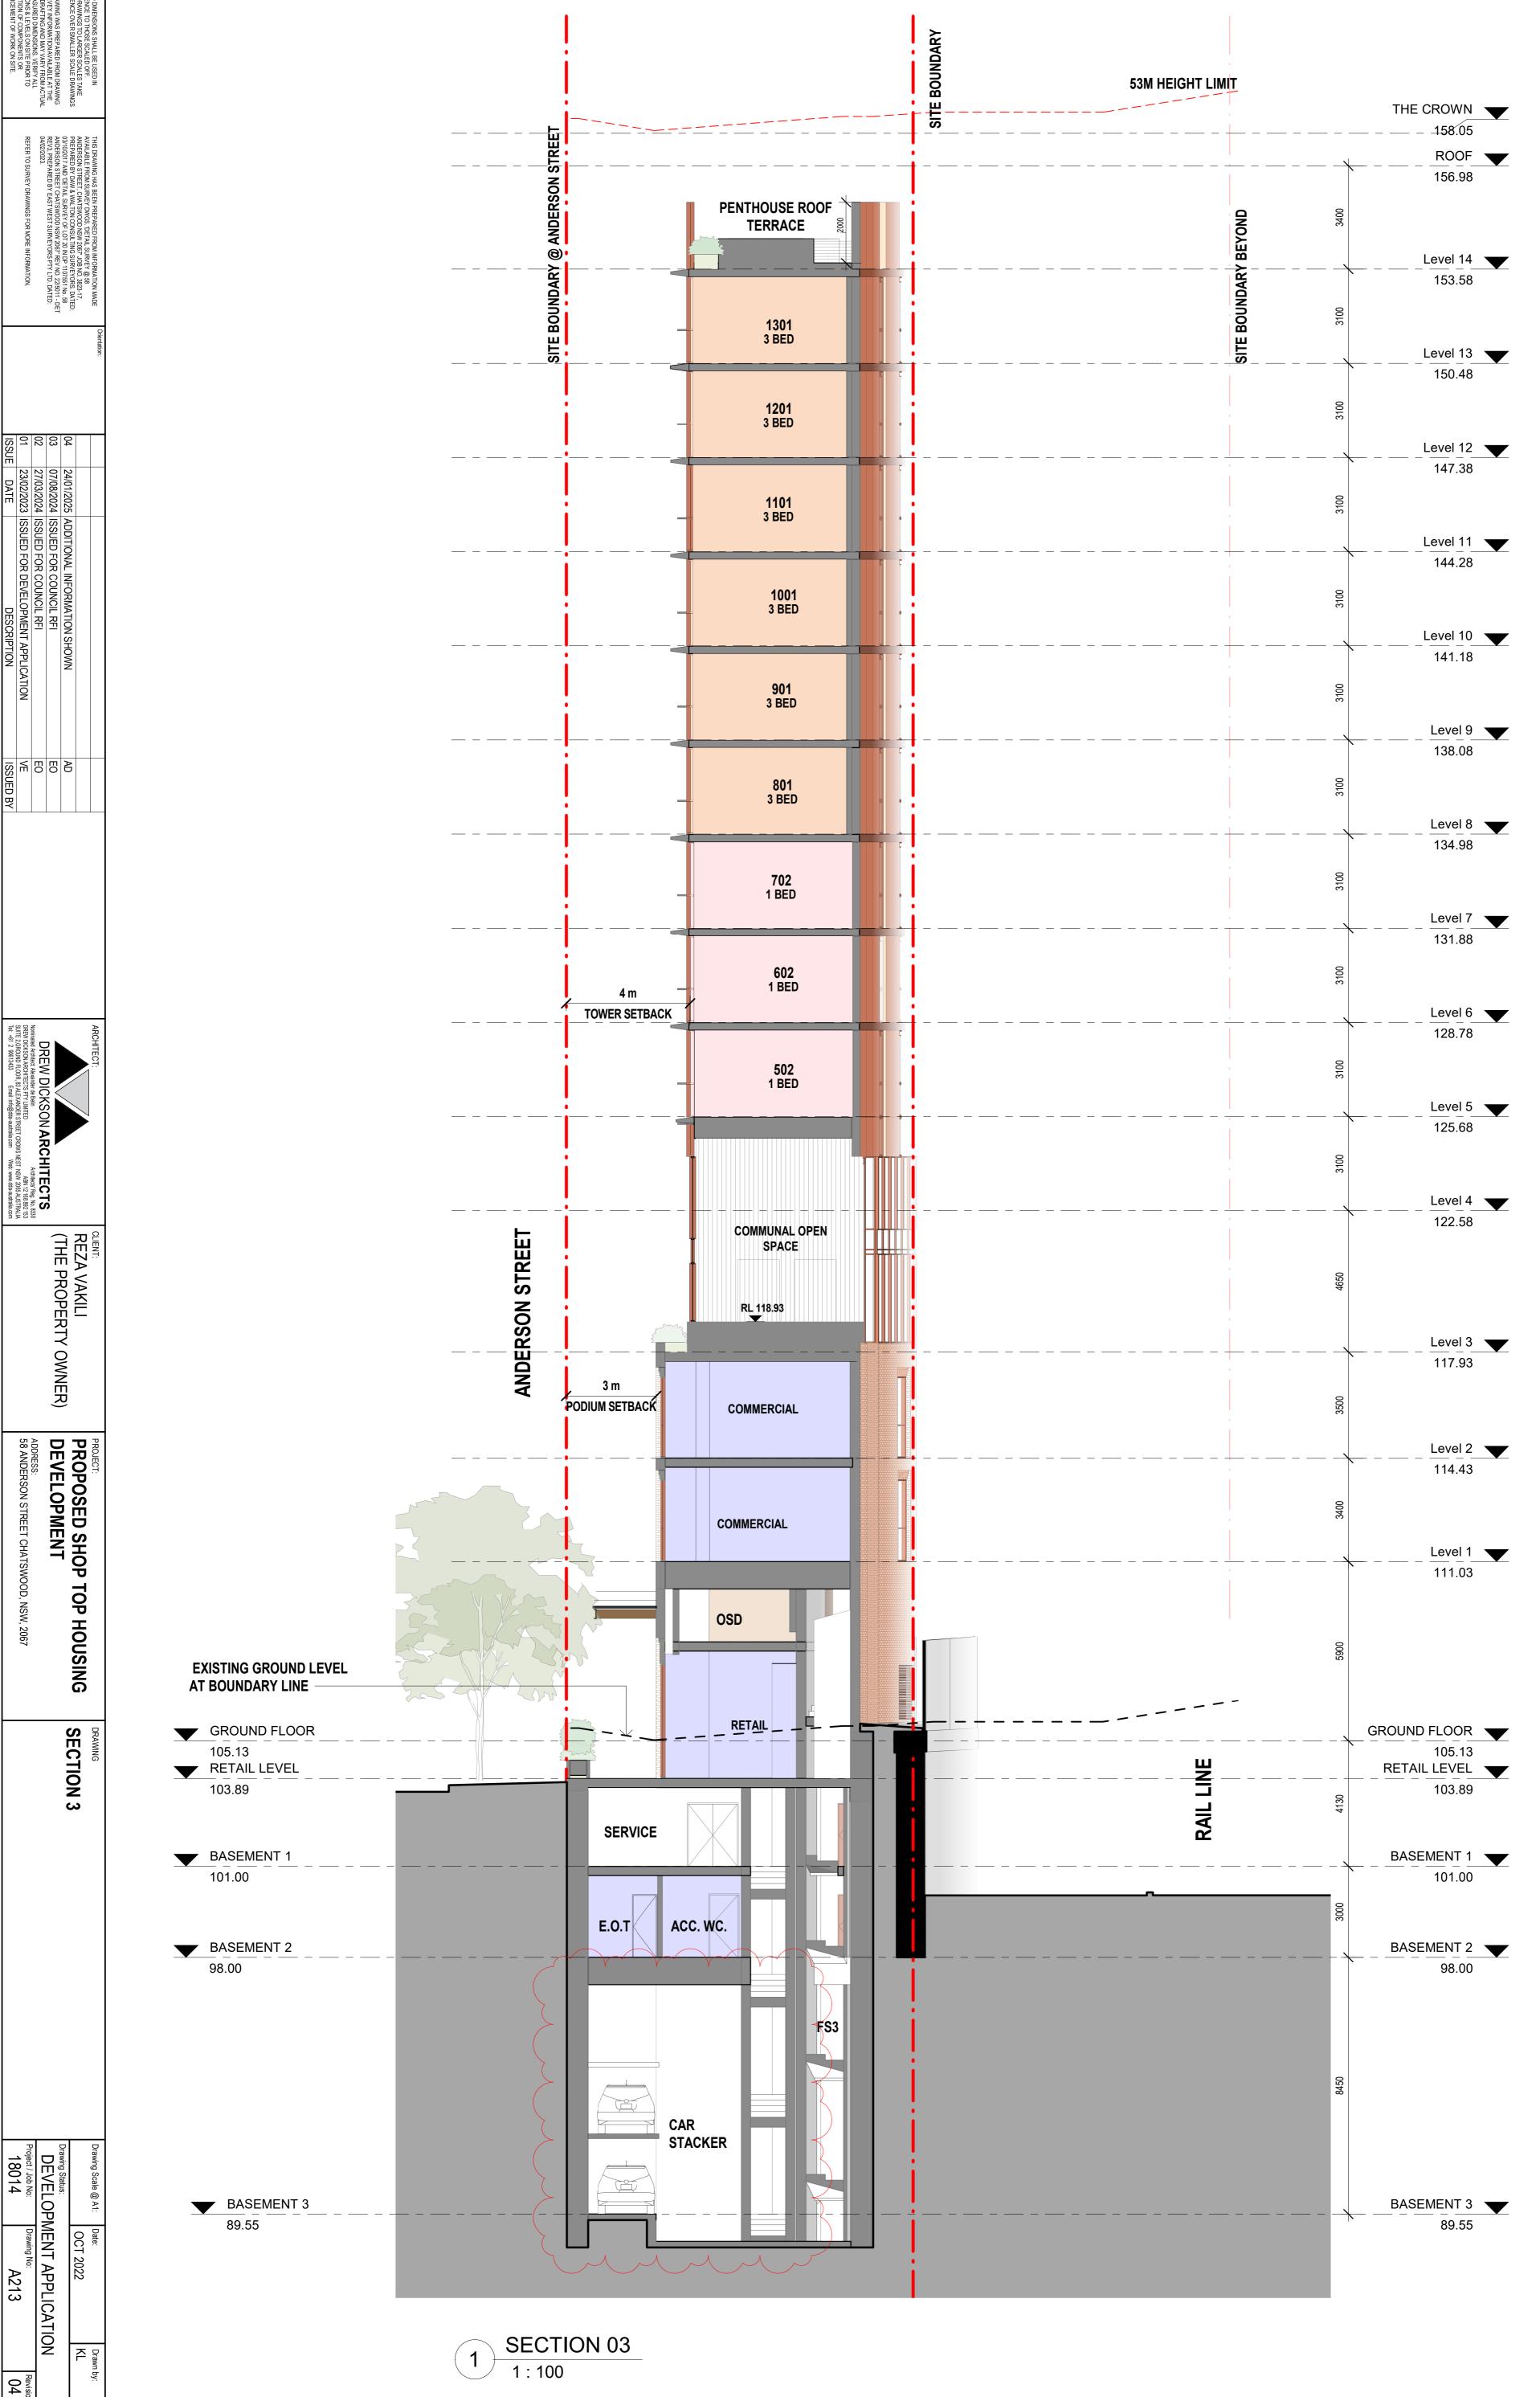

ARCHITECT: ARCHITECT: DREW DICKSON ARCHITECTS DREW DICKSON DREW DICKSON ARCHITECTS DREW DICKSON DREW DICKSON ARCHITECTS DREW DICKSON ARCHITECTS DREW DICKSON ARCHITECTS DREW DICKSON DREW				
	DREW DICKSON ARCHITECTS Nominated Architect: Alexander de Belin DREW DICKSON ARCHITECTS PTY LIMITED ABN 12 108 892 153 SUITE 2,GROUND FLOOR, 83 ALEXANDER STREET CROWS NEST NSW 2065 AUSTRALIA	REZA VAKILI	PROPOSED SHOP TOP HOUSING DEVELOPMENT ADDRESS:	


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ISSUE DATE


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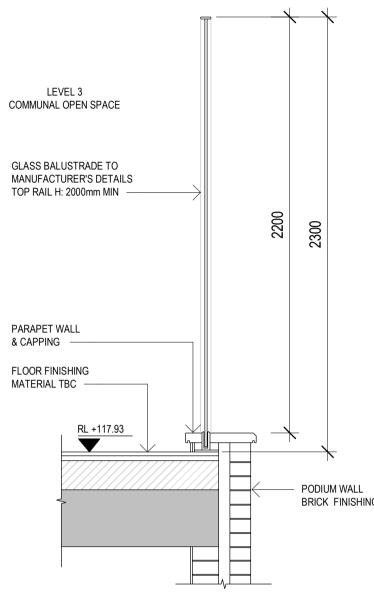
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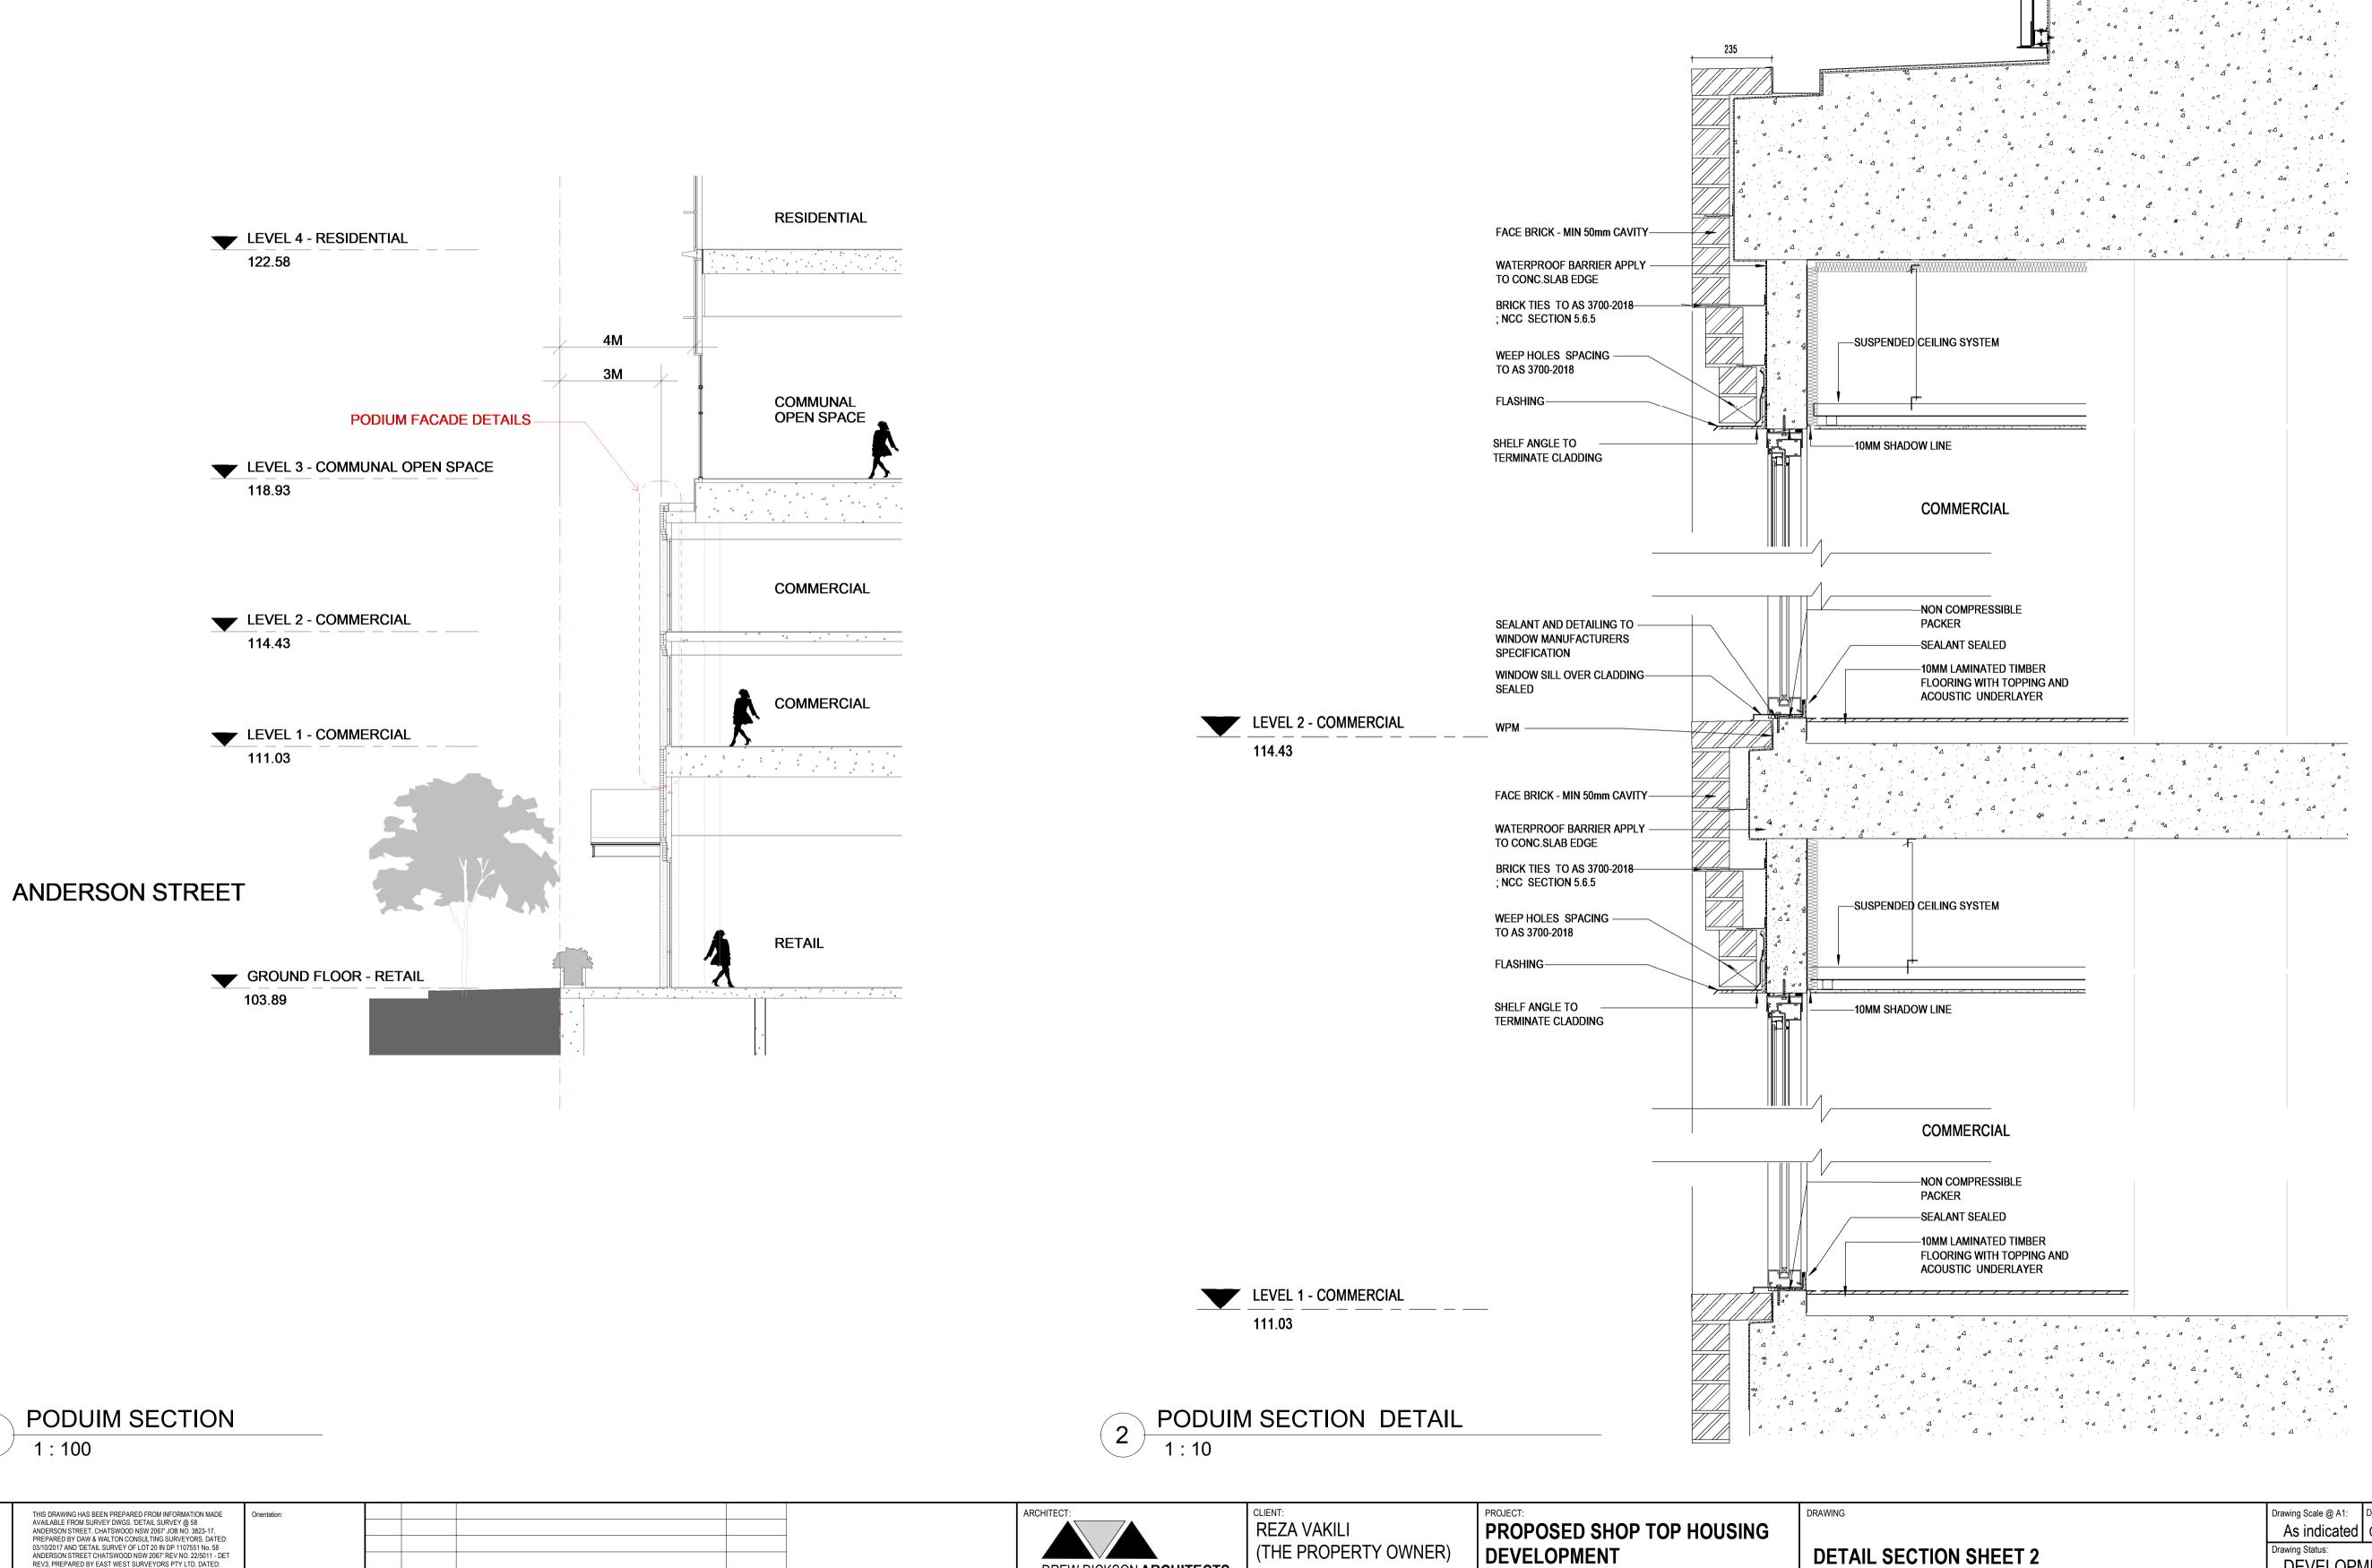
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PRECEDENCE OVER SMALLER SCALE DRAWINGS	NGS PREPARED BY DAW & WALTON CONSULTING SURVEYORS. DATED: 03/10/2017 AND 'DETAIL SURVEY OF LOT 20 IN DP 1107551 No. 58 NG ANDERSON STREET CHATSWOOD NSW 2067' REV NO. 22/5011 - DET E REV3, PREPARED BY EAST WEST SURVEYORS PTY LTD. DATED:		04	24/01/2025	ADDITIONAL INFORMATION SHOWN	AD	
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	Drawing Scale @ A1: Date: Drawn by: As indicated OCT 2022 EO				
ION	Drawing Status: DEVELOPMENT APPLICATION				
	Project / Job No: 18014	Drawing No: A218	Revision: 04		



DREW DICKSON ARCHITECTS

Nominated Architect: Alexander de Belin Architects' Reg. No. 8330 DREW DICKSON ARCHITECTS PTV LIMITED ABN 12 168 892 153 SUITE 2,GROUND FLOOR, 83 ALEXANDER STREET CROWS NEST NSW 2065 AUSTRALIA Tel: +61 2 90613433 Email: info@dda-australia.com Web: www.dda-australia.com

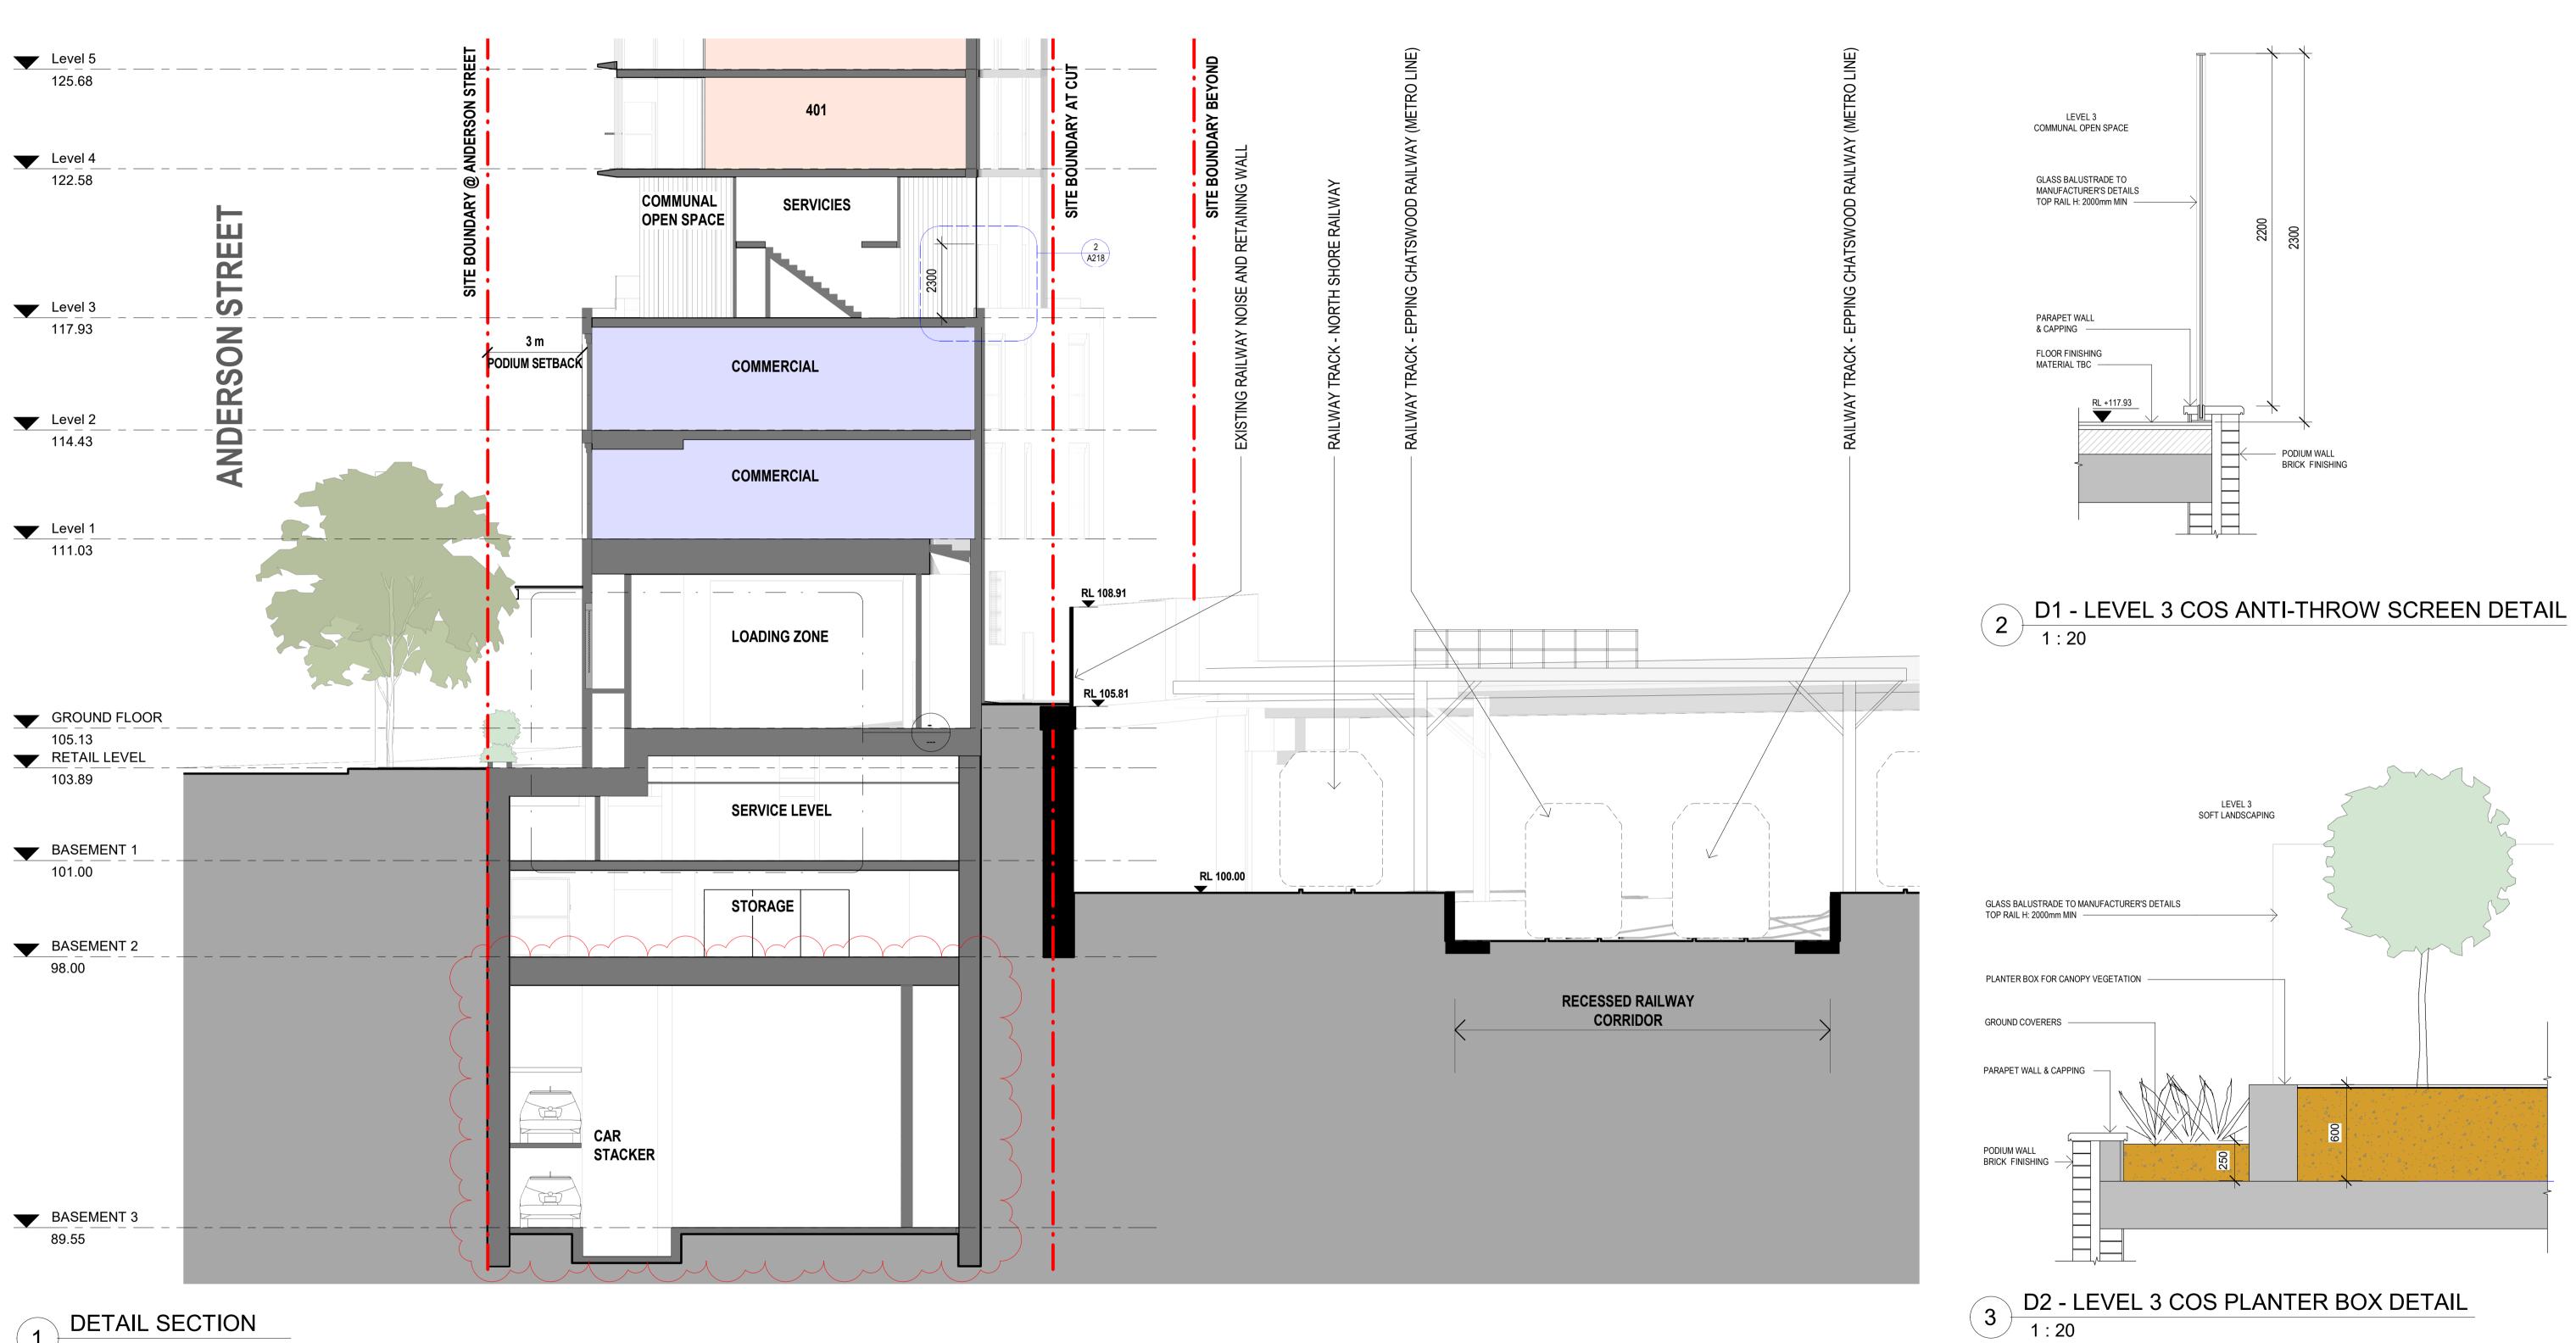ADDRESS:

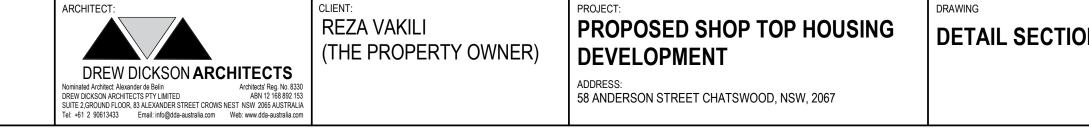58 ANDERSON STREET CHATSWOOD, NSW, 2067



FIGURED DIMENSIONS SHALL BE USED IN PREFERENCE TO THOSE SCALED OFF.	THIS DRAWING HAS BEEN PREPARED FROM INFORMATION MADE AVAILABLE FROM SURVEY DWGS. 'DETAIL SURVEY @ 58	Orientation:				
DETAIL DRAWINGS TO LARGER SCALES TAKE	ANDERSON STREET, CHATSWOOD NSW 2067' JOB NO. 3823-17,					
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AND SURVEY INFORMATION AVAILABLE AT THE	REV3, PREPARED BY EAST WEST SURVEYORS PTY LTD. DATED:					
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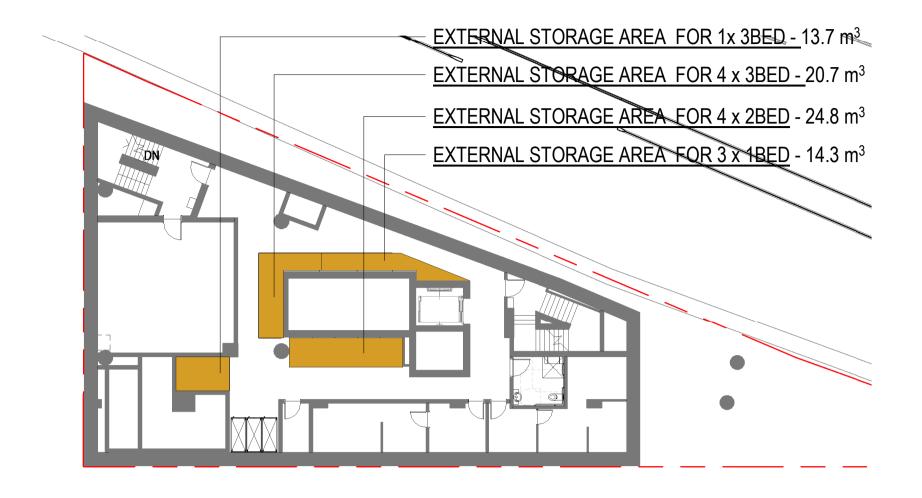
LEVEL 3 - COMMUNAL OPEN SPACE \_\_\_\_\_ 118.93

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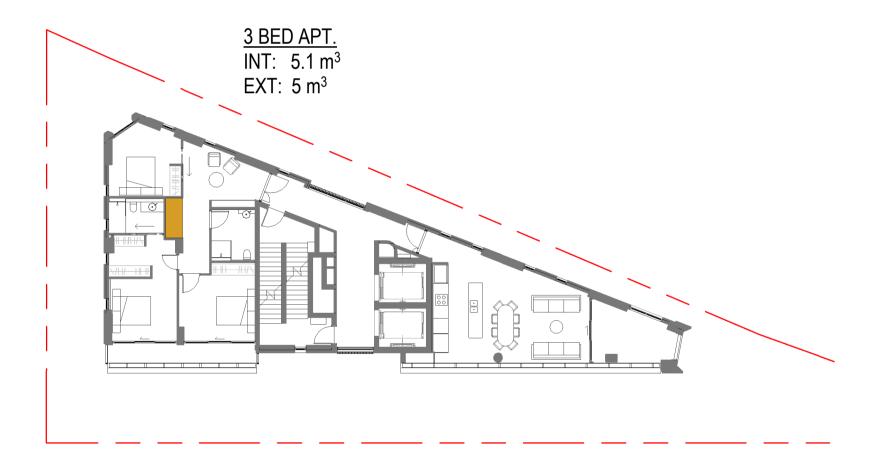
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TION SHEET 2	Drawing Status: DEVELOPMENT APPLICATION			
	Project / Job No: 18014	Drawing No: A219	Revision:	

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LINE						

COMMUNAL OPEN SPACE 












FIGURED DIMENSIONS SHALL BE USED IN PREFERENCE TO THOSE SCALED OFF. DETAIL DRAWINGS TO LARGER SCALES TAKE PRECEDENCE OVER SMALLER SCALE DRAWINGS THIS DRAWING WAS PREPARED FROM DRAWING AND SURVEY INFORMATION AVAILABLE AT THE TIME OF DRAFTING AND MAY VARY FROM ACTUAL SITE MEASURED DIMENSIONS. VERIEY ALL DIMENSIONS & LEVELS ON SITE PRIOR TO FABRICATION OF COMPONENTS OR	THIS DRAWING HAS BEEN PREPARED FROM INFORMATION MADE AVAILABLE FROM SURVEY DWGS. 'DETAIL SURVEY @ 58 ANDERSON STREET, CHATSWOOD NSW 2067' JOB NO. 3823-17, PREPARED BY DAW & WALTON CONSULTING SURVEYORS. DATED: 03/10/2017 AND 'DETAIL SURVEY OF LOT 20 IN DP 1107551 No. 58 ANDERSON STREET CHATSWOOD NSW 2067' REV NO. 22/5011 - DET REV3, PREPARED BY EAST WEST SURVEYORS PTY LTD. DATED: 04/02/2023. REFER TO SURVEY DRAWINGS FOR MORE INFORMATION.
FABRICATION OF COMPONENTS OR COMMENCEMENT OF WORK ON SITE.	

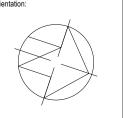


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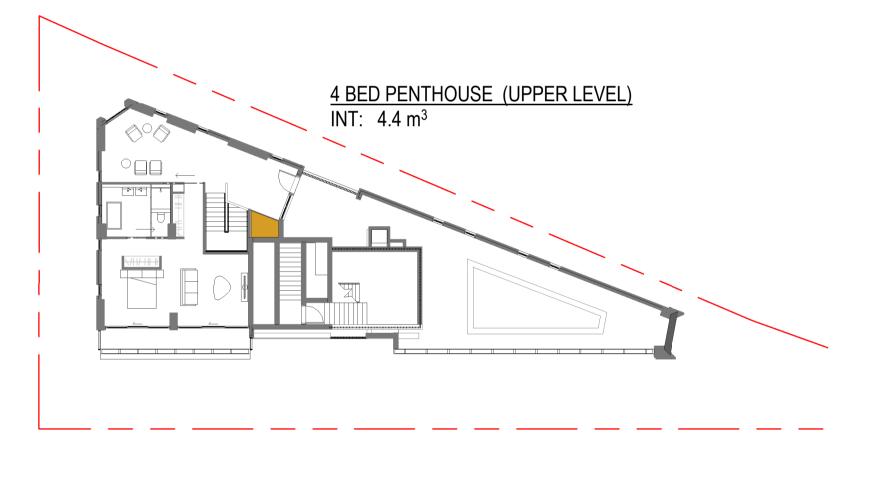


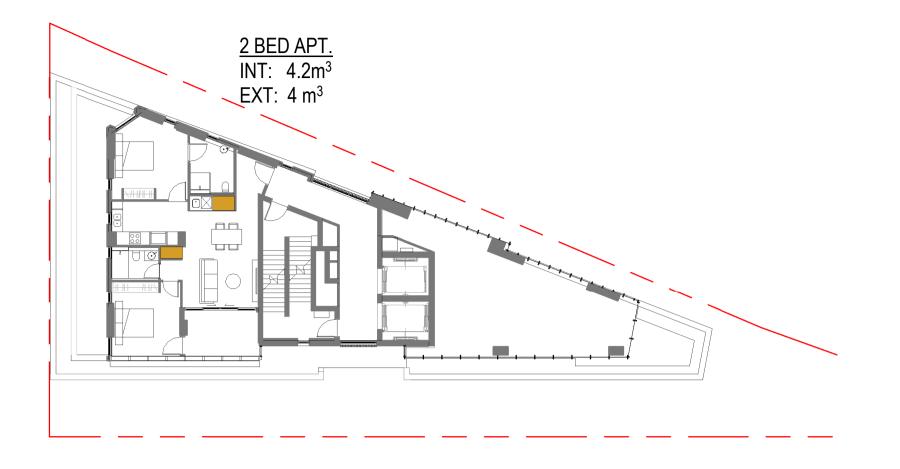

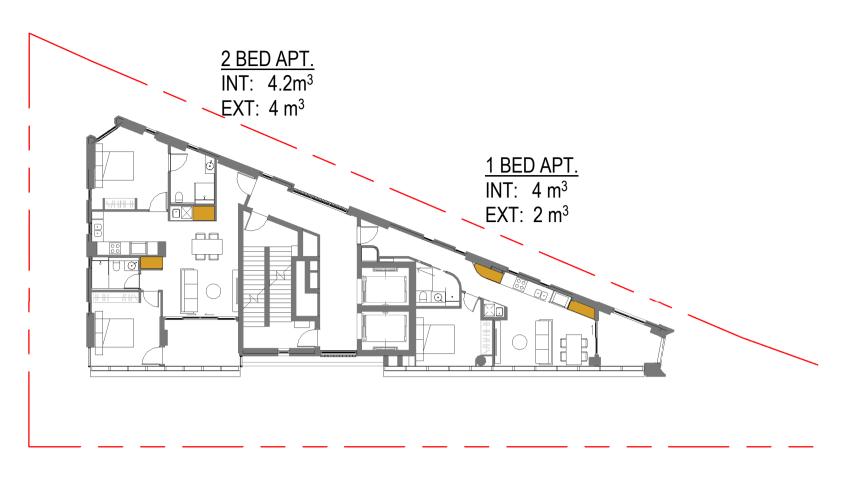
2 LEVEL 4 Plan 1 : 200





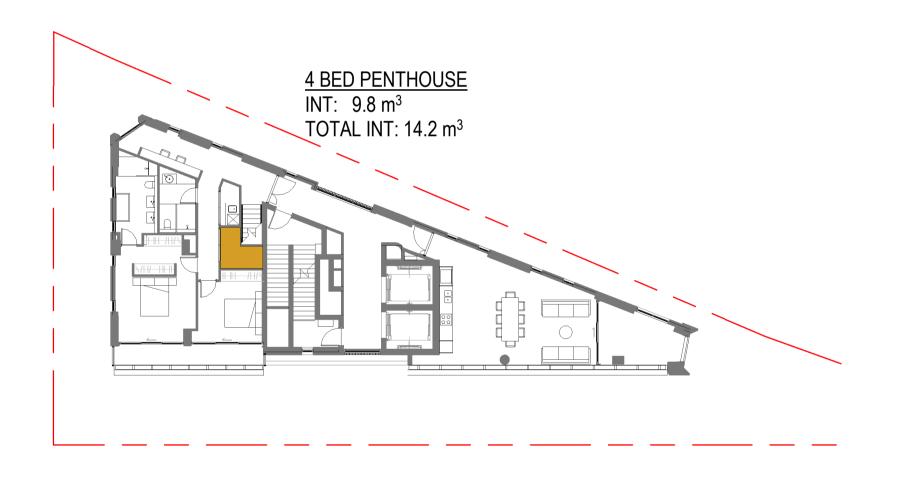

5 LEVEL 13 Plan 1 : 200

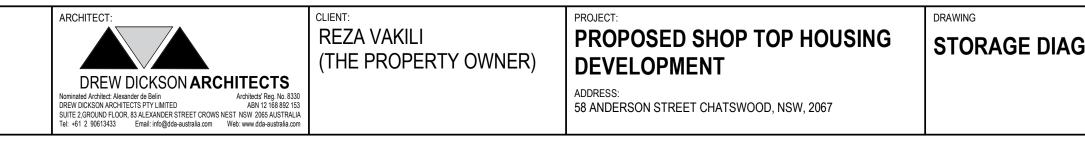


8 LEVEL 14 Plan 1 : 200

LEGEND:


**TOTAL 13 UNITS** INTERNAL STORAGE PER UNIT 50% **EXTERNAL STORAGE PER UNIT 50%** 

STORAGE

		1:200 	·····					
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					Drawing Status: DEVELOPI	MENT APPLIC	ATION	
					Project / Job No: 18014	Drawing No: A308		Revision: 02

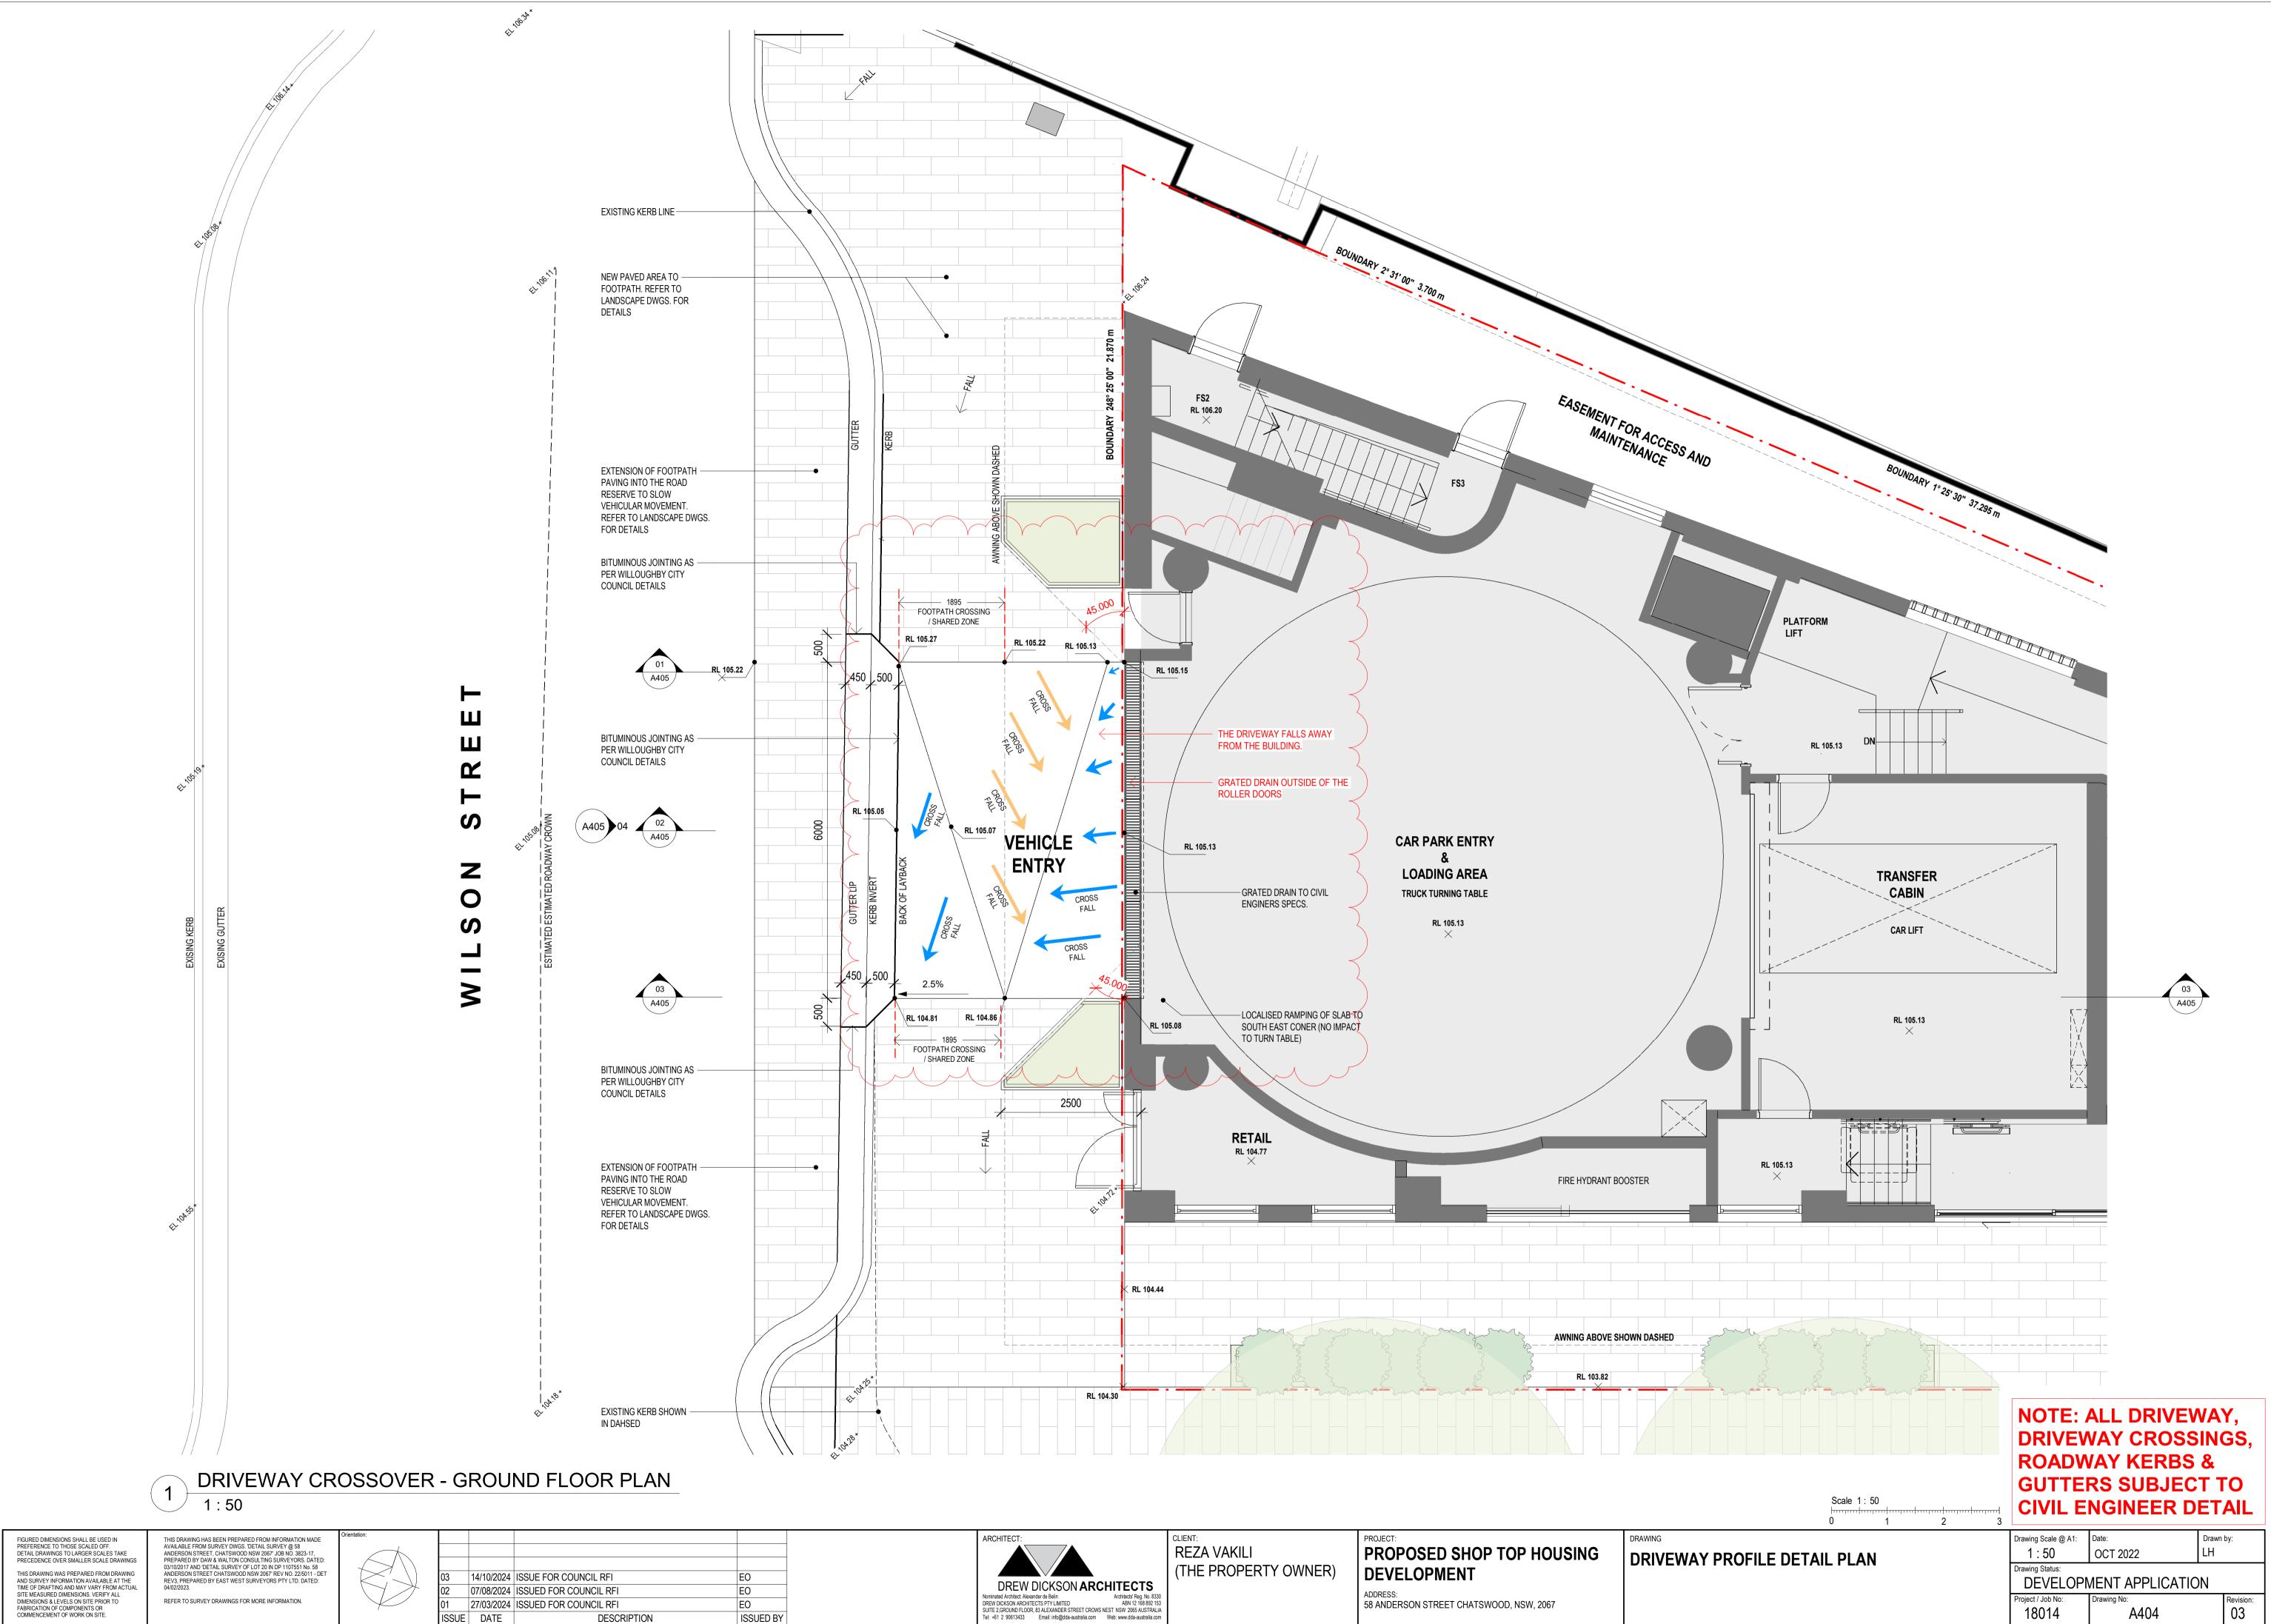

ARCHITECT: CLIENT: DREW DICKSON ARCHITECTS Nominated Architect. Ackender de Belin DREW DICKSON ARCHITECTS PILINTED ARCHITECTS PROJECT: THE PROPERTY OWNER) CLIENT: REZA VAKILI (THE PROPERTY OWNER) ABN 12 168892 153 SM ADDRESS: 58 ANDERSON STREET CHATSWOOD, NSW, 2067
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# 58 ANDERSON STREET, CHATSWOOD, NSW
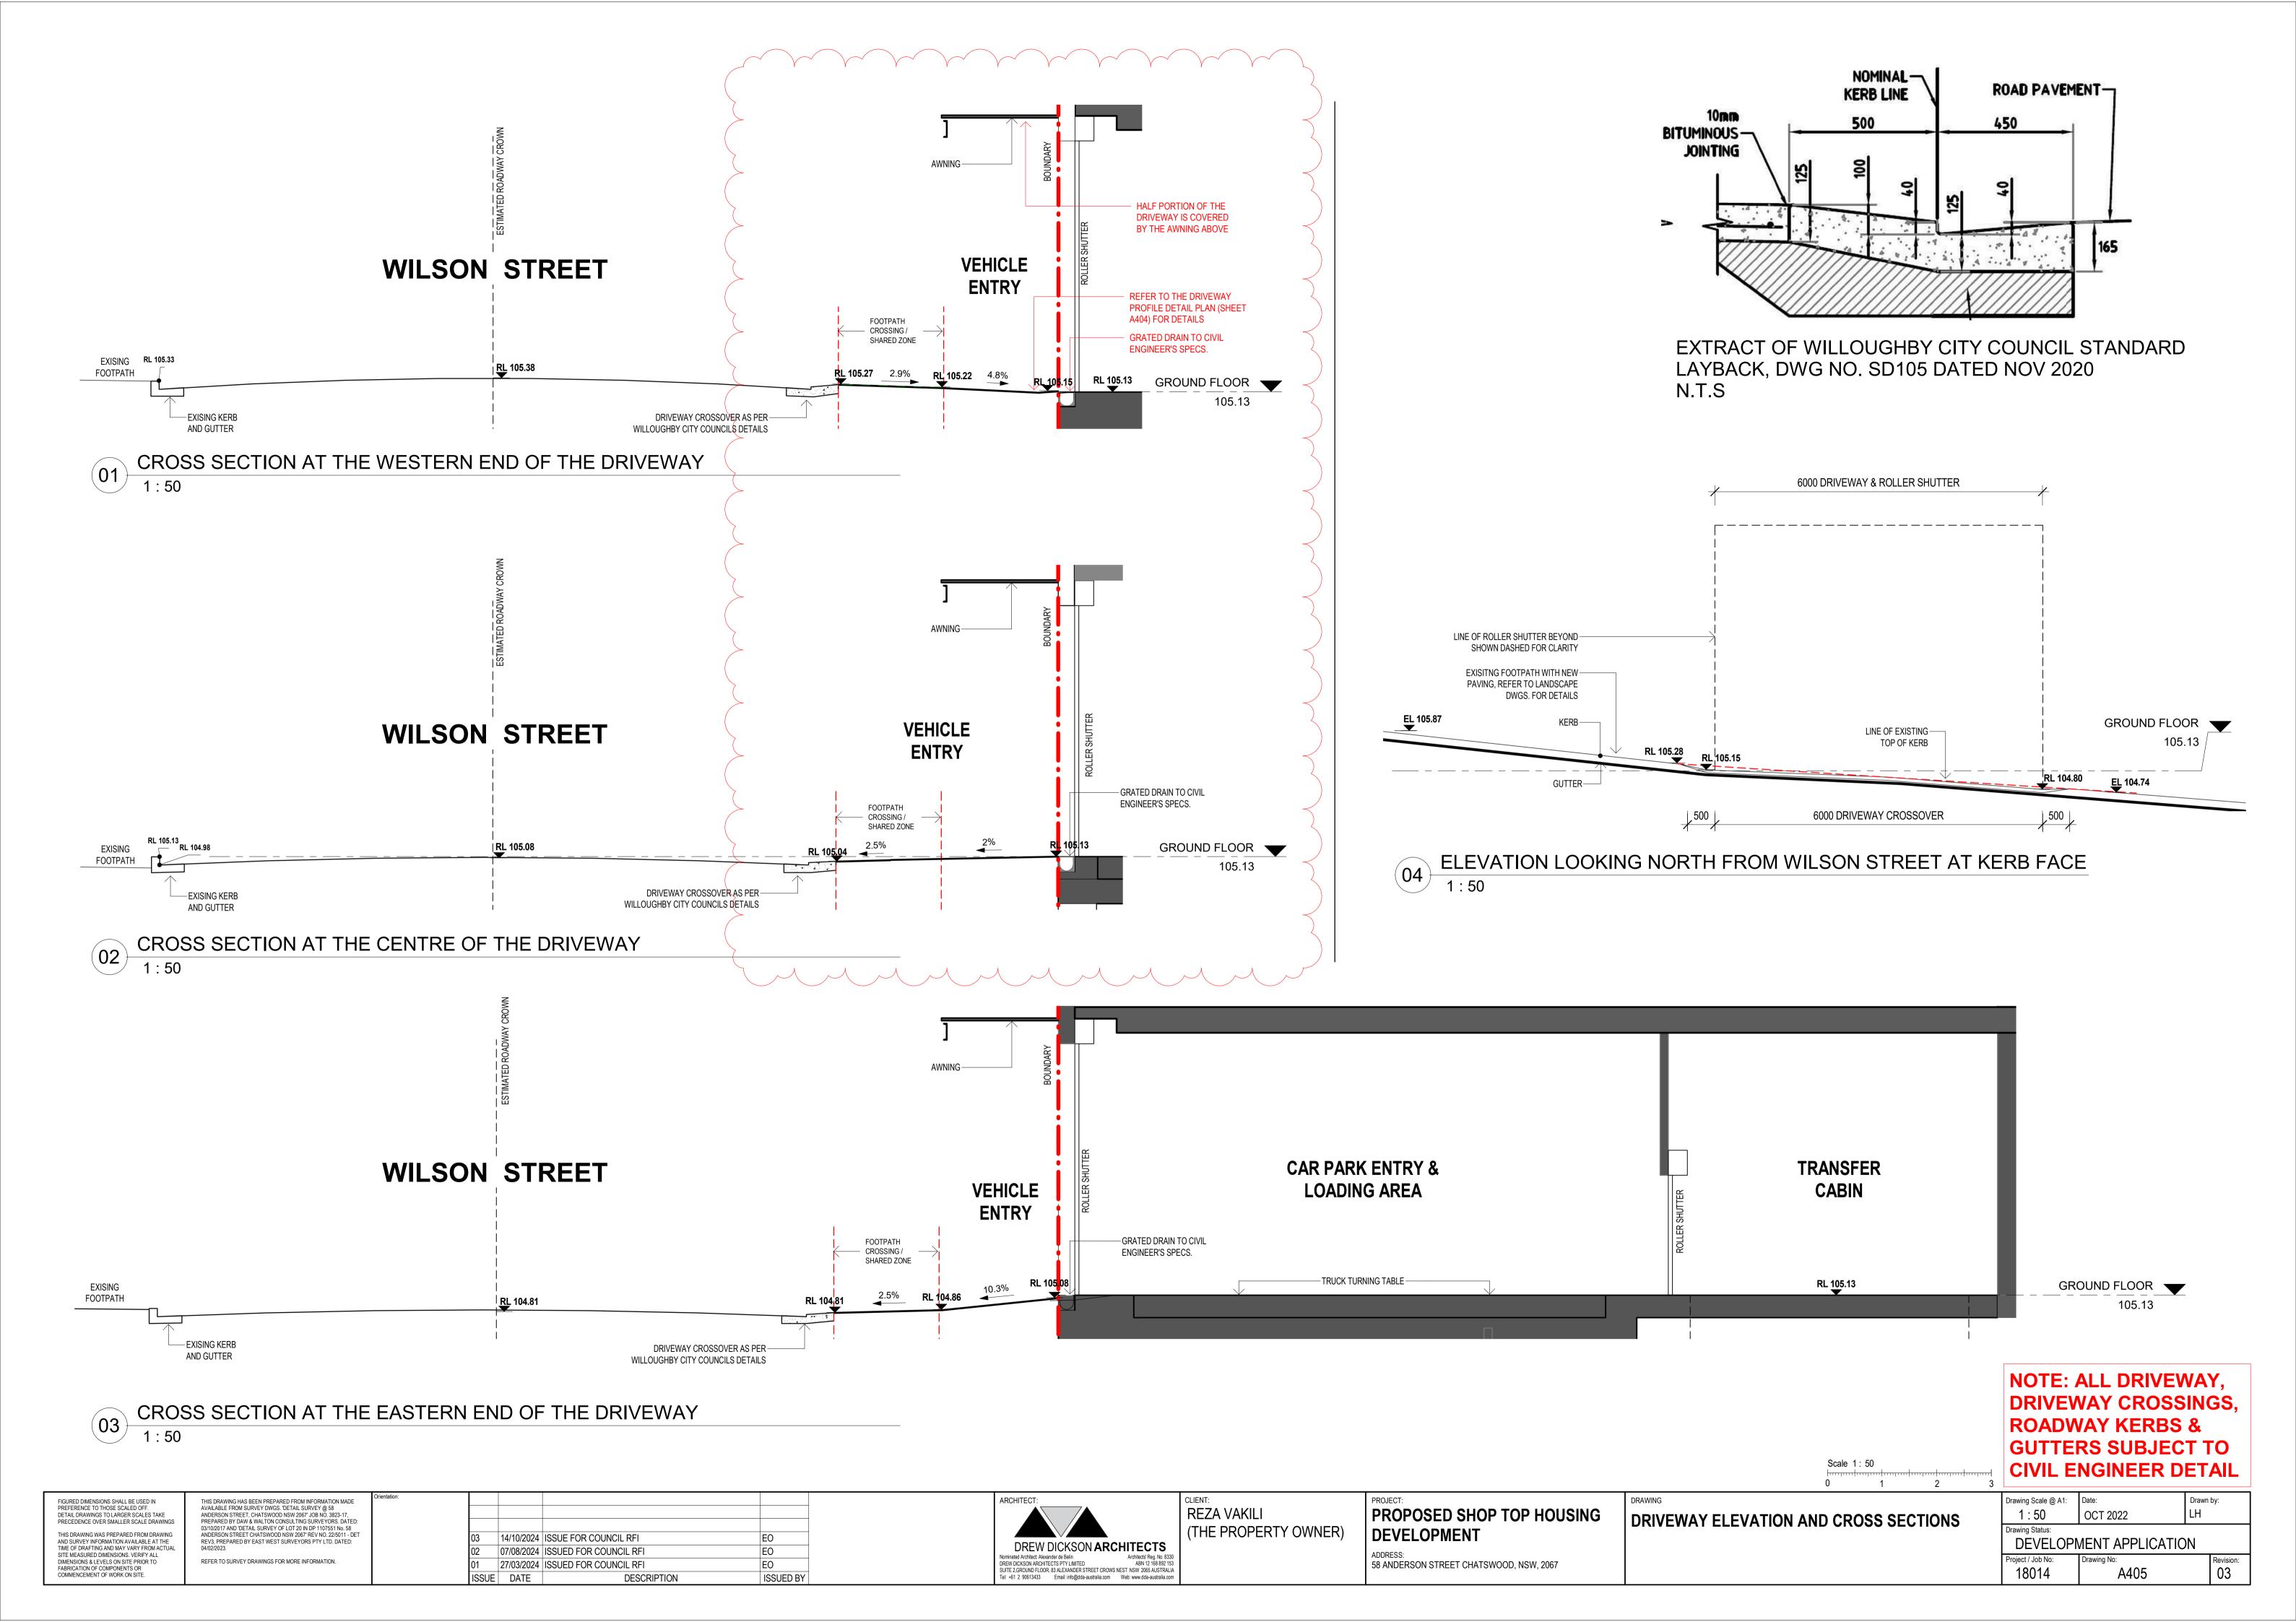
# DEVELOPMENT APPLICATION LANDSCAPE DRAWINGS

# 2022015: LANDSCAPE ARCHITECTURAL DRAWING LIST

Sheet Number	Sheet Name	Revision
LD-DA000	COVER SHEET & DESIGN STATEMENT	1
LD-DA001	MATERIALS & PLANTING SCHEDULES	1
LD-DA100	GROUND FLOOR AND PUBLIC DOMAIN LANDSCAPE PLAN	1
LD-DA101	LEVEL 3 LANDSCAPE PLAN	1
LD-DA102	LEVEL 14 LANDSCAPE PLAN	1
LD-DA200	LANDSCAPE CHARACTER	1
LD-DA300	TYPICAL SECTIONS	1
LD-DA900	OUTLINE SPECIFICATION & MAINTENANCE	1

#### NOTE

 DO NOT SCALE FROM DRAWINGS. WRITTEN DIMENSIONS GOVERN. IF IN DOUBT OBTAIN WRITTEN ADVICE FROM LANDFORM OR WHER APPLICABLE VIA THE PRINCIPAL'S REPRESENTATIVE

ALL DIMENSIONS ARE IN MILLIMETRES UNLESS OTHERWISE STATED ALL DIMENSIONS ARE MINIMUM SETTING OUT REQUIREMENTS

 ALL DIMENSIONS SHOULD BE VERIFIED ON SITE PRIOR TO PROCEEDING WITH THE WORKS. NOTIFY THE PRINCIPALS REPRESENTATIVE IN WRITING OF ANY DISCREPANCIES

 ALL LANDSCAPE DRAWINGS MUST BE READ IN CONJUNCTION WITH RELEVANT CONTRACTS, ARCHITECTURAL REPORTS, SCHEDULES AND SPECIFICATIONS AND ALL OTHER CONSULTANT / CONTRACT DOCUMENTATION. NOTIFY THE PRINCIPALS REPRESENTATIVE OF ANY DISCREPANCIES BETWEEN DOCUMENTATION IN WRITING TO OBTAIN CLARIFICATION DIRECTION

 INSTALLATION OF SYSTEMS AND PROPRIETARY PRODUCTS TO BE STRICTLY IN ACCORDANCE WITH MANUFACTURERS RECOMMENDATIONS.

• ALL WORK TO COMPLY WITH THE NATIONAL CONSTRUCTION CODE INCLUDING RELEVANT AUSTRALIAN STANDARDS AND REQUIREMENTS OF THE BUILDING CODE OF AUSTRALIA AND AUSTRALIAN WORK HEALTH AND SAFETY LEGISLATION.

• DESIGN DRAWINGS ARE BASED ON SURVEY INFORMATION. PRIOR TO DETAILED DESIGN AND CONSTRUCTION, THE CONTRACTOR IS TO UNDERTAKE A FULL SURVEY TO VERIFY ALL DIMENSIONS AND CONFIRM LOCATION OF EXISTING SERVICES

1	DEVELOPMENT APPLICATION	RI	CR	CR	16.02.23
-	PRE DA	RI	CR	CR	18.10.22
No	Revision Note: * indicates signatures on original issue of drawing or last revision of drawing	Drawn	Job Manager	Project Director	Date

Plot Date: 28 February 2023 - 1:43 PM Plotted by: Charlie Robinson



## SITE CONTEXT PLAN - NTS

# LANDSCAPE DA DESIGN STATEMENT

#### Objectives

- to increase the number of indigenous species planted in the Willoughby City Council region
- to eliminate the use of noxious weeds of potentially invasive species in developments to use plants in such a way to foster energy efficient development that relies on passive energy principles for heating and cooling
- to reduce maintenance and water consumption through appropriate species selection
- to create buffer zones and add to existing areas of remnant vegetation with locally indigenous species.

#### Principles

- Enhance the appearance and amenity of the proposed residential development by sensitively integrating architecture and landscape through effective site planning and landscape design.
- Consolidate the open space into a coherent landscape treatment that provides visual amenity from above an below.
- Take forward the landscape principles and urban design principles established by the Willoughby City Council DCP Establish a visually and environmentally sensitive landscape, complimentary to the architectural vision and greater urban setting, while providing high quality private spaces for residents and visitors.
- Provide new tree planting that ameliorates the building scale and offers environmental benefit through micro climate Create a garden terrace with both integrated seating areas

#### Public Domain & Streetscapes

An upgrade and make-good of the public domain and associated streetscapes is included as part of the development offer to ensure seamless transitions throughout the ground plane. The ground plane is publicly accessible and offers a high quality civic environment with active retail frontages

#### Access, Egress & Connectivity

The through site link acts as the central connectivity spine with finer grain permeability promoted throughout the ground plane maximising access and circulation. All fire exits are located near or adjacent to key pathways, pedestrian links and streetscapes promoting safe egress and evacuation if and when required.

#### CPTED, Safety & Visibility

All raised edges & planter walls are at seating height or lower allowing clear sight-lines and visibility throughout the ground plane. Trees are used to frame spaces and ensure clear visibility to and from the streetscape at all times. Regular congregation spaces and retail activation enables passive surveillance to all areas, discouraging undesired behaviour and possible blind spots.

#### Universal Access & DDA Compliance

The ground plane offers full universal accessibility to all reception, lobby and retail areas at maximum 1:14 grades have been implemented to ensure access for all is achieved.

#### Soil Depths on Podiums & Permanent Planting

All planters have a minimum soil depth of 600mm with a minimum 150mm slab setdown achieved throughout all landscaped areas in the development. This allows planter walls to be at seating height with additional 1:3 mounding to achieve soil depth for small trees where shown on plan. All noted planted areas in the design is permanent planting

#### Deep Soil & planter areas

• Ground Floor 46m2 of Deep soil planting + 18m2 Raised planter

- Level 3 81m2 raised planter
- Penthouse 32m2 raised planter
- 20m2 Total Planter box for vine growth for green façade.

	ARCHITECT	LANDSCAPE	DO NOT SCALE	Drawn RI	Designer CR/ RI	Client	F
	DREW DICKSON		Conditions of Use.	Drafting Check CR	Design Check CR	Project	5
Y LTD		LAND	This document may only be used by the	Approved (Project Director)		Title	С
	ARCHITECTURE	FORM	client has agreed can use this document)	Date			
		Studios	for the purpose for which it was prepared and must not be used by any other person or for any other purpose.	Scale	This Drawing must not be used for Construction unless signed as Approved	Original Size	



**REYHODA PTY LTD** Client Project 58 ANDERSON STREET, CHATSWOOD **COVER SHEET & DESIGN STATEMENT** Title

Drawing No: LD-DA000

Rev: 1


		CODE	MATERIAL TYPE	DESCRIPTION
/	Site Boundary			
	Basement Extents	SURFACES & F	INISHES	
F.	Evisting levels, where the standard	P1	Paving type 1: Large format Stone paverss in	To Council Standards
	Existing levels: refer to site survey		public domain to Council standards. Application: To Public Domain Footpaths	Note: Subbase to Engineers details. Paving mortar bedded onto concr
~	Proposed nominal design levels: refer to engineers drawings	P2	Paving type 2: Small format Stone pavers in public domain to Council standards.	* Engineer to confirm thickness of unit To Council Standards
	Proposed trees - refer to planting schedule		Application: To Public Domain Footpaths	Note: Subbase to Engineers details. Paving mortar bedded onto concr * Engineer to confirm thickness of unit
200000	Proposed planting - refer to planting schedule			
000000	Raised planter area - Planter Depths to ADG standards	P3	Paving type 3: Decomposed Granite gravel Application: To Ground Plane	Note: Subbase to Engineers details. * Engineer to confirm thickness of unit
	Paving type 1: To public domain to Council standards			
	Paving Type 2: To Driveways to Council standards	P4	Paving type 4: Sandstone flagging in groundcovers	Note: Subbase to Engineers details. * Engineer to confirm thickness of unit
	Paving Type 3 : Decomposed granite		Application: to internal areas	
4	Paving Type 4 : Stone Steppers in	P5	Paving type 5: Concerte pavers	Various sizes - laid on pedestals Mid and ligh grey in colour
	groundcover		Application: To Communal Rooftops	
5	Paving Type 5 : COS - podium paving	TD	Timber Decking	Size: 137mm x 27mm x 54mm Colour: Sahara
TD	Hardwood Timber Deck		Application: To Communal Rooftops	Finish: Brushed
61	Seating to Council standards			Note: Placed on pedestals.
BN	Bin to Council standards	G1	Decorative Gravel	Size: 20-40mm Colour: Nepean River Pebble
BR	Bike Racks to Council standards		Application: To Communal Rooftops	Finish: N/A
ne	eral Notes:	SF	Rubber Softfall	Size: N/A
r S	Site levels and architectural information refer vil and Architects drawings respectively.	Sr.	Application: To Level 9 Outdoor Gym Area	Colour: Varied Finish: Exposure Grade
20	courtyard and overflow drainage refer to aulic engineers drawings			
	ees to be retained and are subject to tree	WALLS, FURNI	TURE AND FIXINGS	
ote	ection & management in accordance with ant Australian standards.	W1	Wall type 1:	Size: 200mm wide
xter	ant Australian standards. rnal Lighting and electrical : refer to neers details.		Insitu concrete planter wall Applciation: To raised planter areas	Type: Reinforced insitu off white concrete wall; Class 2 to comply with Finish: Smooth Accessories: Provide 20mm chamfer to top edges. Integrated LED ligh
-	ractor to protect all landscape works during		Apploidion. To raised planter aleas	Architects detail
nst	truction including but not exclusive to ing verge.	S1	Seating Wall Type 1: Precast Concrete seating	Size: N/A Type: off white concrete wall; Class 2 to comply with AS 3610
	ls general : contractor to ensure positive			Accessories: Adjustable LED strip lighting
Iraina nstal equii	age to all pavements, turf and planter areas, Il subsoil drainage to planter areas as ired.	SS	Application: To Amphitheatre Areas SS tensioned steel wires supporting vine growth linked to level below maintained via	Size: N/A Stainless Steel - JAKOB INLINE SYSTEM
			hook and anchor system Application: To Facade as shown	


					CLIENT	ARCHITECT	LANDSCAPE	DO NOT SCALE	Drawn RI	Designer CR/ RI	Client REYHODA PTY LTD
								Conditions of Use.	Drafting Check CR	Design Check CR	Project 58 ANDERSON STREET, CHATSWOOD
I DEVELOPMENT APPLICATION	RI	CR	CR	16.02.23	REYHODA PTY LTD	DREW DICKSON	LAND	This document may only be used by the client (and any other person who the	Approved (Project Director)		Title PLANT LIST AND MATERIALS
PRE DA	RI	CR		18.10.22		ARCHITECTURE	FORM	client has agreed can use this document for the purpose for which it was prepared		This Drawing must not b	Dot be Original Size
o Revision Note: * indicates signatures on original issue of drawing or last re-	vision of drawing Drawn	Job Manager	Project Director	Date			Studios	and must not be used by any other person or for any other purpose.	Scale 1:100	used for Construction u signed as Approved	$n \text{ unless}$ A1 Drawing No: $I D = D \Delta 001$

Plot Date: 16 February 2023 - 2:25 PM Plotted by: Charlie Robinson


Cad File No: C:\Users\CharlieRobinson\Landform Studios\Company Files - Documents\2022\2022037 - 58 Anderson Chatswood DA\CAD\2022015-LD-DA 001[2] (2).dwg

Ground	Plane & Public Domain						
CODE	SPECIES	COMMON NAME	POT SIZE	EST. MATURE HT	INSTALL SIZE	SPACING	NO.
TRI lau	Tristaniopsis laurina	Water Gum	Native	200L	3.5x1.5m	As Shown	As shown
OP con	Lophostemon confertus	Brush Box	Native	200L	3.5x1.5m	As Shown	As showr
Rooftop	s and Communal Open Space						
	TREES						
_AG ind	Lagerstroemia indica x L.fauriei 'Sioux'	Crepe Myrtle	200L	3-4m	2.2x1.0m	As Shown	As shown
							0
	CLIMBERS TO "GREEN" TRELLIS						
TRA jas	Trachelospermum jasminoides	Star Jasmine	150mm	150-200mm	100mm	3 per m2	As shown
	SHRUBS						
ANI hyb	Anigozanthos hybrid 'Everlasting Mega Gold'	Kangaroo Paw	300mm	1m	300mm	As Shown	As show
CAL vim	Callistemon viminalis 'Better John' LJ1'	Bottlebrush	200mm	0.6-1.2m	300mm	As Shown	As shown
HEL pet	Helichrysum petiolare 'Limelight'	Licorice Plant	300mm	0.5m	300mm	As Shown	As shown
RHA spi	Rhagodia spinescens 'Aussie Flat Bush'	Spiny salt bush	300mm	50cm	200mm	As Shown	As show
STR jun	Strelitzia juncae	Narrow Leaved Birds of Paradise	300mm	1-3m	500mm	As Shown	As show
WES fru	Westringia fruticosa 'Grey Box' WES04	Coastal Rosemary	200mm	0.5-1m	200mm	As Shown	As show
AGG att	Agave attenuata	Fox Tail Agave	300mm	1m	300mm	As Shown	As shown
BAN spi	Banksia spinulosa	Birthday Candles	45L	3m	500mm	As Shown	As shown
CYC rev	Cycas revoluta	Sago Palm	300mm	1m	300mm	As Shown	As showr
MUR pan	Murraya paniculata	Orange Jasmine	300mm	1m	300mm	As Shown	As showr
	ACCENTS + SUCCULENTS						
PHO ten	Phormium tenax 'Sweet Mist'	Sweet Mist	150mm	0.4m	100mm	As Shown	As shown
YUC ela	Yucca elaphantipes	Aloe Yucca	300mm	2m	300mm	As Shown	As shown
	0040050						
POA lab	GRASSES Poa labillardieri 'Eskdale'	Poa	150mm	60cm x 50cm	100mm	3 por m2	As shown
PEN naf	Poa labiliardieri Eskoale Pennisetum alopecuroides 'Nafray'	Foxtail Grass	150mm	60cm x 50cm	100mm	3 per m2 3 per m2	As shown
LOM Ion	Lomandra longfolia LM400	Matt Rush	150mm	60cm x 60cm	200mm	3 per m2	As shown
	CLIMBERS + GROUNDCOVERS						
CAR gla	Carpobrotus glaucescens 'CAR10'	Aussie Rambler	150mm	200mm	100mm	3 per l/m	As show
CAS gla	Casuarina glauca 'Cousin It'	Cousin It	150mm	150mm	100mm	3 per l/m	As shown
GAZ tom	Gazania hyvrid 'Double Gold' GT20	Gazania	150mm	150mm	100mm	3 per m2	As show
MYO par	Myoporum parvifolium 'Yareena'	Creeping boobialla	150mm	1m spread x 0.1mH	100mm	3 per l/m	As show
SEN ser	Senecio serpens	Blue Chalk Stick	150mm	300mm	100mm	3 per l/m	As show

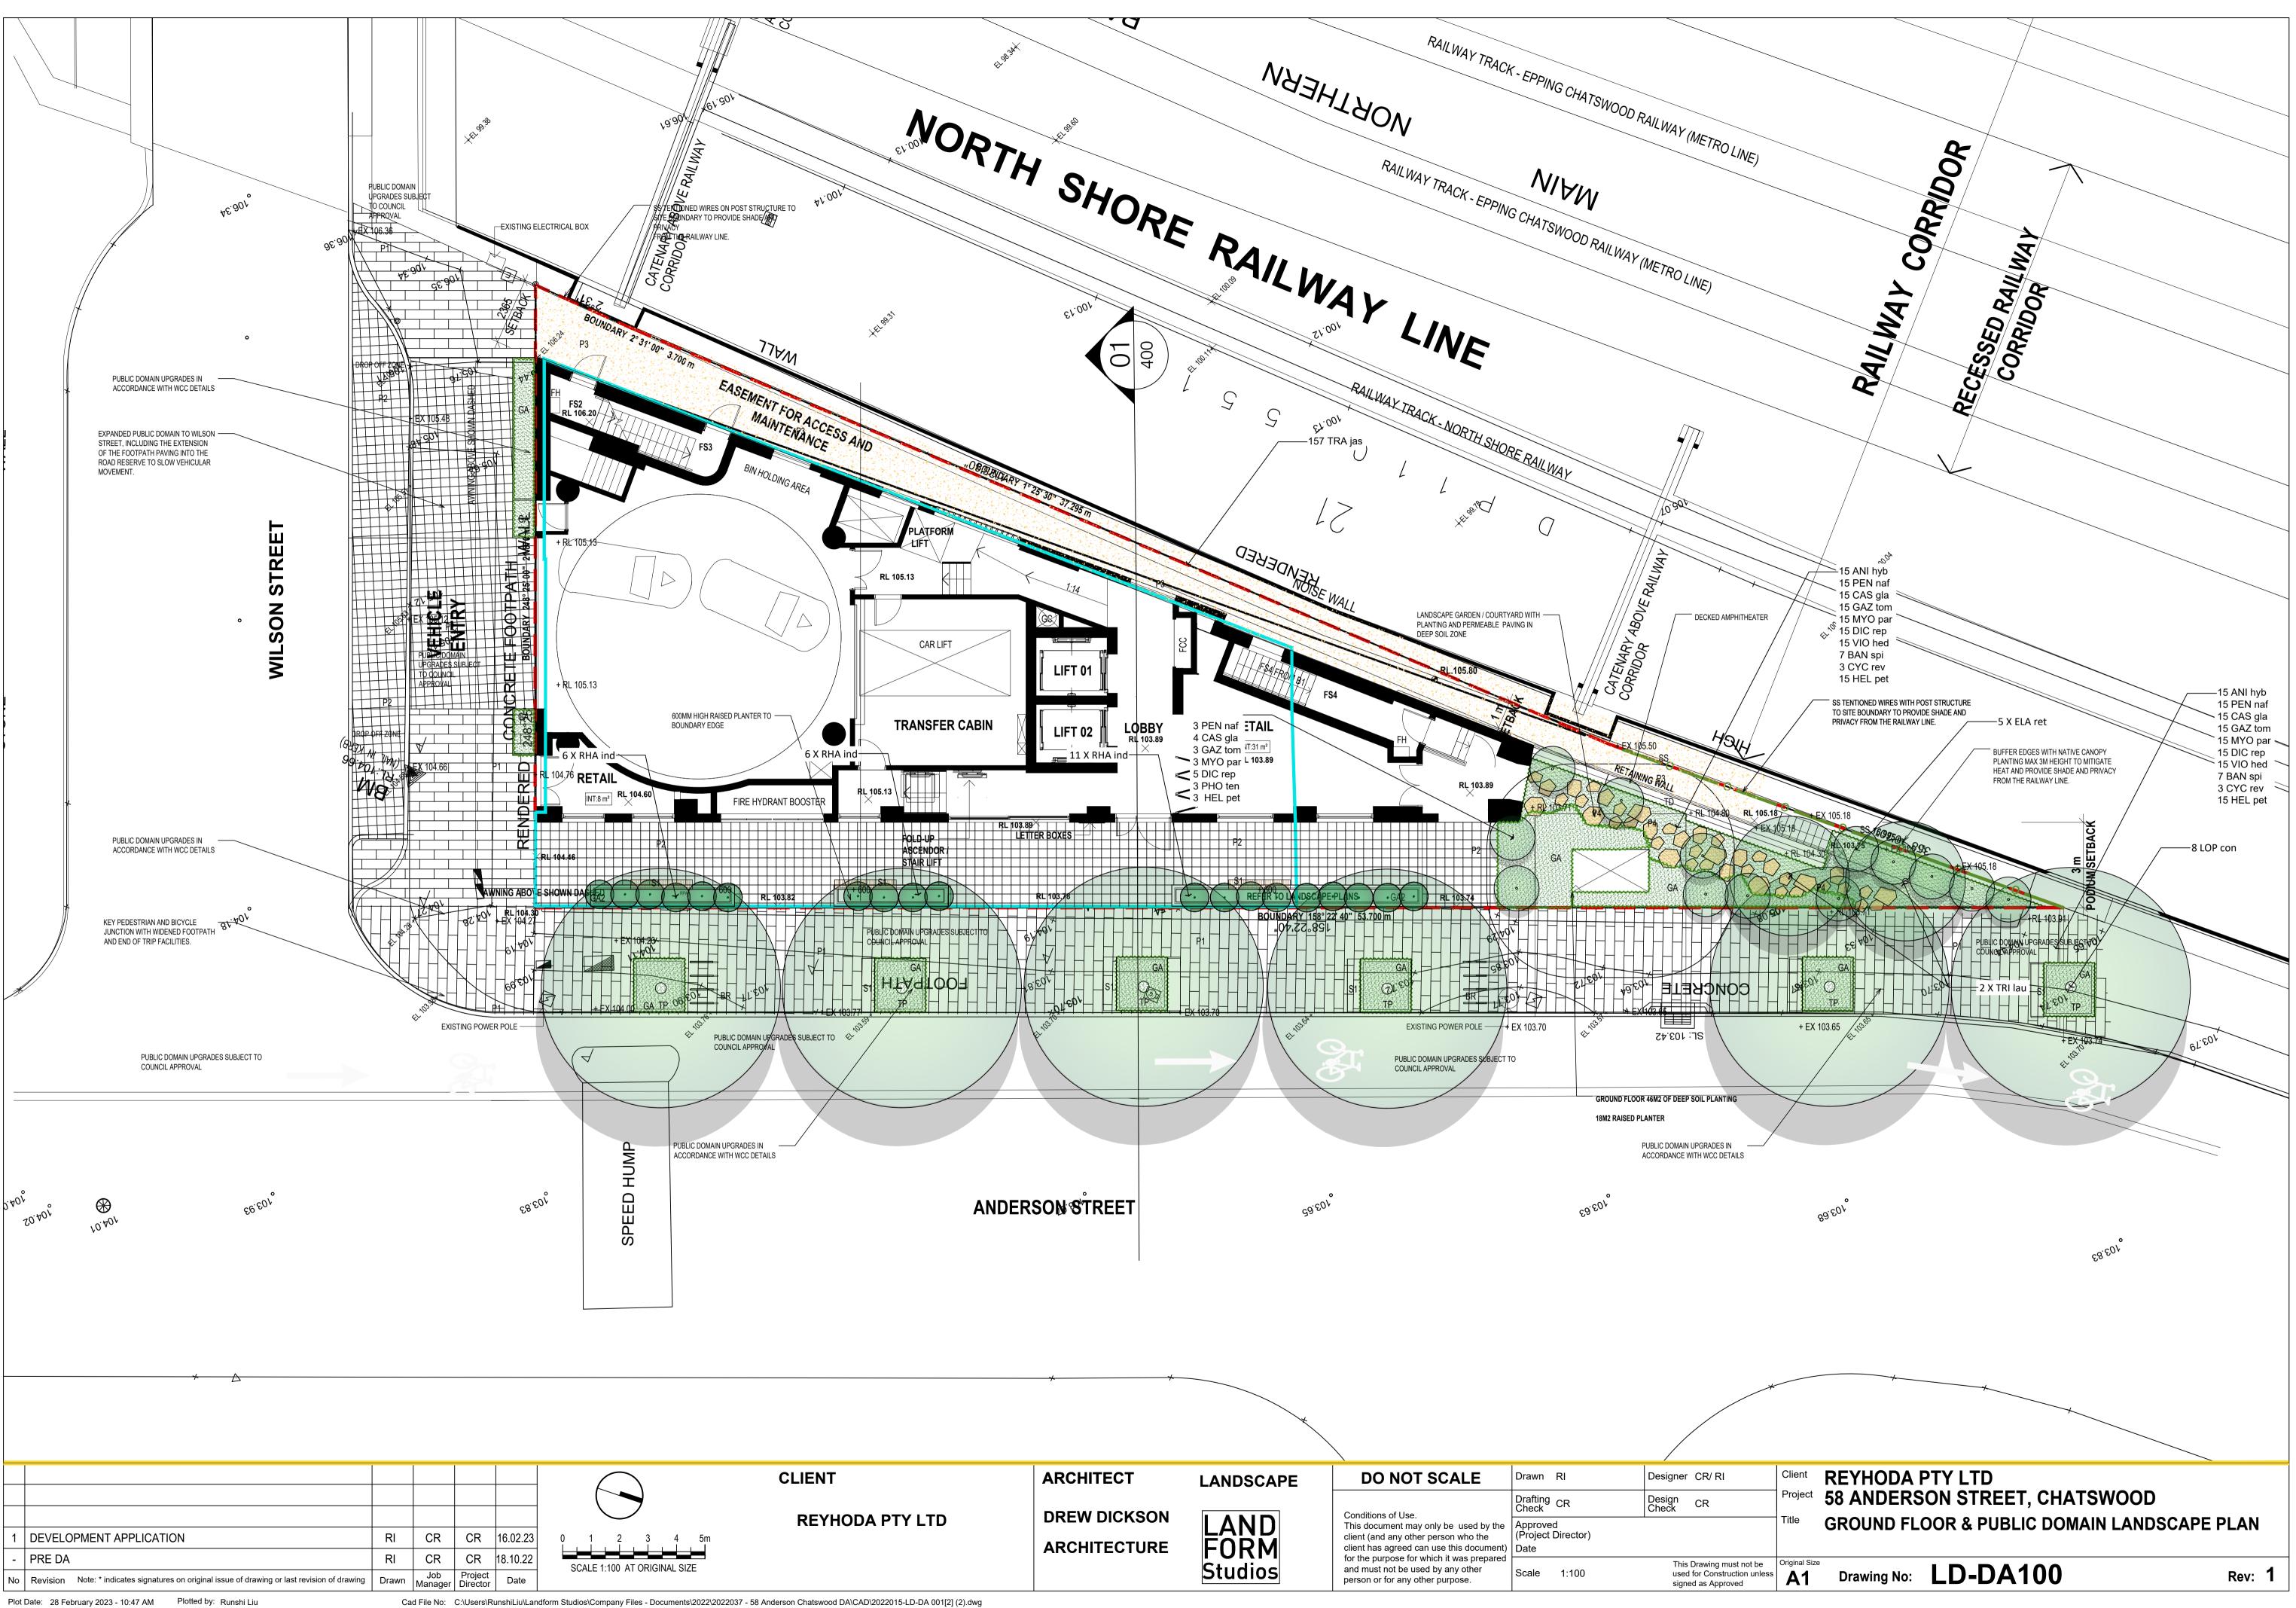

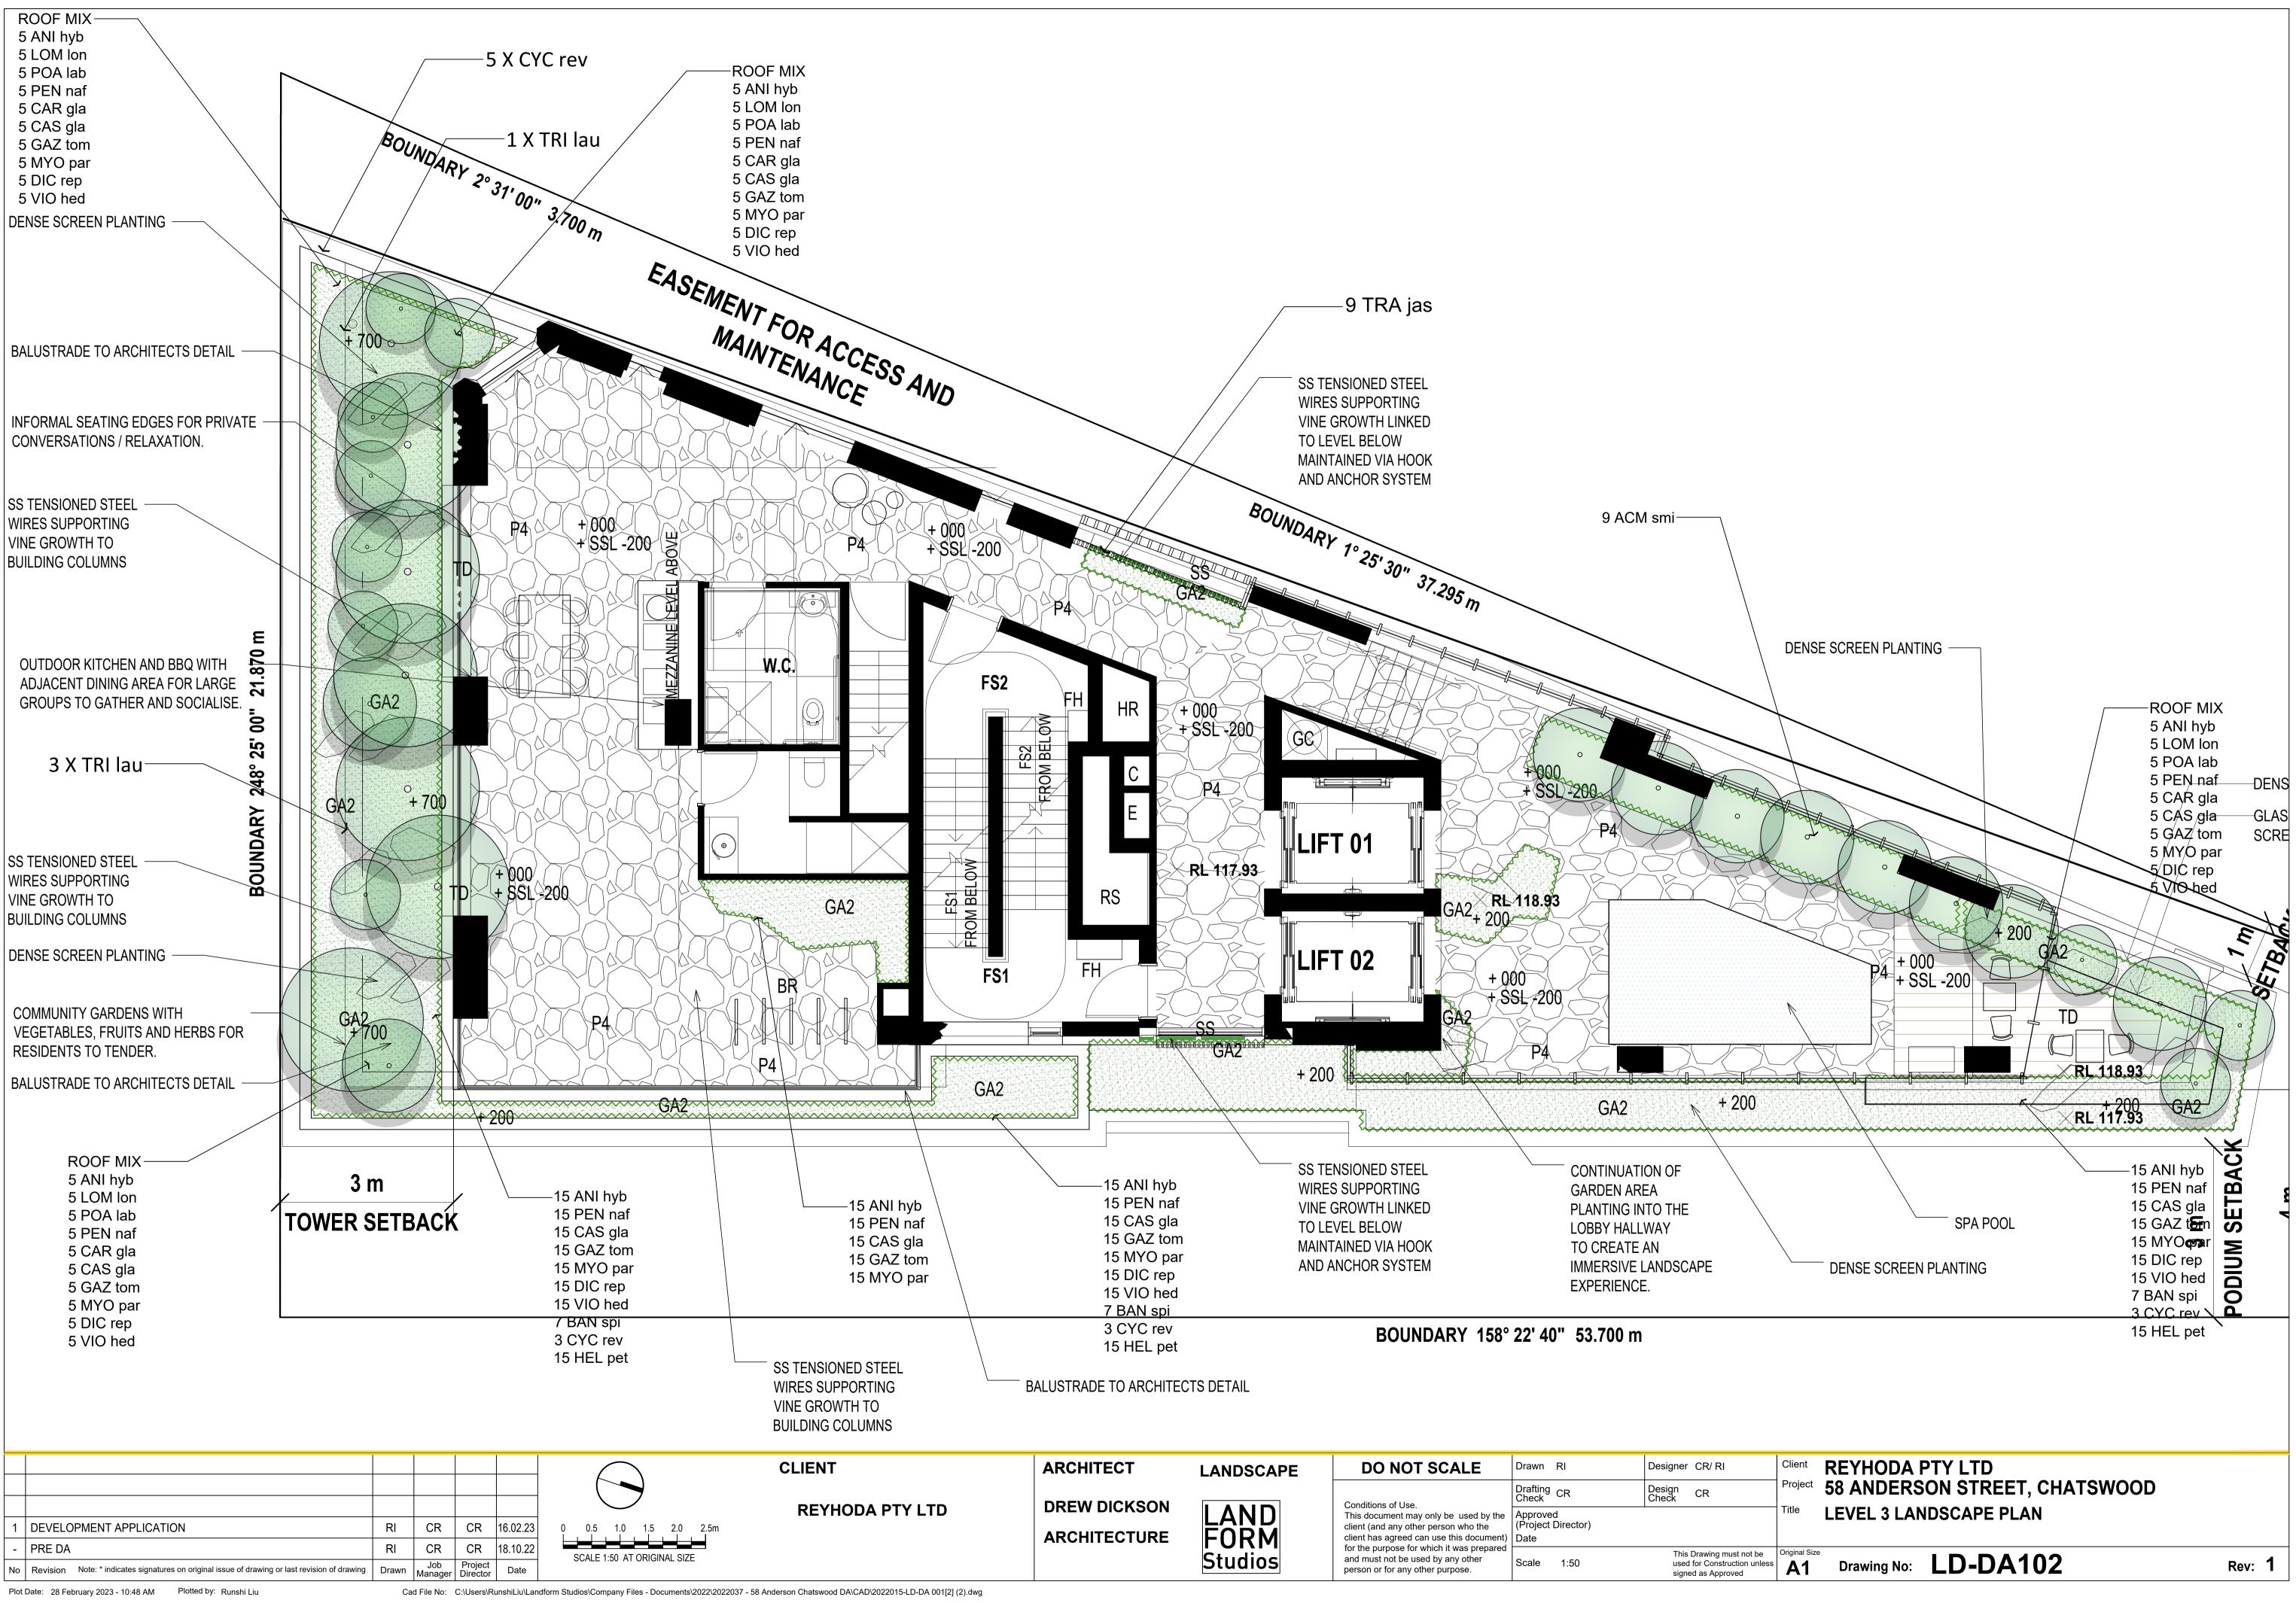

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DA PTY LTD	DREW DICKSON	LAND FORM	Conditions of Use. This document may only be used by the client (and any other person who the client has agreed can use this document)	Drafting Check CR	Design Check CR
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		Studios	for the purpose for which it was prepared and must not be used by any other person or for any other purpose.	Scale 1:50	This Drawing must not I used for Construction u signed as Approved
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Plot Date: 28 February 2023 - 10:48 AM Plotted by: Runshi Liu
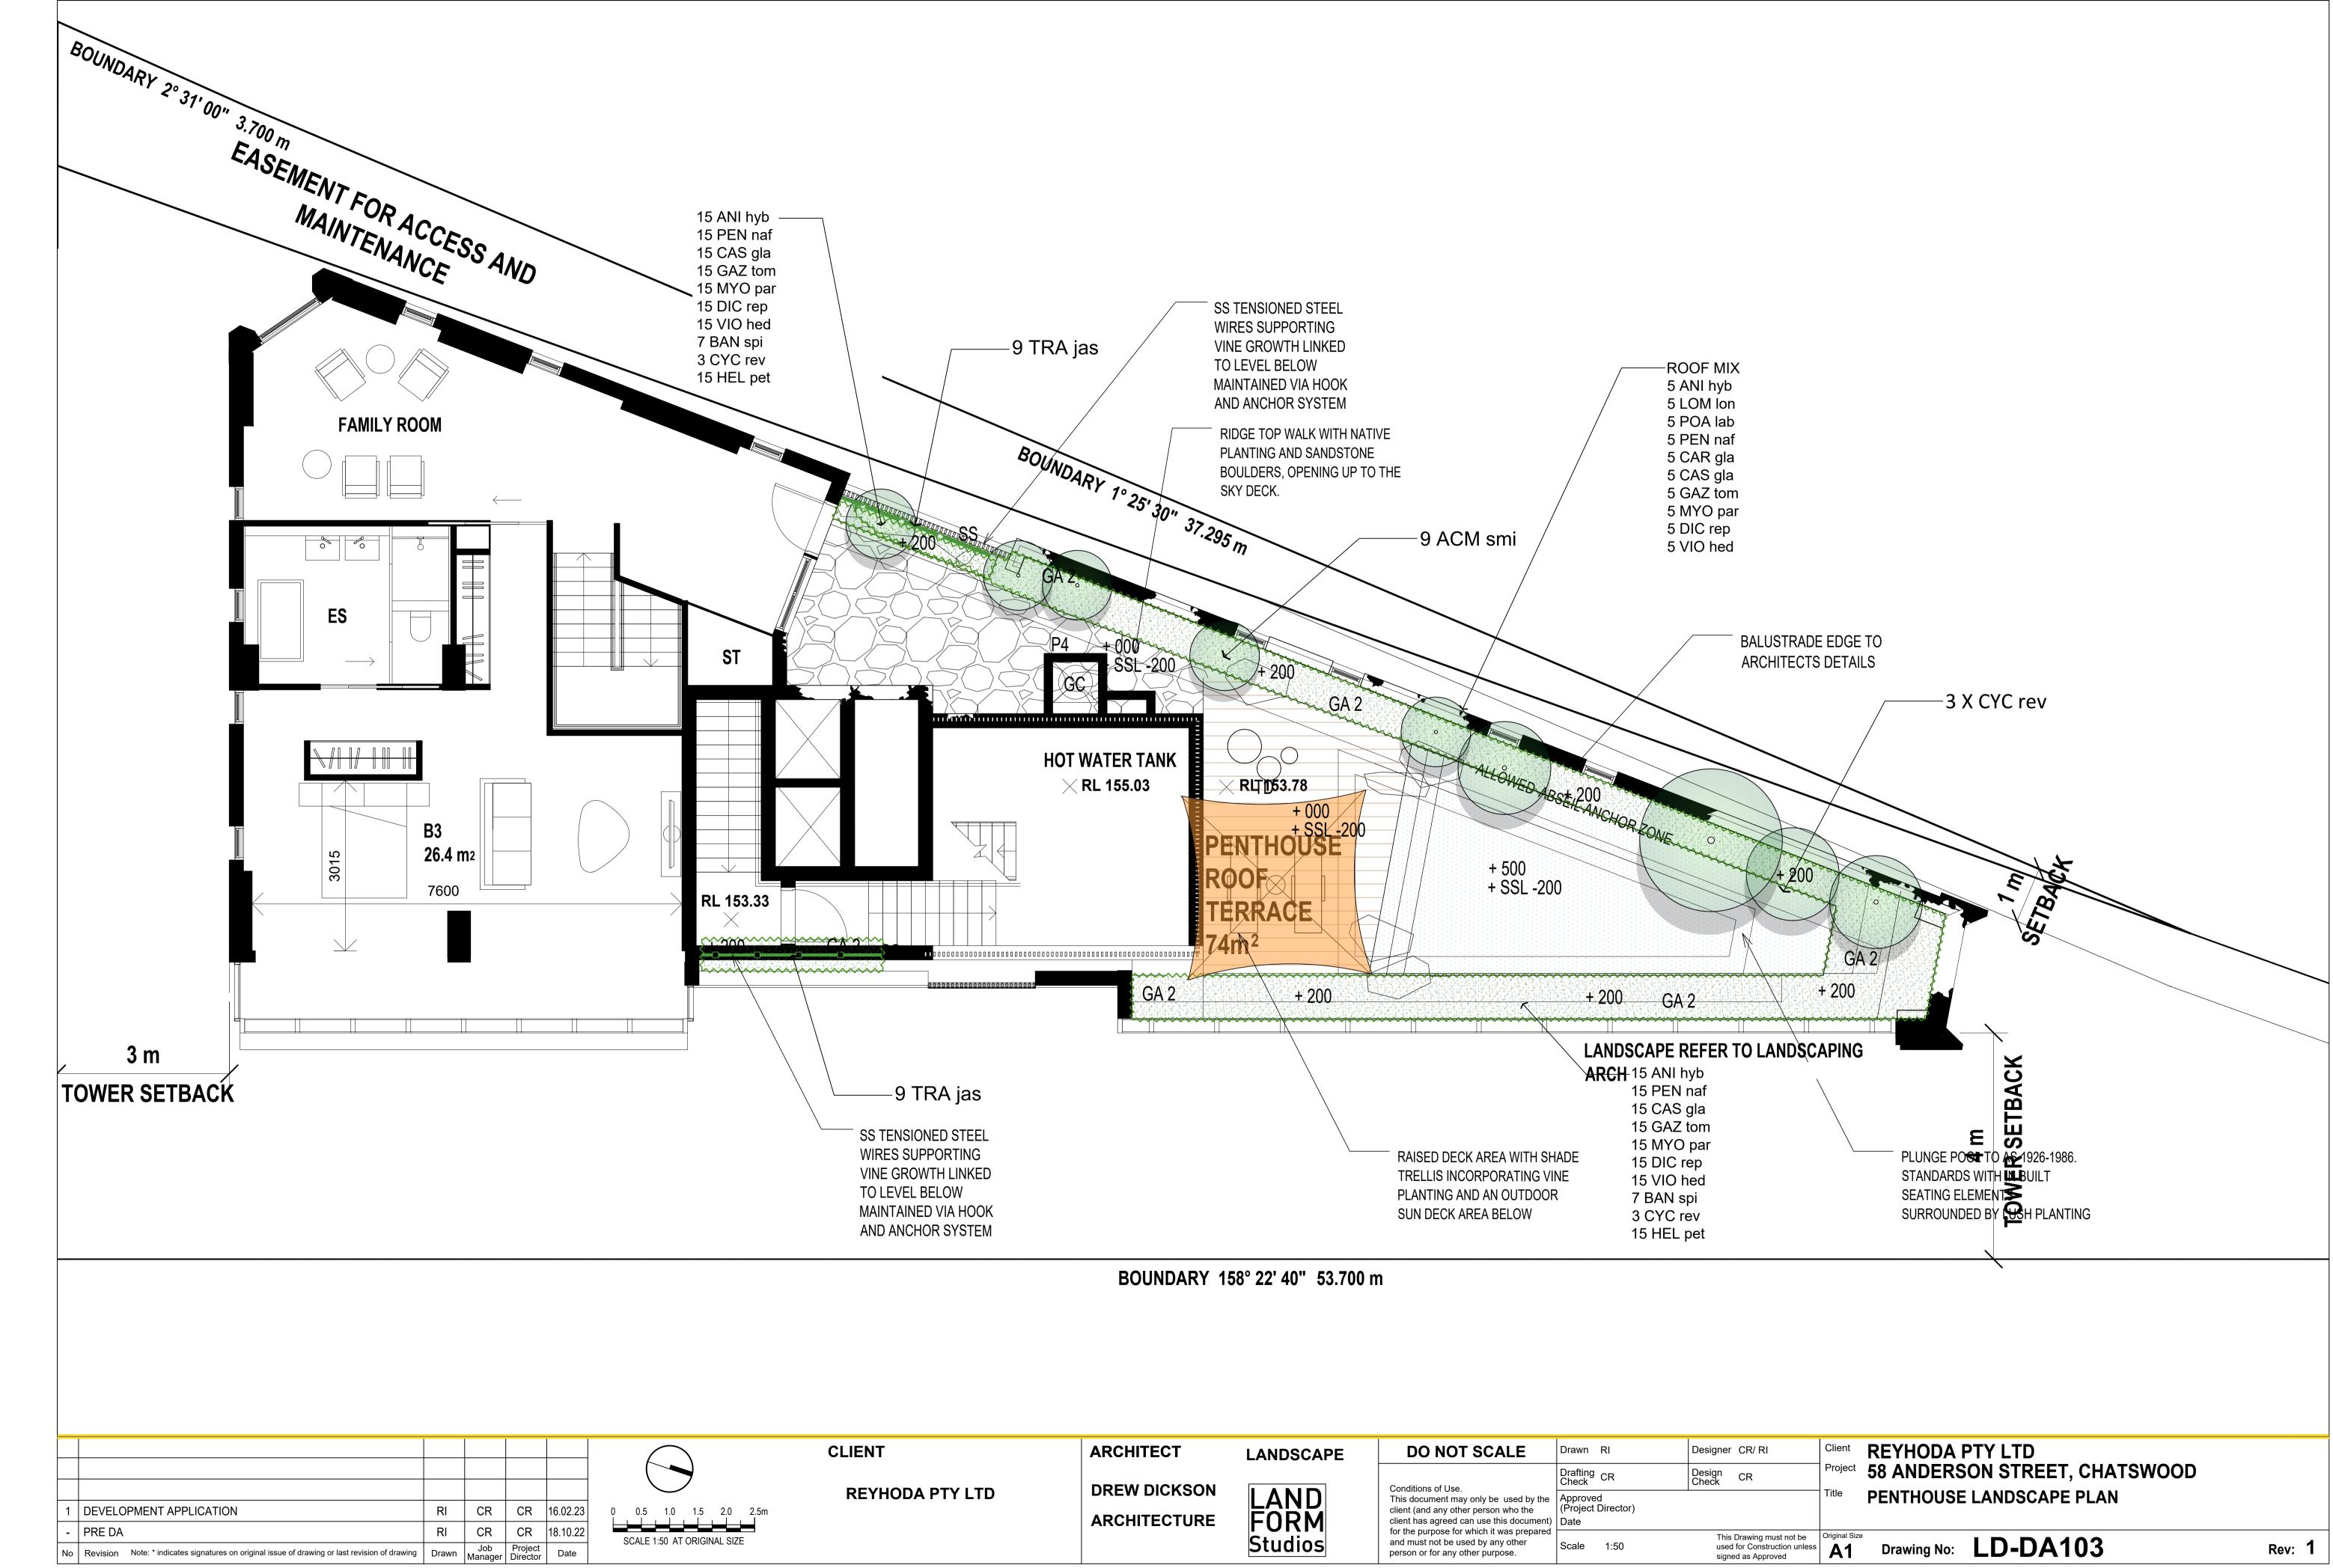
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				Approved (Project Director) Date	
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### **PUBLIC DOMAIN AND GROUND FLOOR** LANDSCAPE EXPERIENCE AND CHARACTER




**LEVEL 3 AND PENTHOUSE** 


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No	Revision Note: * indicates signatures on original issue of drawing or last revision of drawing	Drawn	Job Manager	Project Director	Date	SCALE 1.50 AT ORIGINAL SIZE	

Plot Date: 17 February 2023 - 1:48 PM Plotted by: Charlie Robinson

# Image: Image:

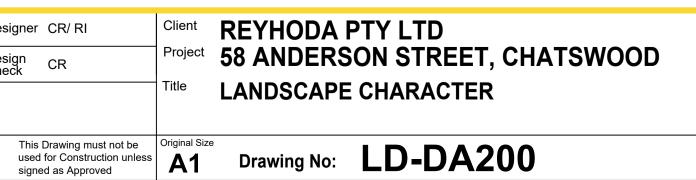

Rev: 1

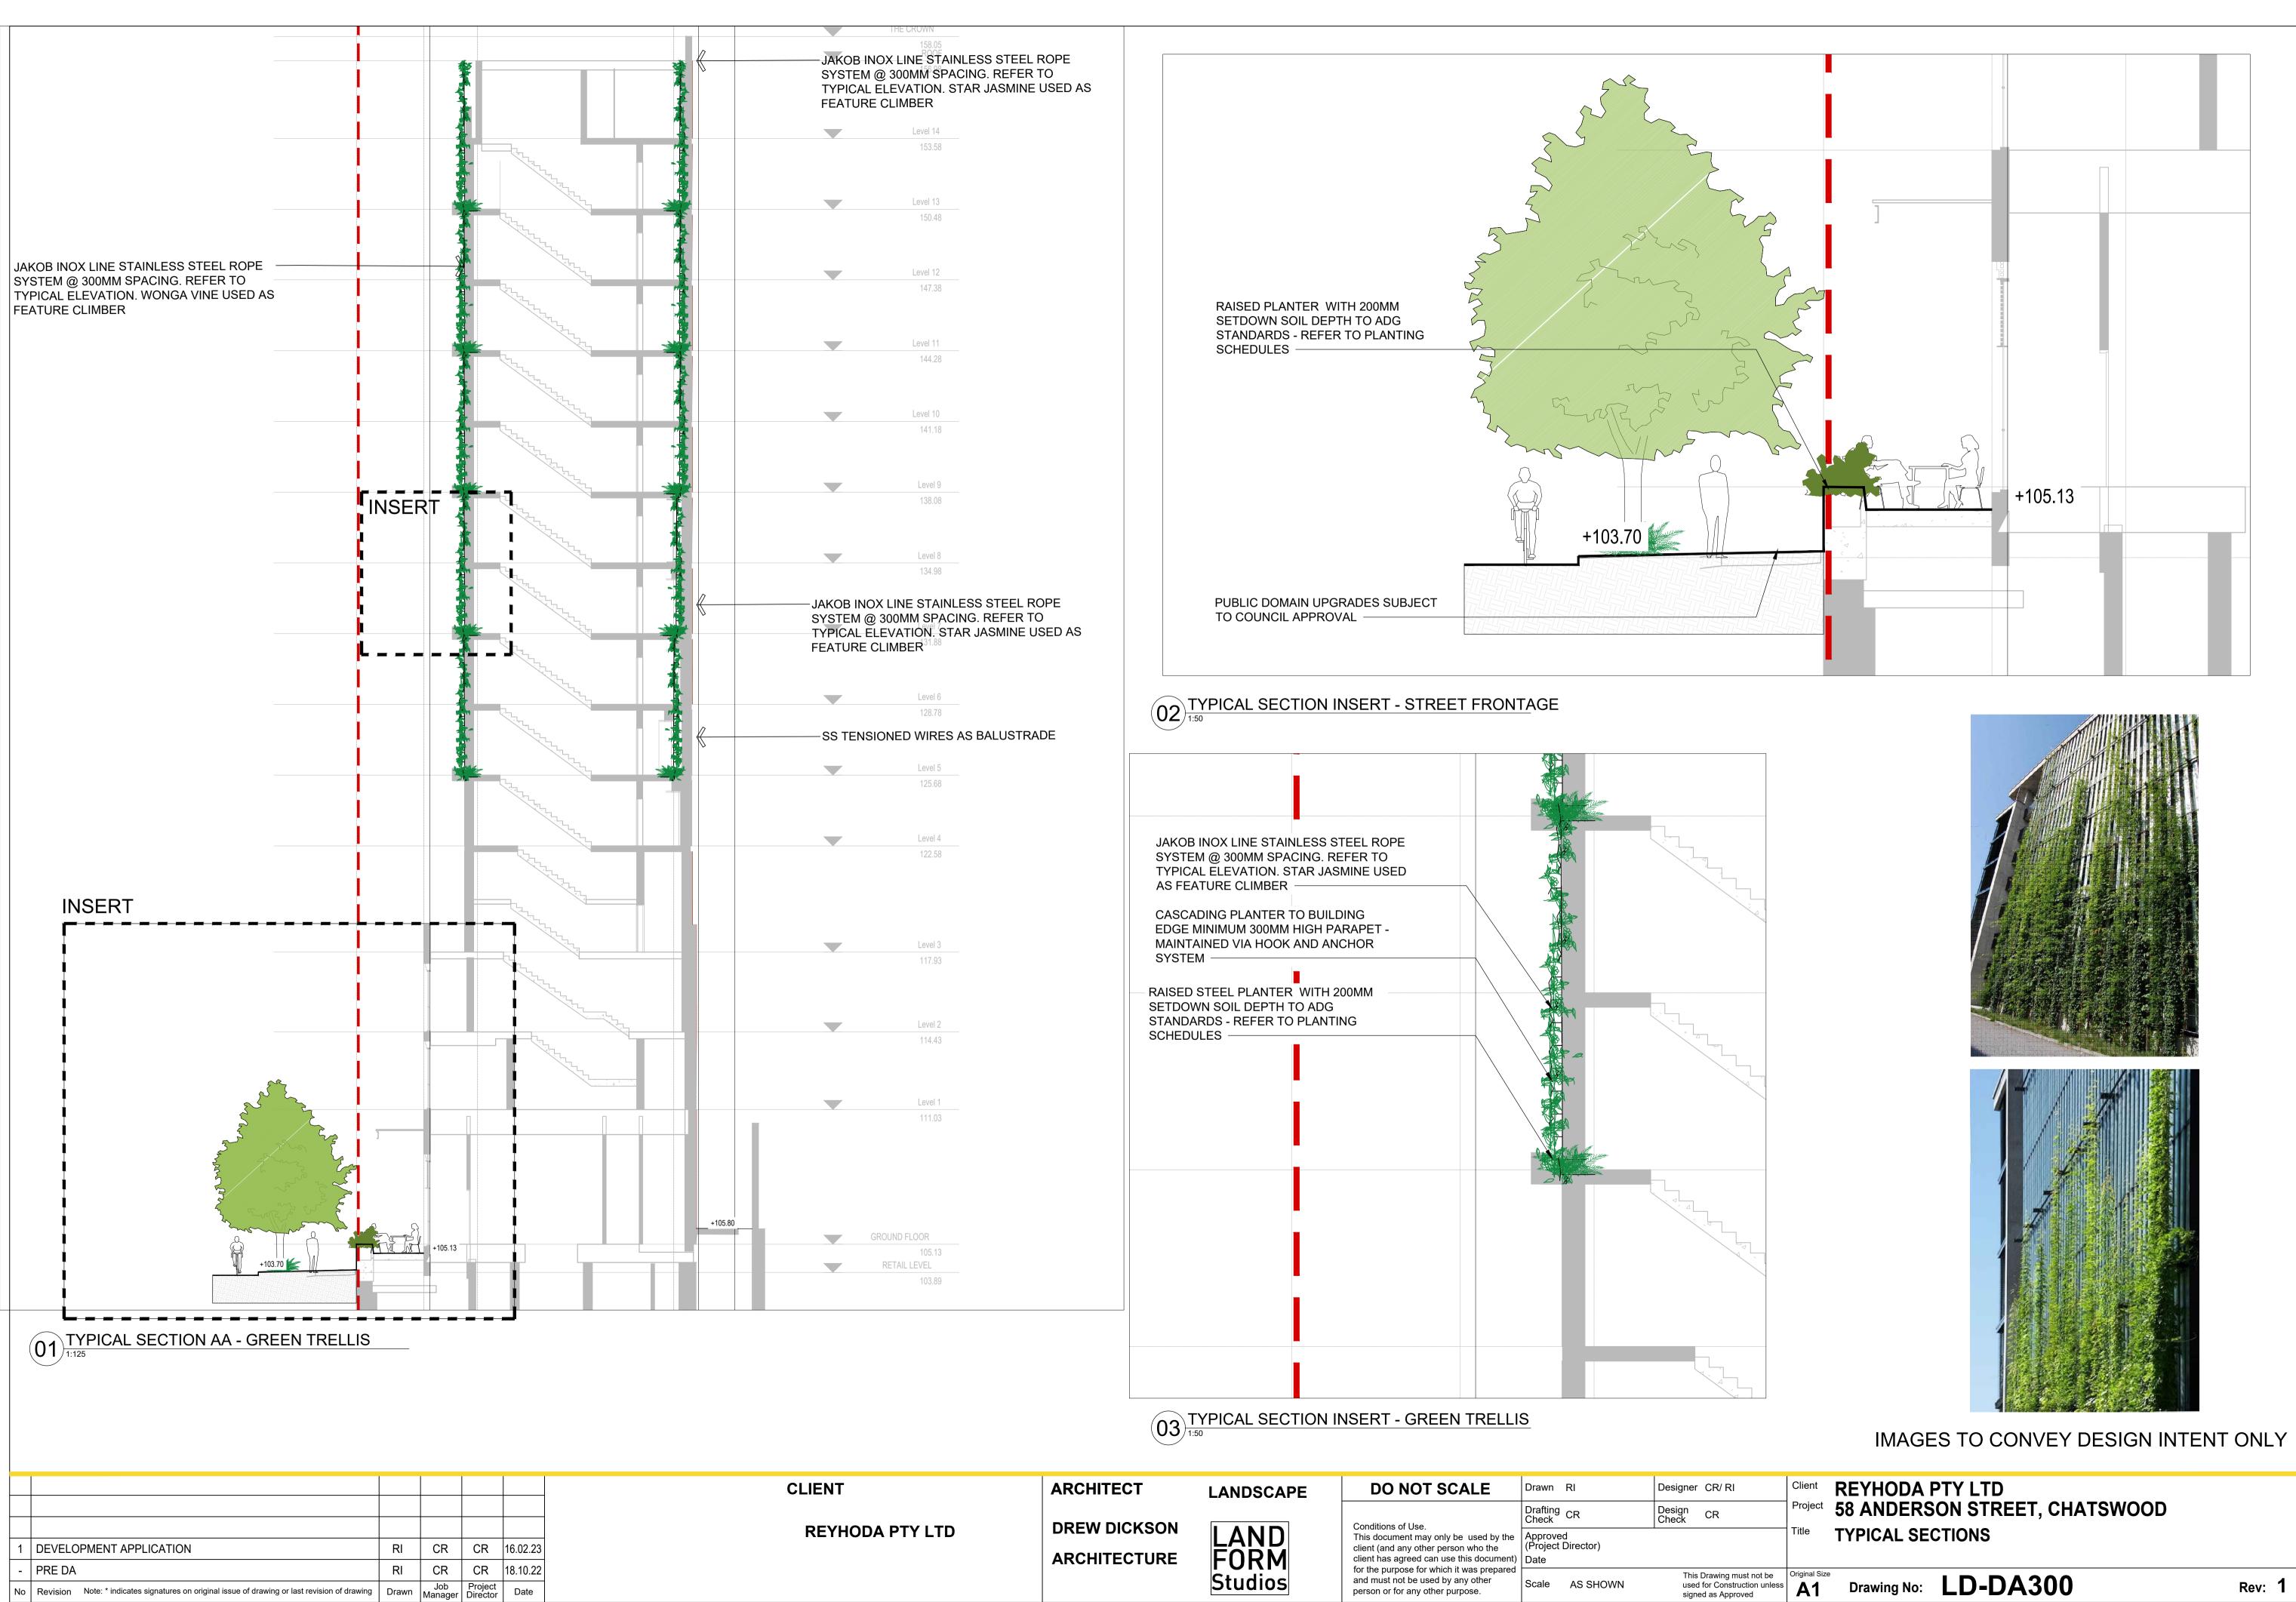

Plot Date: 17 February 2023 - 1:54 PM Plotted by: Charlie Robinson

# [되] $|M|/\Delta |N|$ 58 ANDERSON STREET, CHATSWOOD NSW 2067

LEGEND	
DP •	DOWNPIPE
	STORMWATER LINE
	STORMWATER LINE DRAINING TO RWT
OF	OVER FLOW PIPE
SSD	SUBSOIL LINE
SWRM	STORMWATER RISING MAIN
e	EXISTING STORMWATER LINE
SW SW	AUTHORITY STORMWATER LINE
HL HL	HIGH LEVEL STORMWATER LINE
s	AUTHORITY SEWER LINE
W	AUTHORITY WATER LINE
G G	AUTHORITY GAS LINE
E	AUTHORITY ELECTRICITY LINE
— FO— FO— FO—	AUTHORITY FIBRE OPTIC LINE
TEL	AUTHORITY COMMS LINE
///	FENCE LINE
	GRATED SURFACE INLET PIT
	GRATED SURFACE INLET PIT WITH ENVIROPOD INSERT
	JUNCTION PIT
	KERB INLET PIT
	EXISTING GRATED SURFACE INLET PIT
	GRATED TRENCH DRAIN
	EXISTING JUNCTION PIT
	EXISTING KERB INLET PIT
etel	EXISTING TELSTRA PIT
🗎 eHYD	EXISTING HYDRANT
⊠ eSV	EXISTING STOP VALVE
🛛 eGAS	EXISTING GAS VALVE
⊖ ePP	EXISTING POWER POLE
🂢 eBT	EXISTING BOUNDARY TRAP

LEGEND	
FF Ø	FIRST FLUSH
eSMH	EXISTING SEWER MANHOLE
	OVERLAND FLOW PATH
R₩O Ø	RAINWATER OUTLET
PS 。	PIPE STAND
CO Ø	CLEAR OUT POINT
DDO Ø	DISH DRAIN OUTLET
PD Ø	PLANTER DRAIN
С	CAPPING
(1.01)	PIT TAG/NUMBER
RH 🖸	RAINHEAD
۲	DOWNPIPE DROP
X	NON RETURN VALVE
→	WALL PENETRATION
	DOWNPIPE SPREADER
	WARNING LIGHT
0.00 🕈	SPOT LEVELS
	BENCHMARK



BEFORE YOU DIG SHOULD BE CONTACTED PRIOR TO ANY EXCAVATION ON SITE TM: TRADE MARK OF THE ASSOCIATION OF DIAL BEFORE YOU DIG SERVICES LTD. USED UNDER LICENSE.

SERVICES SHOWN ON PLAN ARE INDICATIVE, EXACT DEPTH AND LOCATION TO BE CONFIRMED ONSITE. CONTRACTOR TO CARRY OUT DIAL BEFORE YOU DIG APPLICATION AND ENGAGE A REGISTERED SURVEYOR TO PEG OUT ALL EXISTING SERVICES PRIOR TO ANY WORK COMMENCING ONSITE.

# PROPOSED MIXED USE DEVELOPMENT 58 ANDERSON STREET, CHATSWOOD NSW 2067

Drawn S.C.



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С	ISSUED FOR COORDINATION
В	ISSUED FOR COORDINATION
Rev	Description

NUMBER	NAME	REVISION
SW001	COVER SHEET	н
SW010	BASEMENT 3 FLOOR PLAN, NOTES & DETAILS	н
SW011	BASEMENT 2 FLOOR PLAN, NOTES & DETAILS	н
SW012	BASEMENT 1 FLOOR PLAN, NOTES & DETAILS	н
SW020	GROUND FLOOR PLAN, NOTES & DETAIL	н
SW021	ON-SITE DETENTION SECTIONS & DETAILS	н
SW022	STORMFILTER SYSTEM SECTIONS & DETAILS	н
SW030	LEVEL 3 PLAN, NOTES & DETAILS	н
ER001	EROSION AND SEDIMENT CONTROL PLAN	н

<u>DRAINAGE NOTES:</u>
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ALL PIPES TO BE LAID ON 75mm SAND BED WITH THE BARRELS FULLY SUPPORTED
100mm AND 150mm DIAMETER PIPES TO BE LAID ON MINIMUM 1% GRADE
MINIMUM DEPTH OF COVER FOR PIPES NOT SUBJECT TO VEHICULAR LOADING TO BE 300mm
ALL DRAINAGE PIPES LAID UNDER PAVEMENT SHALL BE REINFORCED CONCRETE WITH RUBBER RING JOINTS
BACKFILL TRENCHES WITH COMPACTED SAND OR APPROVED AGGREGATE MATERIAL
ALL PITS TO HAVE 600x600mm INTERNAL DIMENSIONS (U.N.O.)
SILT ARRESTORS TO HAVE 900x900mm INTERNAL DIMENSIONS
HEAVY DUTY GRATES AND COVERS ARE TO BE PROVIDED IN TRAFFICABLE AREAS
PIT GRATE TO BE TYPE WELDLOK OR APPROVED EQUIVALENT
ALL PITS SHALL BE PROVIDED WITH A LOCKING CLIP
ALL PITS SHALL BE MAINTAINED REGULARLY
TOP OF BENCHING SHALL BE TO THE HALF OF THE OUTLET PIPE DIAMETER
MAXIMUM FRONT ENTRY PIPE:— STRAIGHT ENTRY— Ø750 SKEW ENTRY 45°— Ø525
Ø100 SUBSOIL DRAINAGE PIPE 3000mm LONG WRAPPED IN FABRIC SOCK TO BE PROVIDED ADJACENT TO INLET PIPES
COMPRESSIVE STRENGTH I'& FOR CAST IN SITU CONCRETE TO BE A MINIMUM OF 20MPa AT 28 DAYS
PROVIDE CLEANING EYES TO ALL DOWNPIPES NOT DIRECTLY CONNECTED TO PITS
ISOLATED JOINTS TO BE PROVIDED TO ISOLATE CONCRETE PAVEMENTS FROM PITS
ALL TRENCH GRATES PROVIDED SHALL HAVE A MINIMUM CLEAR WIDTH OF 200mm
STORMWATER DRAINAGE CONNECTIONS TO THE MAIN SYSTEM SHALL BE TO THE REQUIREMENTS AND THE SATISFACTION OF LOCAL COUNCIL

### ABBREVIATIONS:

Ø or DIA CBR CL CO DDO DEJBBS DP FGTSIPD JK IP PO KKR SGL PO SC FTD SSV FTD SSV FTD FTD SSV SSV FTD SSV FTD SSV FTD SSV SSV FTD FTD SSV SSV FTD FTD SSV FTD SSV FTD SSV FTD SSV FTD FTD SSV FTD SSV FTD FTD SSV FTD FTD SSV FTD SSV FTD FTD SSV FTD FTD SSV FTD FTD SSV FTD FTD SSV FTD FTD SSV FTD FTD SSV FTD FTD SSV FTD FTD SSV FTD SSV FTD FTD SSV FTD FTD SSV FTD FTD FTD SSV FTD FTD SSV SSV FTD FTD FTD FTD FTD FTD FTD FTD FTD FTD	DIAMETER CALIFORNIA BEARING RATIO CHAINAGE CENTER LINE CLEAR OUT DISH DRAIN DISH DRAIN OUTLET DOWELLED EXPANSION JOINT DENSE GRADED BASECOURSE DENSE GRADED SUB-BASE DOWNPIPE EXISTING FINISHED FLOOR LEVEL GRATED TRENCH DRAIN GRATED SURFACE INLET PIT HYDRANT ISOLATING JOINT INTEGRAL KERB INVERT LEVEL INTERSECTION POINT KERB INLET PIT KERB ONLY KERB & GUTTER KERB RETURN LONGITUDINAL SECTION NATURAL GROUND LEVEL OVERLAND FLOW PATH ON-SITE DETENTION RADIUS REINFORCED CONCRETE PIPE ROLL KERB & GUTTER REDUCED LEVEL RETAINING WALL RAINWATER TANK SAWN CONTROL JOINT SEWER MAN HOLE STORMWATER PIT STORMWATER RISING MAIN STORMWATER SUMP STOP VALVE TOP OF KERB TOP OF WALL TOP WATER LEVEL TANGENT POINT UNPLASTICISED POLYVINYL CHLORIDE
UNO	UNLESS NOTED OTHERWISE
WPJ	WEAKENED PLANE JOINT
FF	FIRST FLUSH DEVICE
TYP	TYPICAL
BM	BENCH MARK

# FOR COUNCIL APPROVAL ONLY (CONCEPT)

FOR COUNCIL / CONSTRUCTION CERTIFICATE ISSUE

**APPROVED BY:** 





S.C. M.W. 29/10/2024 Architect S.C. M.W. 10/05/2024 S.C. M.W. 08/03/2024 S.H. M.W. 21/03/2023 S.H. M.W. 20/02/2023 INFO@DDA-AUSTRALIA.COM 02 9061 3433 Z.S. M.W. 20/12/2022 Z.W. M.W. 09/12/2022 DDA-AUSTRALIA.COM

By Chk Date

DREW DICKSON ARCHITECTS SUITE 2, GROUND FLOOR/ 183 ALEXANDER STREE CROWS NEST NSW 2065

P.EtBy PAUL EL-BAYEH B.E. (Civil) M.E. (Structural & Foundation EAust, CPEng No. 3132148, NER, RPEQ.

29/10/2024

DATE:

NER

STORMWATER PIPE BEDDING/PAVING NOTES: WHERE TRENCH BASE IS ROCK A MINIMUM OF 75mm BEDDING TO BE PROVIDED UNDER PIPE COLLARS. STORMWATER PIPE BEDDING DETAIL TO BE IN ACCORDANCE WITH LOCAL COUNCIL REQUIREMENTS. BEDDING DETAILS TO BE CONFIRMED UPON EXCAVATION & PRIOR TO INSTALLATION OF PIPEWORK. FOOTPATH REINSTATEMENT NOTES: REMOVE ALL SAND FILL WITHIN THE FOOTPATH AREA TO THE EXISTING SUBGRADE. SUPPORT ALL AUTHORITY SERVICES TO STRUCTURAL ENGINEERS DETAILS DURING EXCAVATION. REINSTATE FOOTPATH SUBGRADE. THE CONTRACTOR SHALL PROVIDE CERTIFICATION OF COMPACTION FROM A NATA REGISTERED TESTING AUTHORITY. MINIMUM THREE TESTS PER LAYER AS FOLLOWS: SELECT FILL 95% MODIFIED SELECT FILL (LESS THAN 300mm 98% MODIFIED BELOW BASE COURSE) BASE COURSE 100% MODIFIED EROSION & SEDIMENT CONTROL NOTES: PROVIDE SILT FENCE/HAY BAIL BARRIERS TO THE LOW SIDE OF ALL EXPOSED EARTH EXCAVATIONS (TYPICAL). ISOLATE EXISTING STORMWATER PITS WITH HAY BALES TO FILTER ALL INCOMING FLOWS. DO NOT STOCK PILE EXCAVATED MATERIAL ON THE ROAD WAY.

### SURVEY

THE EXISTING SITE CONDITIONS SHOWN ON THE FOLLOWING DRAWINGS HAVE BEEN INVESTIGATED BY REGISTERED SURVEYORS. THE INFORMATION IS SHOWN TO PROVIDE A BASIS FOR DESIGN. CAPITAL ENGINEERING CONSULTANTS DOES NOT GUARANTEE THE ACCURACY OR COMPLETENESS OF THE SURVEY BASE OR ITS SUITABILITY AS A BASIS FOR CONSTRUCTION DRAW.

SHOULD DISCREPANCIES BE ENCOUNTERED DURING CONSTRUCTION BETWEEN THE SURVEY DATA AND ACTUAL FIELD DATA, CONTACT CAPITAL ENGINEERING CONSULTANTS.

SERVICES SHOWN ON PLAN ARE INDICATIVE, EXACT DEPTH AND LOCATION TO BE CONFIRMED ONSITE. CONTRACTOR TO CARRY OUT DIAL BEFORE YOU DIG APPLICATION AND ENGAGE A REGISTERED SURVEYOR TO PEG OUT ALL EXISTING SERVICES PRIOR TO ANY WORK COMMENCING ONSITE.

IT IS THE BUILDERS RESPONSIBILITY TO MAKE SURE ALL SURVEY MARKS TO BE PRESERVED AT ALL COST.



STORMWATER LAYOUT PLAN COVER SHEET





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SW001

Drawing Number



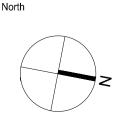

### STANDARD PUMP OUT DESIGN NOTES:

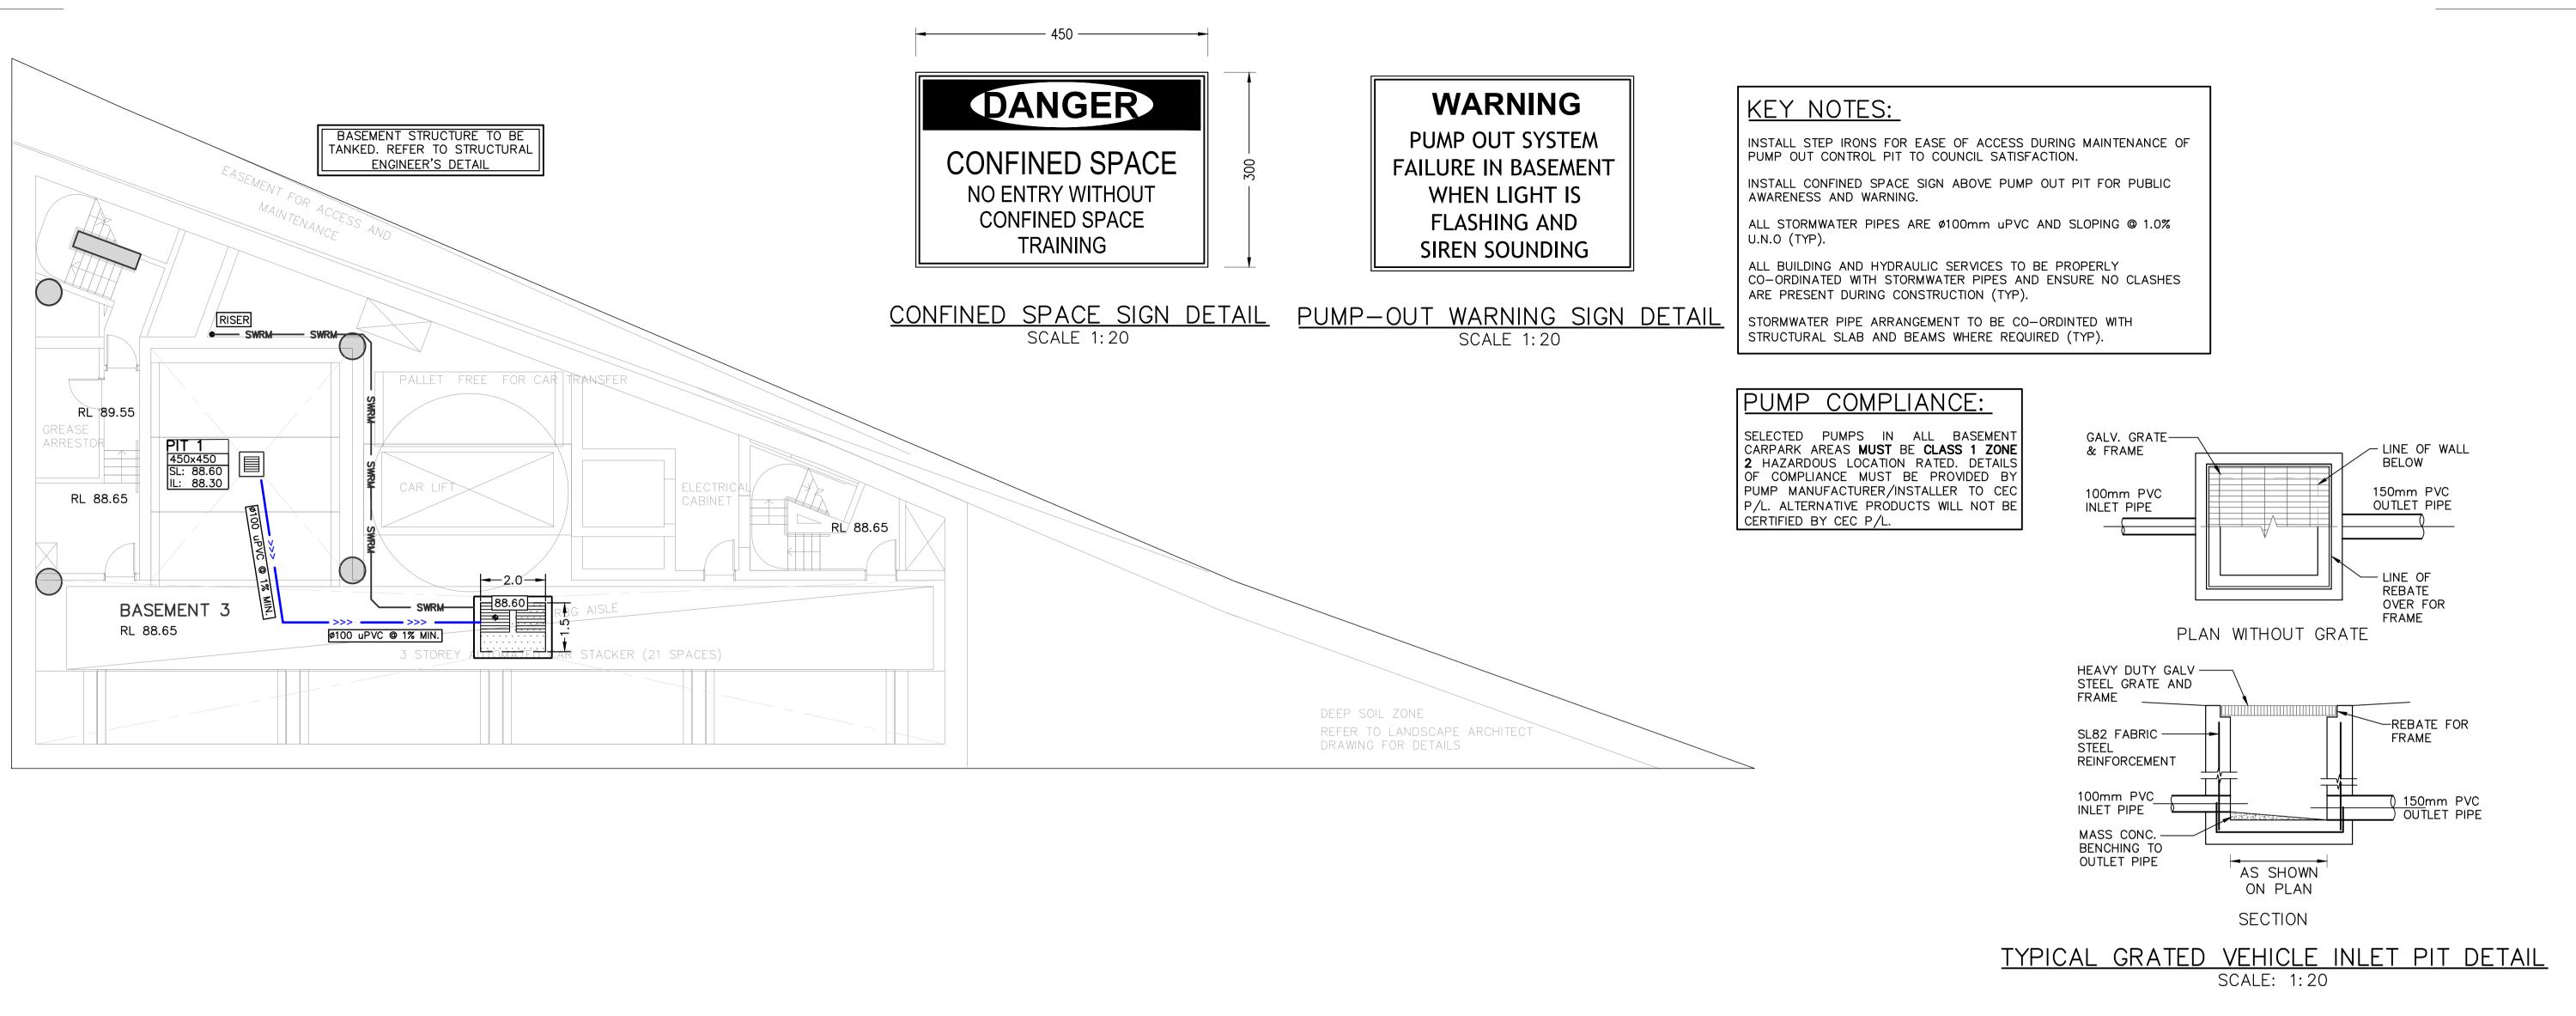THE PUMP OUT SYSTEM SHALL BE DESIGNED TO BE OPERATED IN THE FOLLOWING MANNER: -


). THE PUMPS SHALL BE PROGRAMMED TO WORK ALTERNATELY TO ÁLLOW BOTH PUMPS TO HAVE AN EQUAL OPERATION LOAD AND PUMP I IFF

II). A FLOAT SHALL BE PROVIDED TO ENSURE THAT THE MINIMUM REQUIRED WATER LEVEL IS MAINTAINED WITHIN THE SUMP AREA OF THE BELOW GROUND TANK. IN THIS REGARD THIS FLOAT WILL FUNCTION AS AN OFF SWITCH FOR THE PUMPS AT THE MINIMUM WATER LEVEL. THE SAME FLOAT SHALL BE SET TO TURN ONE OF THE PUMPS ON UPON THE WATER LEVEL IN THE TANK RISING TO APPROXIMATELY 300MM ABOVE THE MINIMUM WATER LEVEL. THE PUMP SHALL OPERATE UNTIL THE TANK IS DRAINED TO THE MINIMUM WATER LEVEL.

III). A SECOND FLOAT SHALL BE PROVIDED AT A HIGH LEVEL, WHICH IS APPROXIMATELY THE ROOF LEVEL OF THE BELOW GROUND TANK. THIS FLOAT SHALL START THE OTHER PUMP THAT IS NOT OPERATING AND ACTIVATE THE ALARM.

IV). AN ALARM SYSTEM SHALL BE PROVIDED WITH A FLASHING STROBELIGHT AND A PUMP FAILURE WARNING SIGN WHICH ARE TO BE LOCATED AT THE DRIVEWAY ENTRANCE TO THE BASEMENT LEVEL. THE ALARM SYSTEM SHALL BE PROVIDED WITH A BATTERY BACK-UP IN CASE OF POWER FAILURE.

V). A CONFINED SPACE DANGER SIGN SHALL BE PROVIDED AT ALL ACCESS POINTS TO THE PUMP OUT STORAGE TANK IN ACCORDANCE WITH THE UPPER PARRAMATTA RIVER CATCHMENT TRUST OSD HANDBOOK.

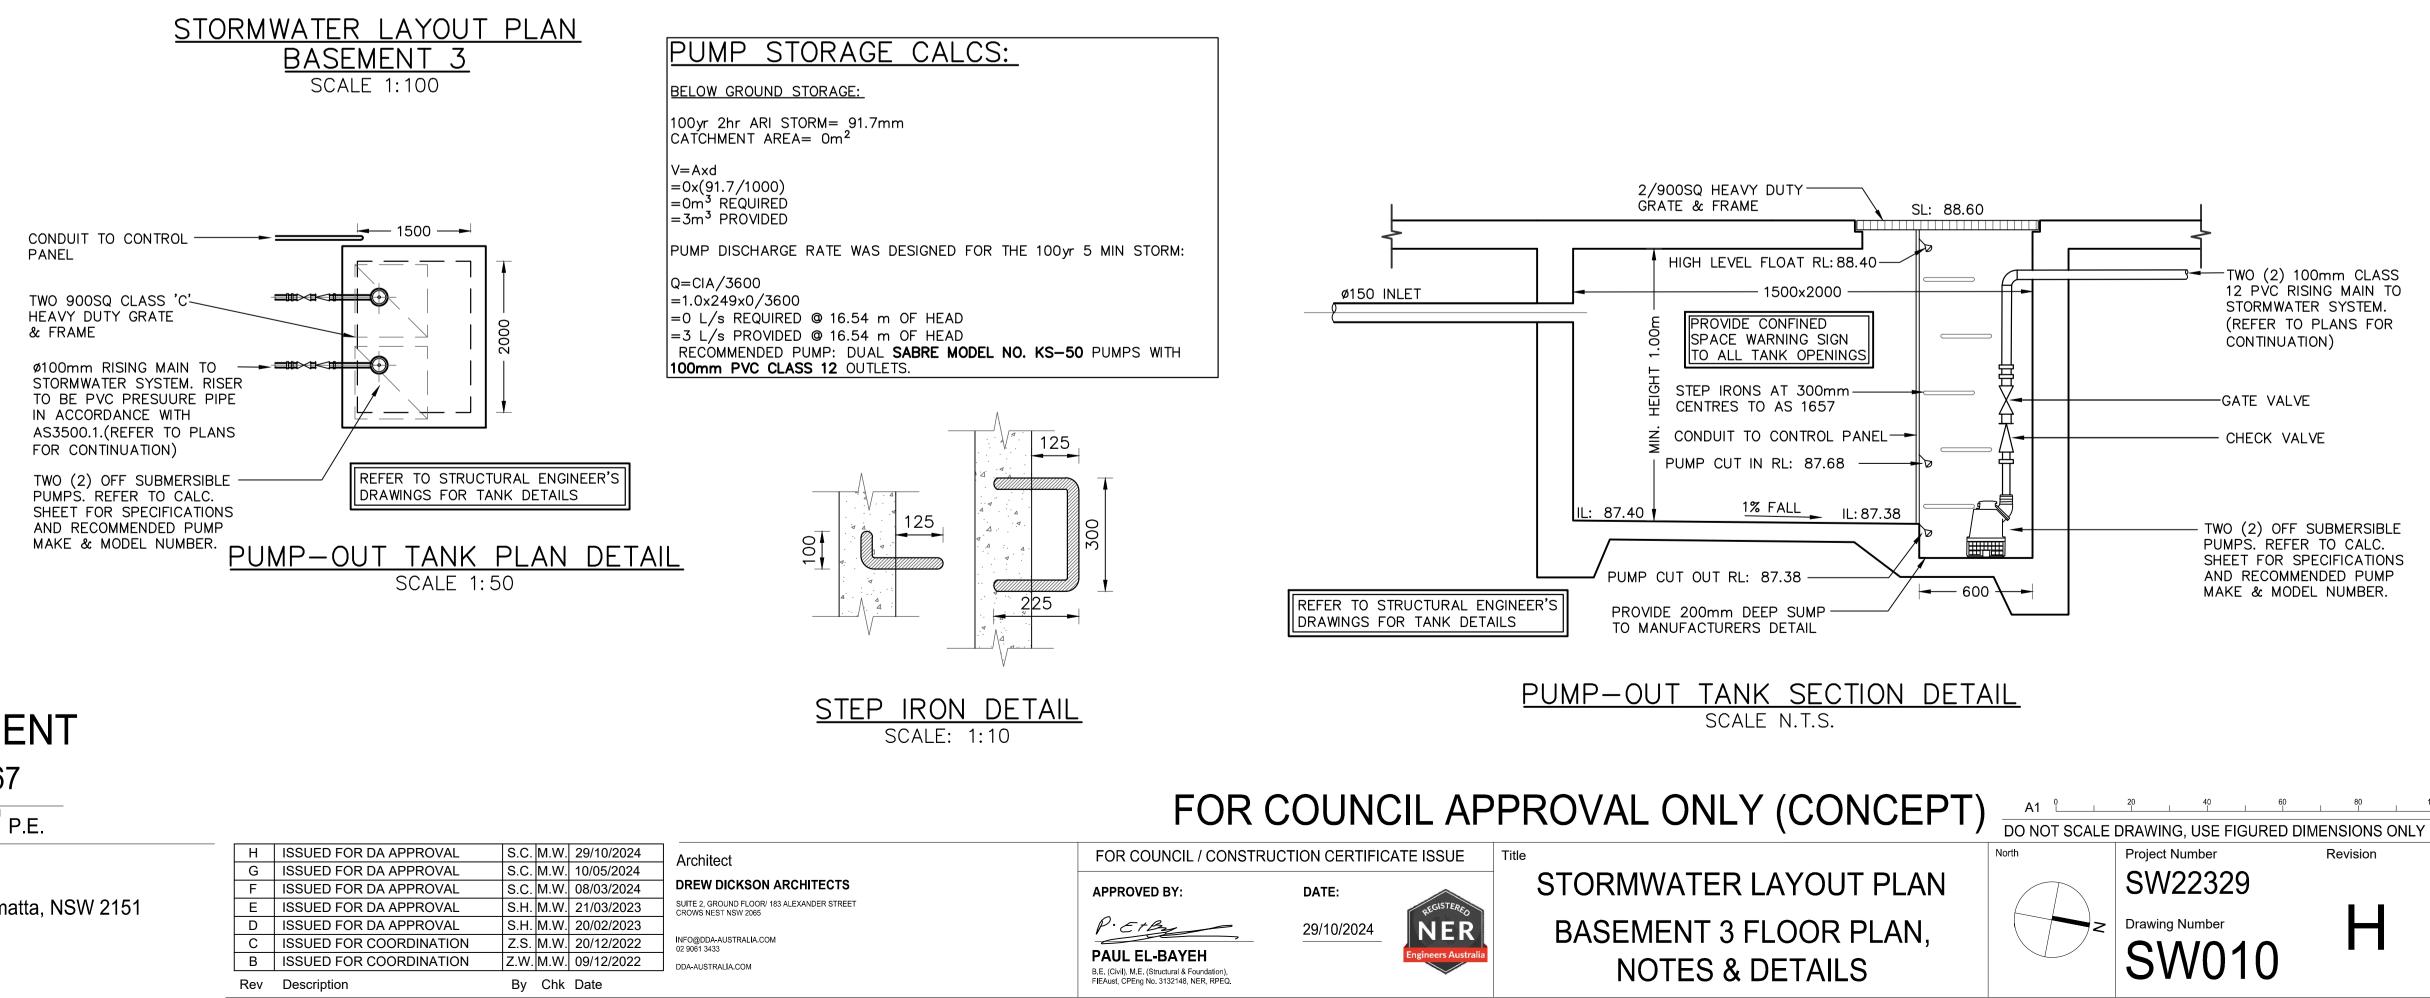

# PROPOSED MIXED USE DEVELOPMENT

"S.C.


58 ANDERSON STREET, CHATSWOOD NSW 2067




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S.C.

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	С	ISSUED FOR COORDINATION
	В	ISSUED FOR COORDINATION
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STORMWATER LAYOUT PLAN BASEMENT 2 SCALE 1:100

PROPOSED MIXED USE DEVELOPMENT
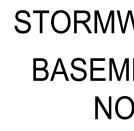
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Design

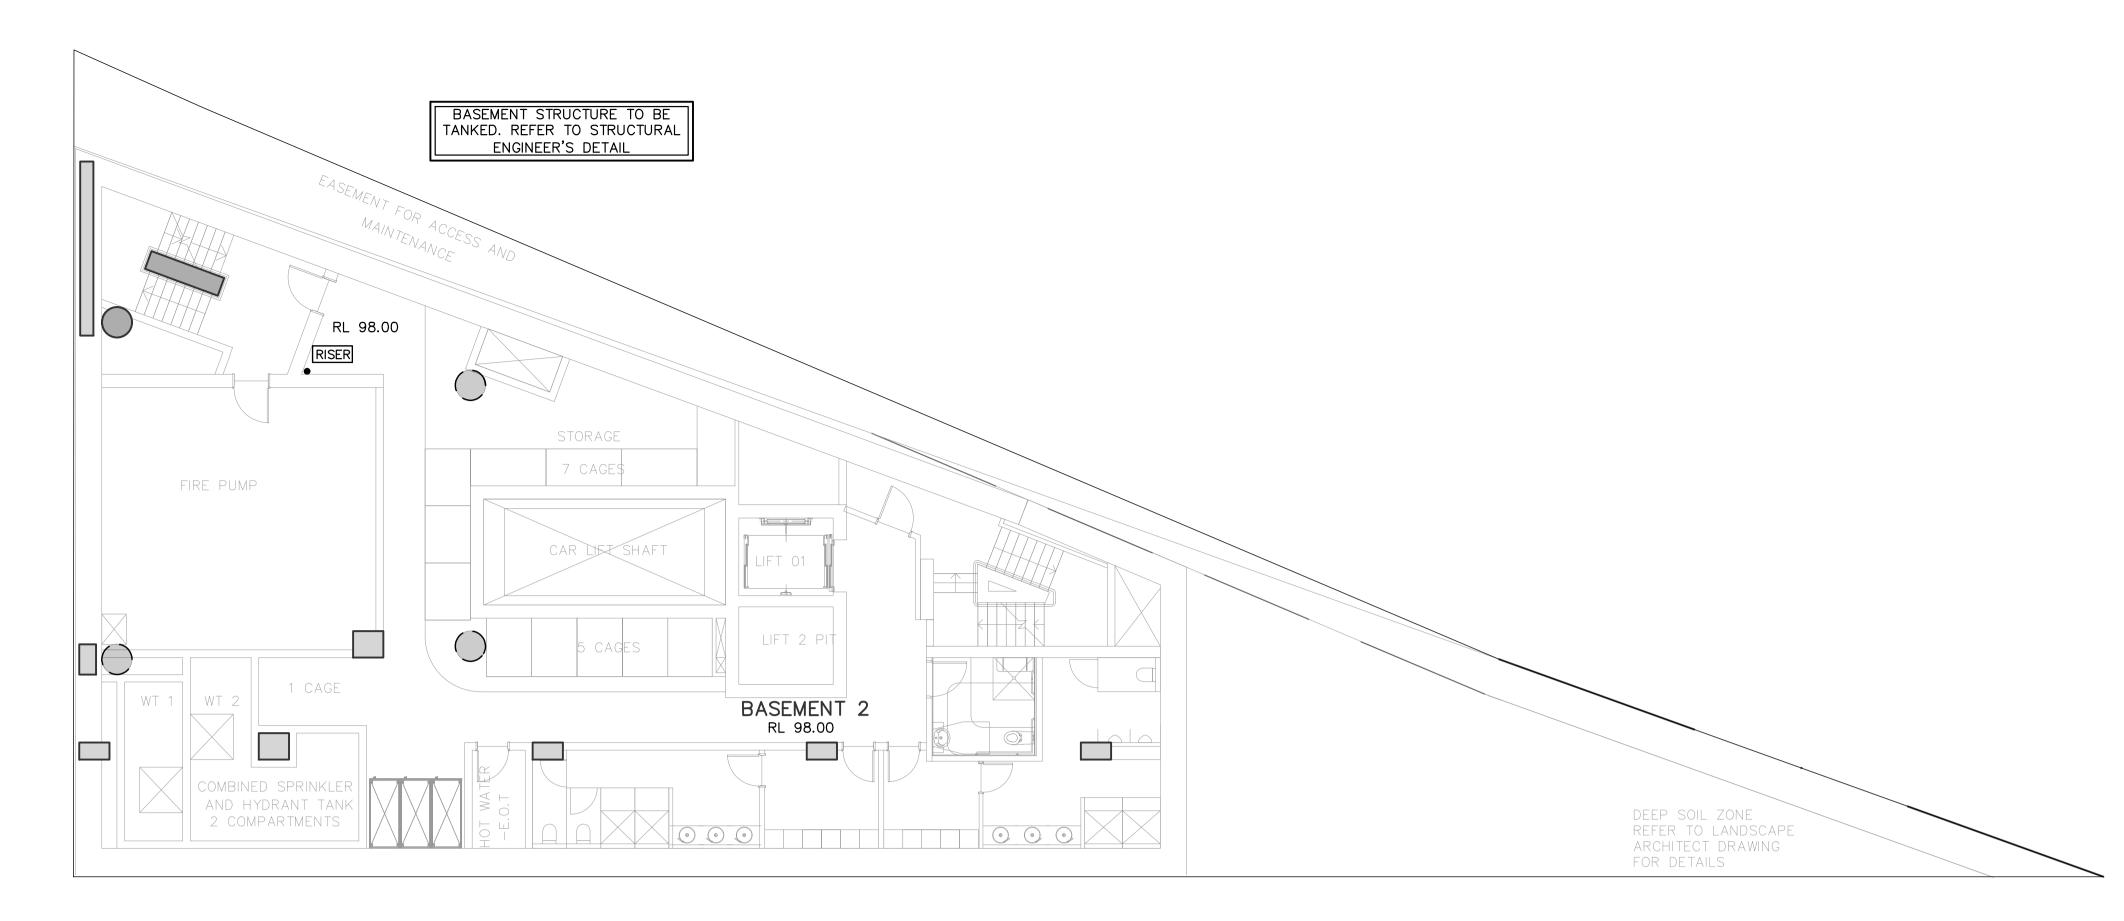S.C.


58 ANDERSON STREET, CHATSWOOD NSW 2067




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Rev	Description



- ALL DISH DRAIN OUTLET LINES CAST IN SLAB TO BE MIN. Ø100 SEWER GRADE upvc at MIN 1% Fall.
- DISCHARGE DISH DRAIN OUTLETS INTO STORMWATER PITS AT 10m C-C MAXIMUM
- INTERVALS (WHERE PRACTICAL) - REFER TO STRUCTURAL ENGINÉERS PLANS FOR ALL STRUCTURAL DETAILS AND
- SPECIFICATIONS.

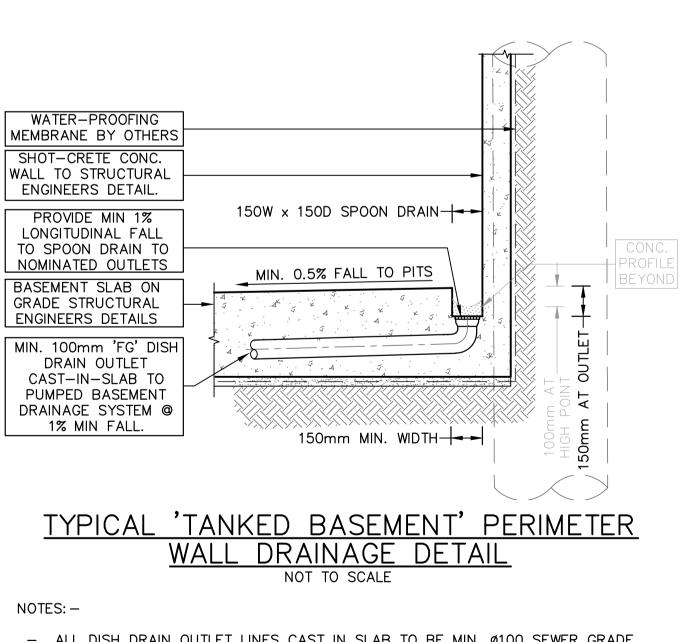


DRAINS BEHIND SHOT-CRETE WALL

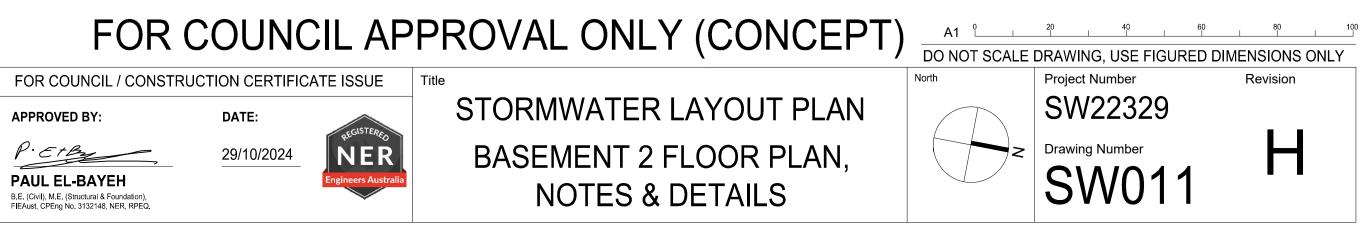

Architect DREW DICKSON ARCHITECTS SUITE 2, GROUND FLOOR/ 183 ALEXANDER STREET CROWS NEST NSW 2065

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APPROVED BY:

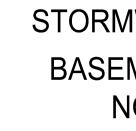

- AGGREGATE TRENCH SHALL BE MIN. 300mm WIDE WITH 10-20mm BLUE METAL - DISCHARGE SUB-SOIL DRAINAGE LINES INTO STORMWATER PITS AT 10m C-C MAXIMUM INTERVALS (WHERE PRACTICAL)

- CLEAR-OUT POINTS TO BE PROVIDED FOR FLUSHING OF SUB-SOIL LINE AT HIGH

- REFER TO STRUCTURAL ENGINEERS DETAILS FOR SPACING OF VERTICAL STRIP


PERIMETER DRAINAGE DETAIL


NOT TO SCALE

- ALL SUB-SOIL DRAINAGE LINES SHALL BE MIN Ø100 SLOTTED PVC OR AGRICULTURAL PIPE WITH FILTER FABRIC/SOCK

END, INTERMEDIATE POINTS AND ALL CHANGES IN DIRECTION

NOTES: -

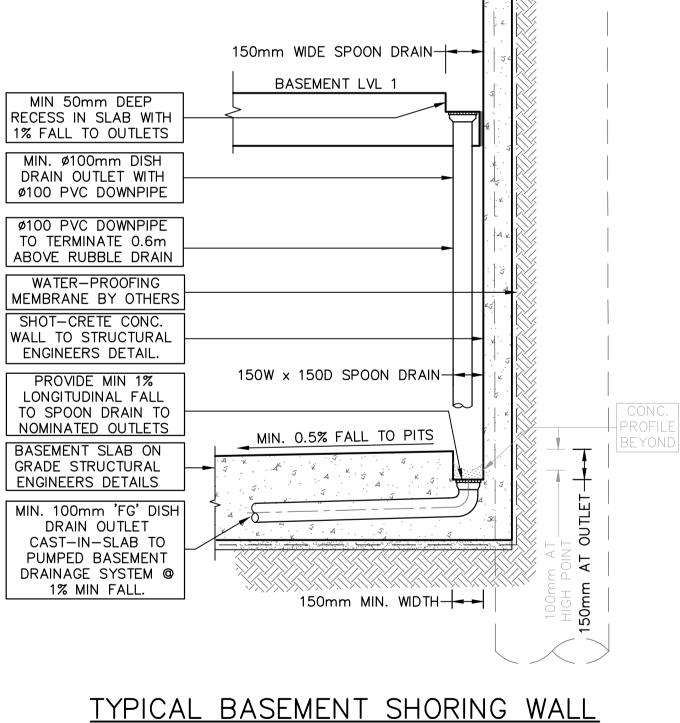

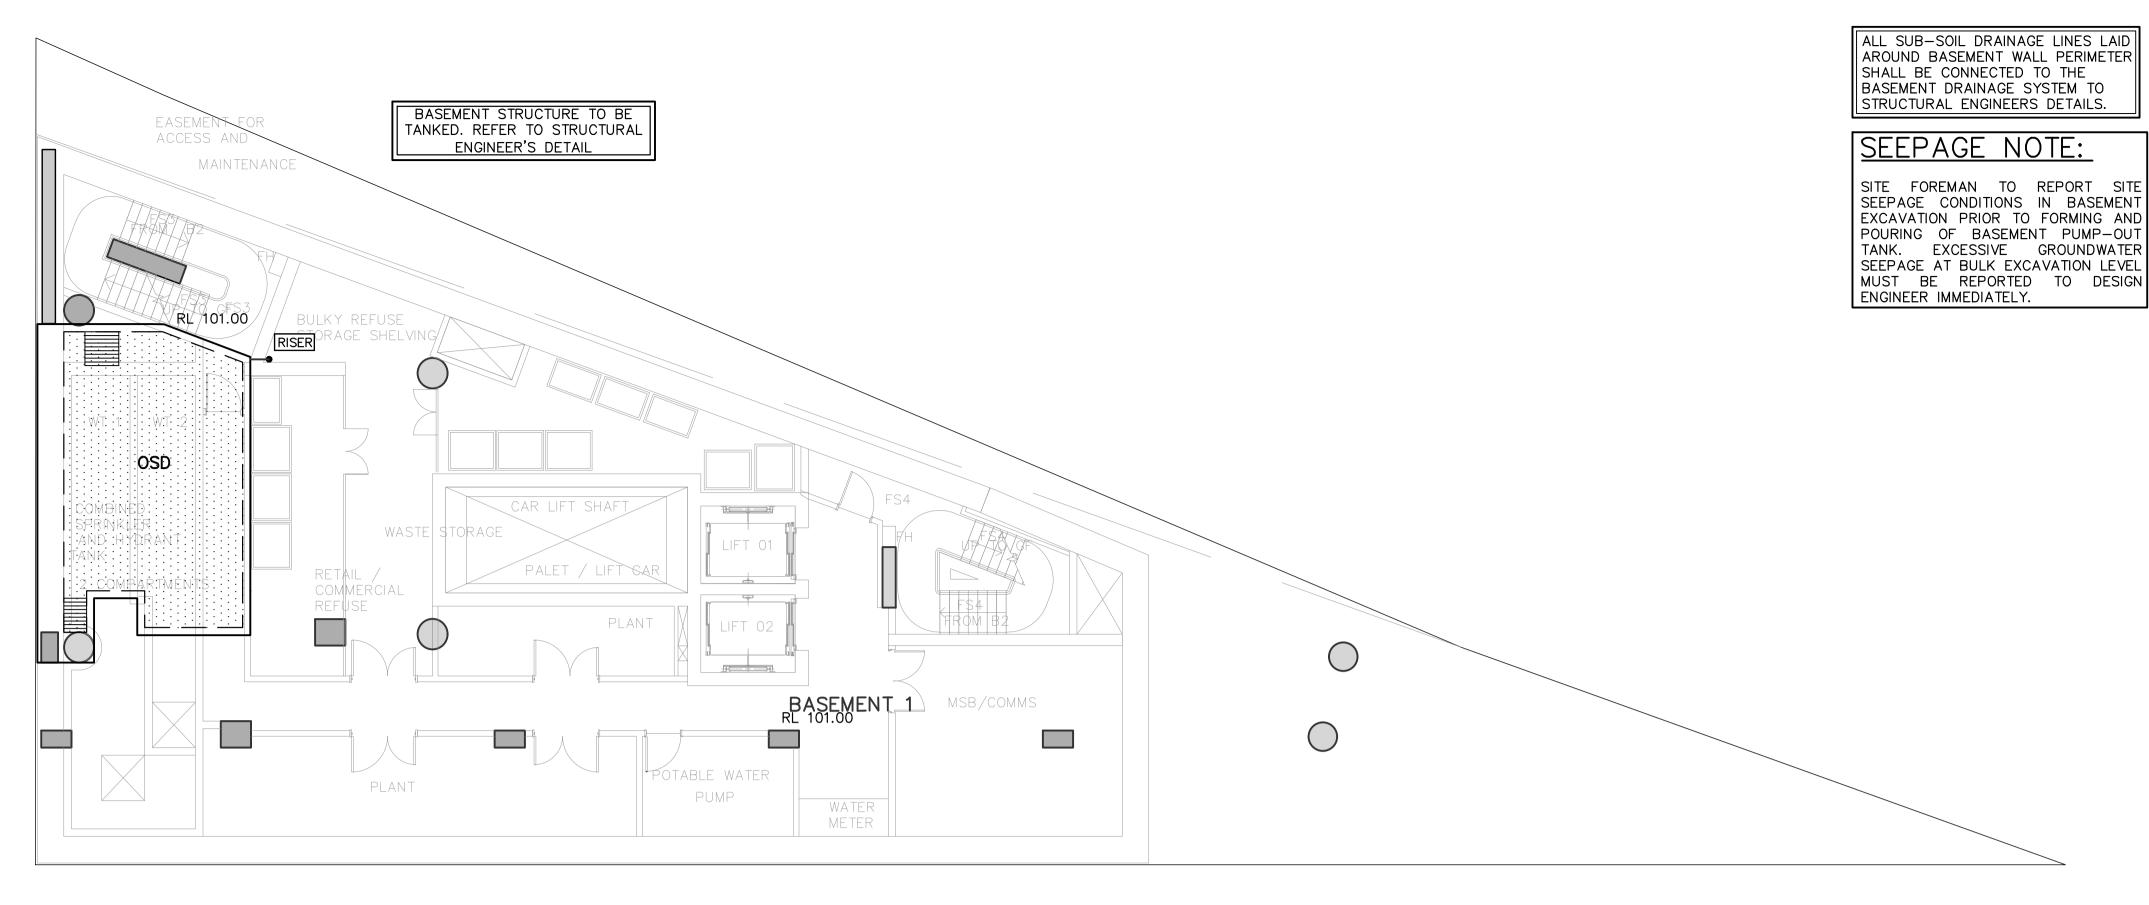

# STORMWATER LAYOUT PLAN BASEMENT 1 SCALE 1:100

# PROPOSED MIXED USE DEVELOPMENT

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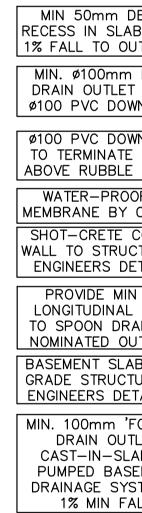
58 ANDERSON STREET, CHATSWOOD NSW 2067 Design S.C.



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Approved P.E.

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NOTES: -


- ALL SUB-AGRICULT – AGGREGA - DISCHARG
- DISCHARGI
   MAXIMUM
   CLEAR-OL
   END, INTE
   REFER TO
   DRAINS BI
- FOR COUNCIL APPROVAL OF

FOR COUNCIL / CONSTRUCTION CERTIFICATE ISSUE

APPROVED BY:

DATE: 29/10/2024



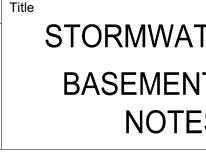



S.C. M.W. 29/10/2024 Architect S.C. M.W. 10/05/2024 S.C. M.W. 08/03/2024 S.H. M.W. 21/03/2023 S.H. M.W. 20/02/2023 Z.S. M.W. 20/12/2022 Z.W. M.W. 09/12/2022 By Chk Date


DREW DICKSON ARCHITECTS SUITE 2, GROUND FLOOR/ 183 ALEXANDER STREET CROWS NEST NSW 2065 INFO@DDA-AUSTRALIA.COM 02 9061 3433 DDA-AUSTRALIA.COM

P.EtB PAUL EL-BAYEH B.E. (Civil), M.E. (Structural & Foundation), FIEAust, CPEng No. 3132148, NER, RPEQ.


150mm WIDE SPOON DRAIN
EEP 3 WITH
DISH WITH NPIPE
NPIPE 0.6m
DRAIN       FING
OTHERS
1% 150W × 150D SPOON DRAIN
TLETS MIN. 0.5% FALL TO PITS
B ON JRAL AILS
TEM @ LL. 150mm MIN. WIDTH
<u>PICAL BASEMENT SHORING WALL</u> PERIMETER DRAINAGE DETAIL
NOT TO SCALE
-SOIL DRAINAGE LINES SHALL BE MIN Ø100 SLOTTED PVC OR URAL PIPE WITH FILTER FABRIC/SOCK TE TRENCH SHALL BE MIN. 300mm WIDE WITH 10–20mm BLUE METAL
E SUB-SOIL DRAINAGE LINES INTO STORMWATER PITS AT 10m C-C INTERVALS (WHERE PRACTICAL)
UT POINTS TO BE PROVIDED FOR FLUSHING OF SUB-SOIL LINE AT HIGH RMEDIATE POINTS AND ALL CHANGES IN DIRECTION STRUCTURAL ENGINEERS DETAILS FOR SPACING OF VERTICAL STRIP
EHIND SHOT-CRETE WALL
NLY (CONCEPT) A1 DO NOT SCALE DRAWING, USE FIGURED DIMENSIONS ONLY
North     Project Number     Revision       TER LAYOUT PLAN     SW22329
T 1 FLOOR PLAN,
S & DETAILS SW012

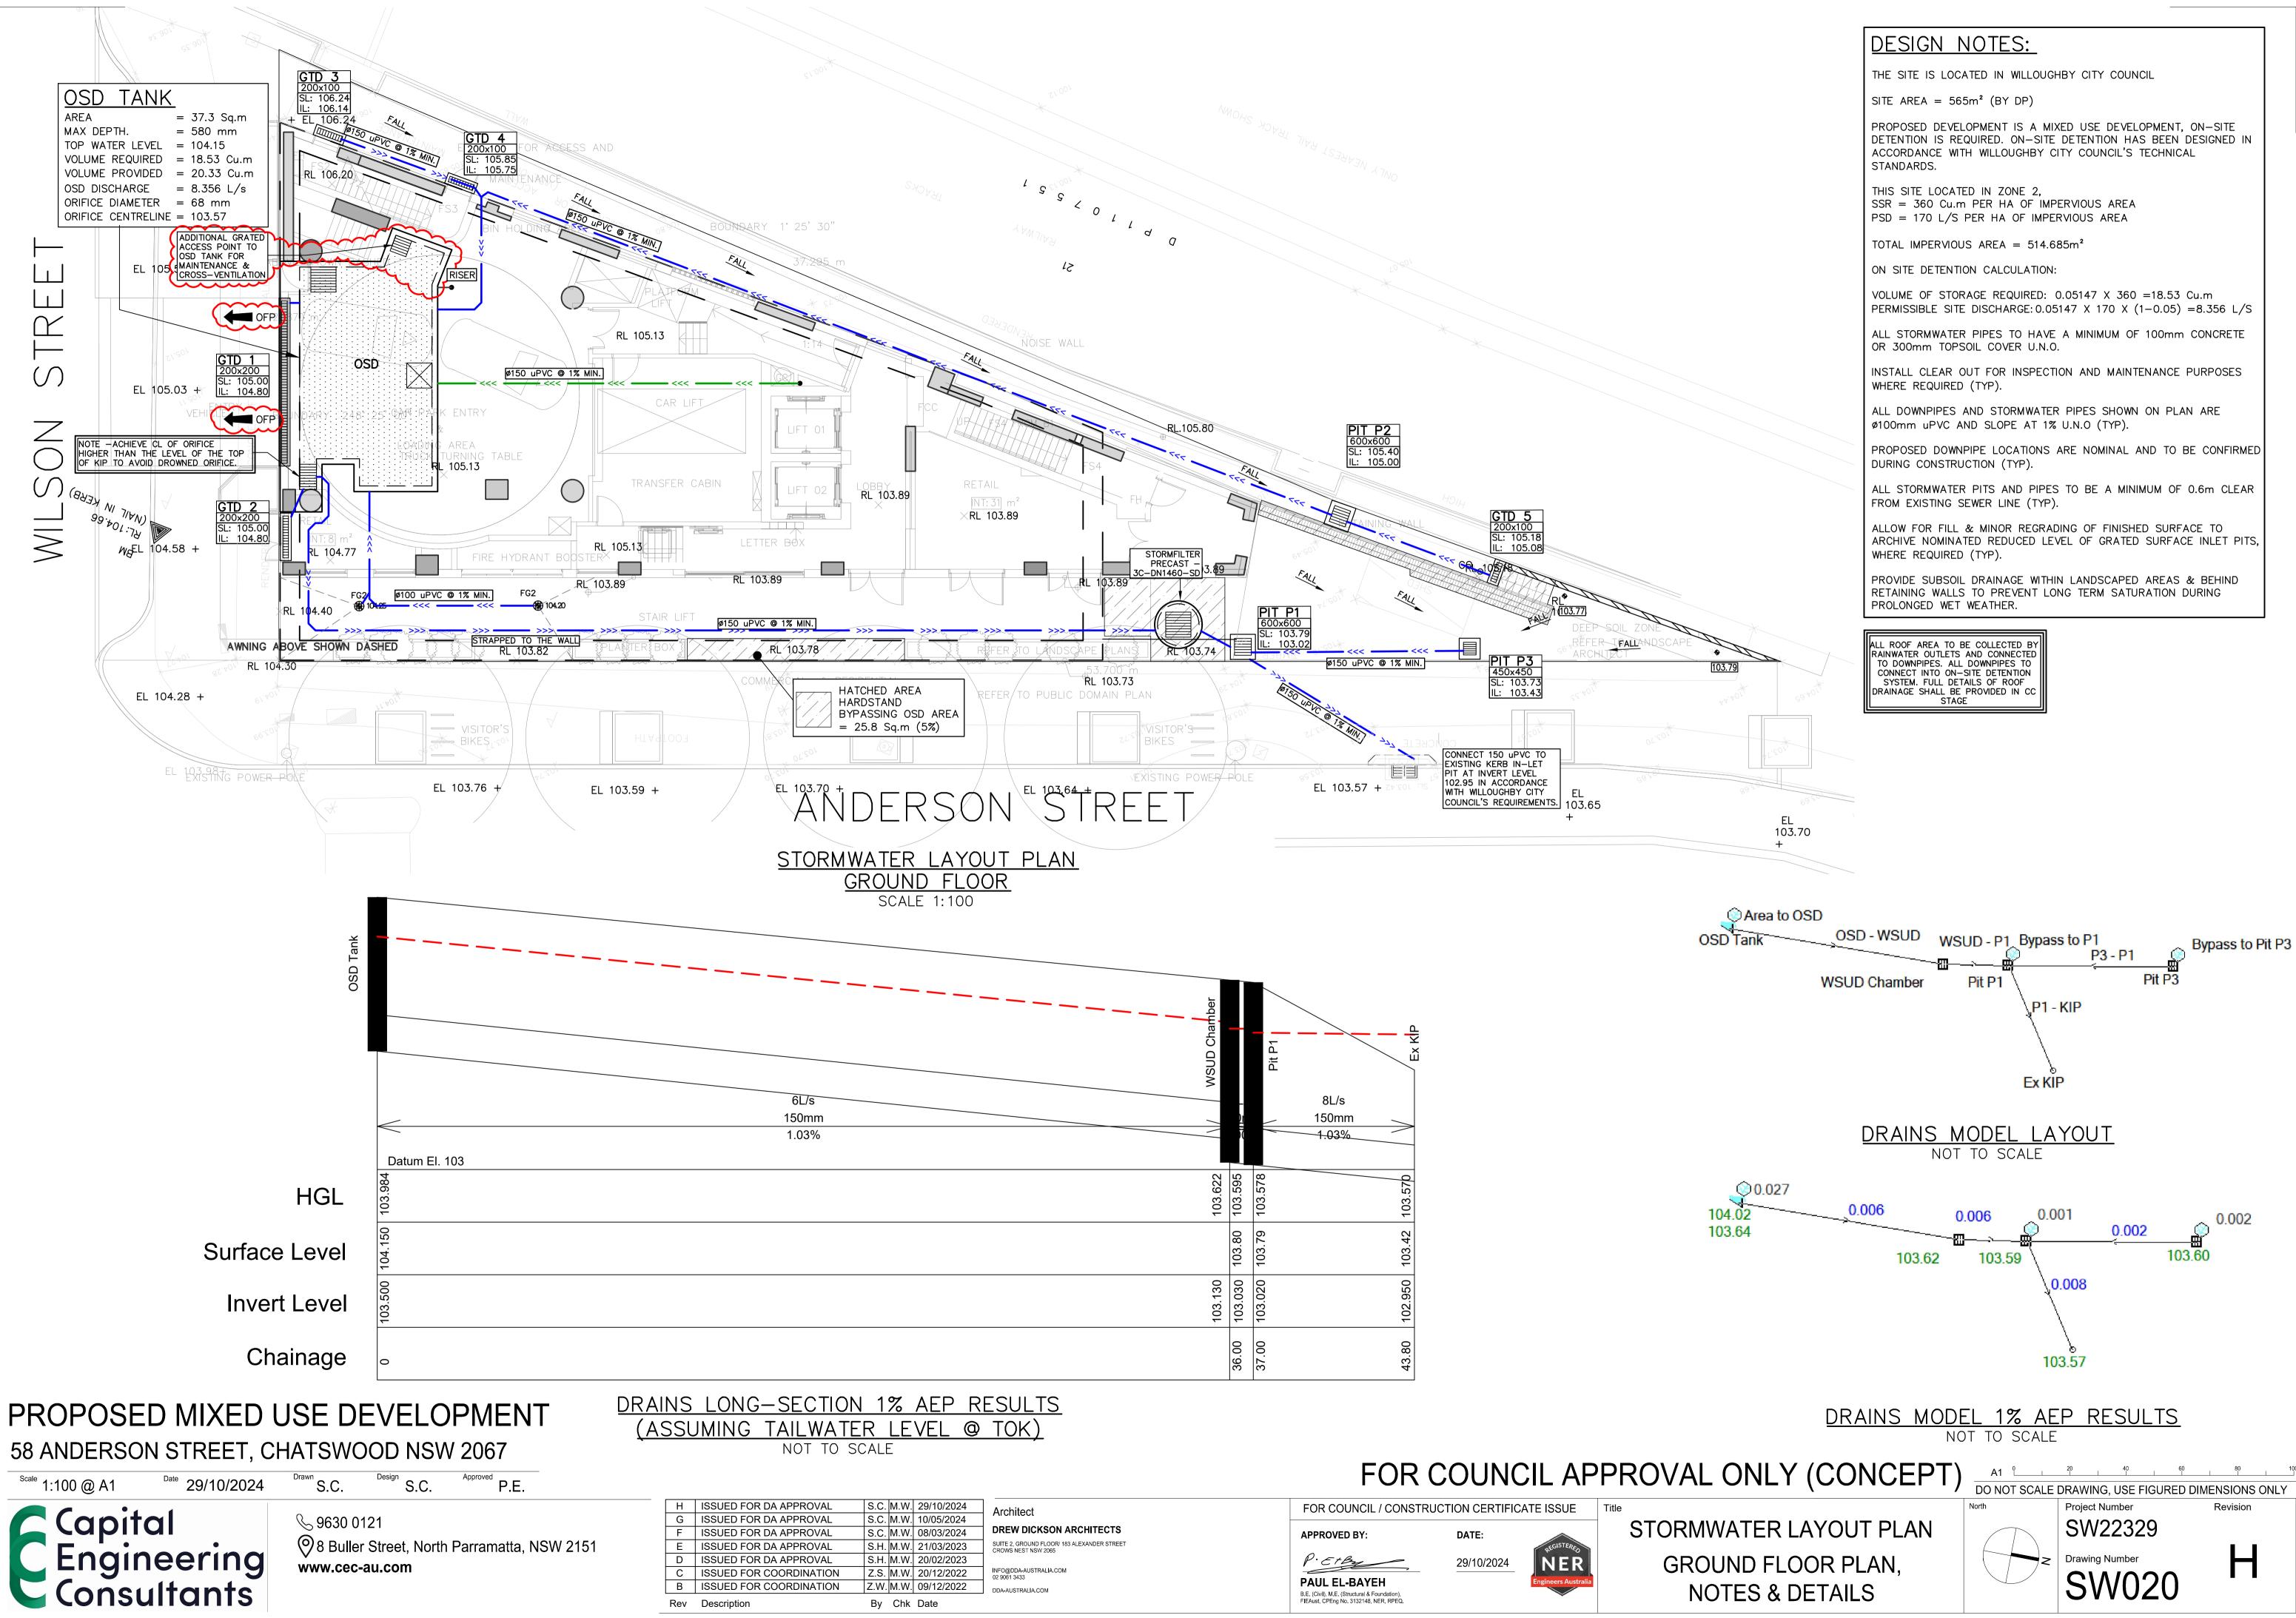

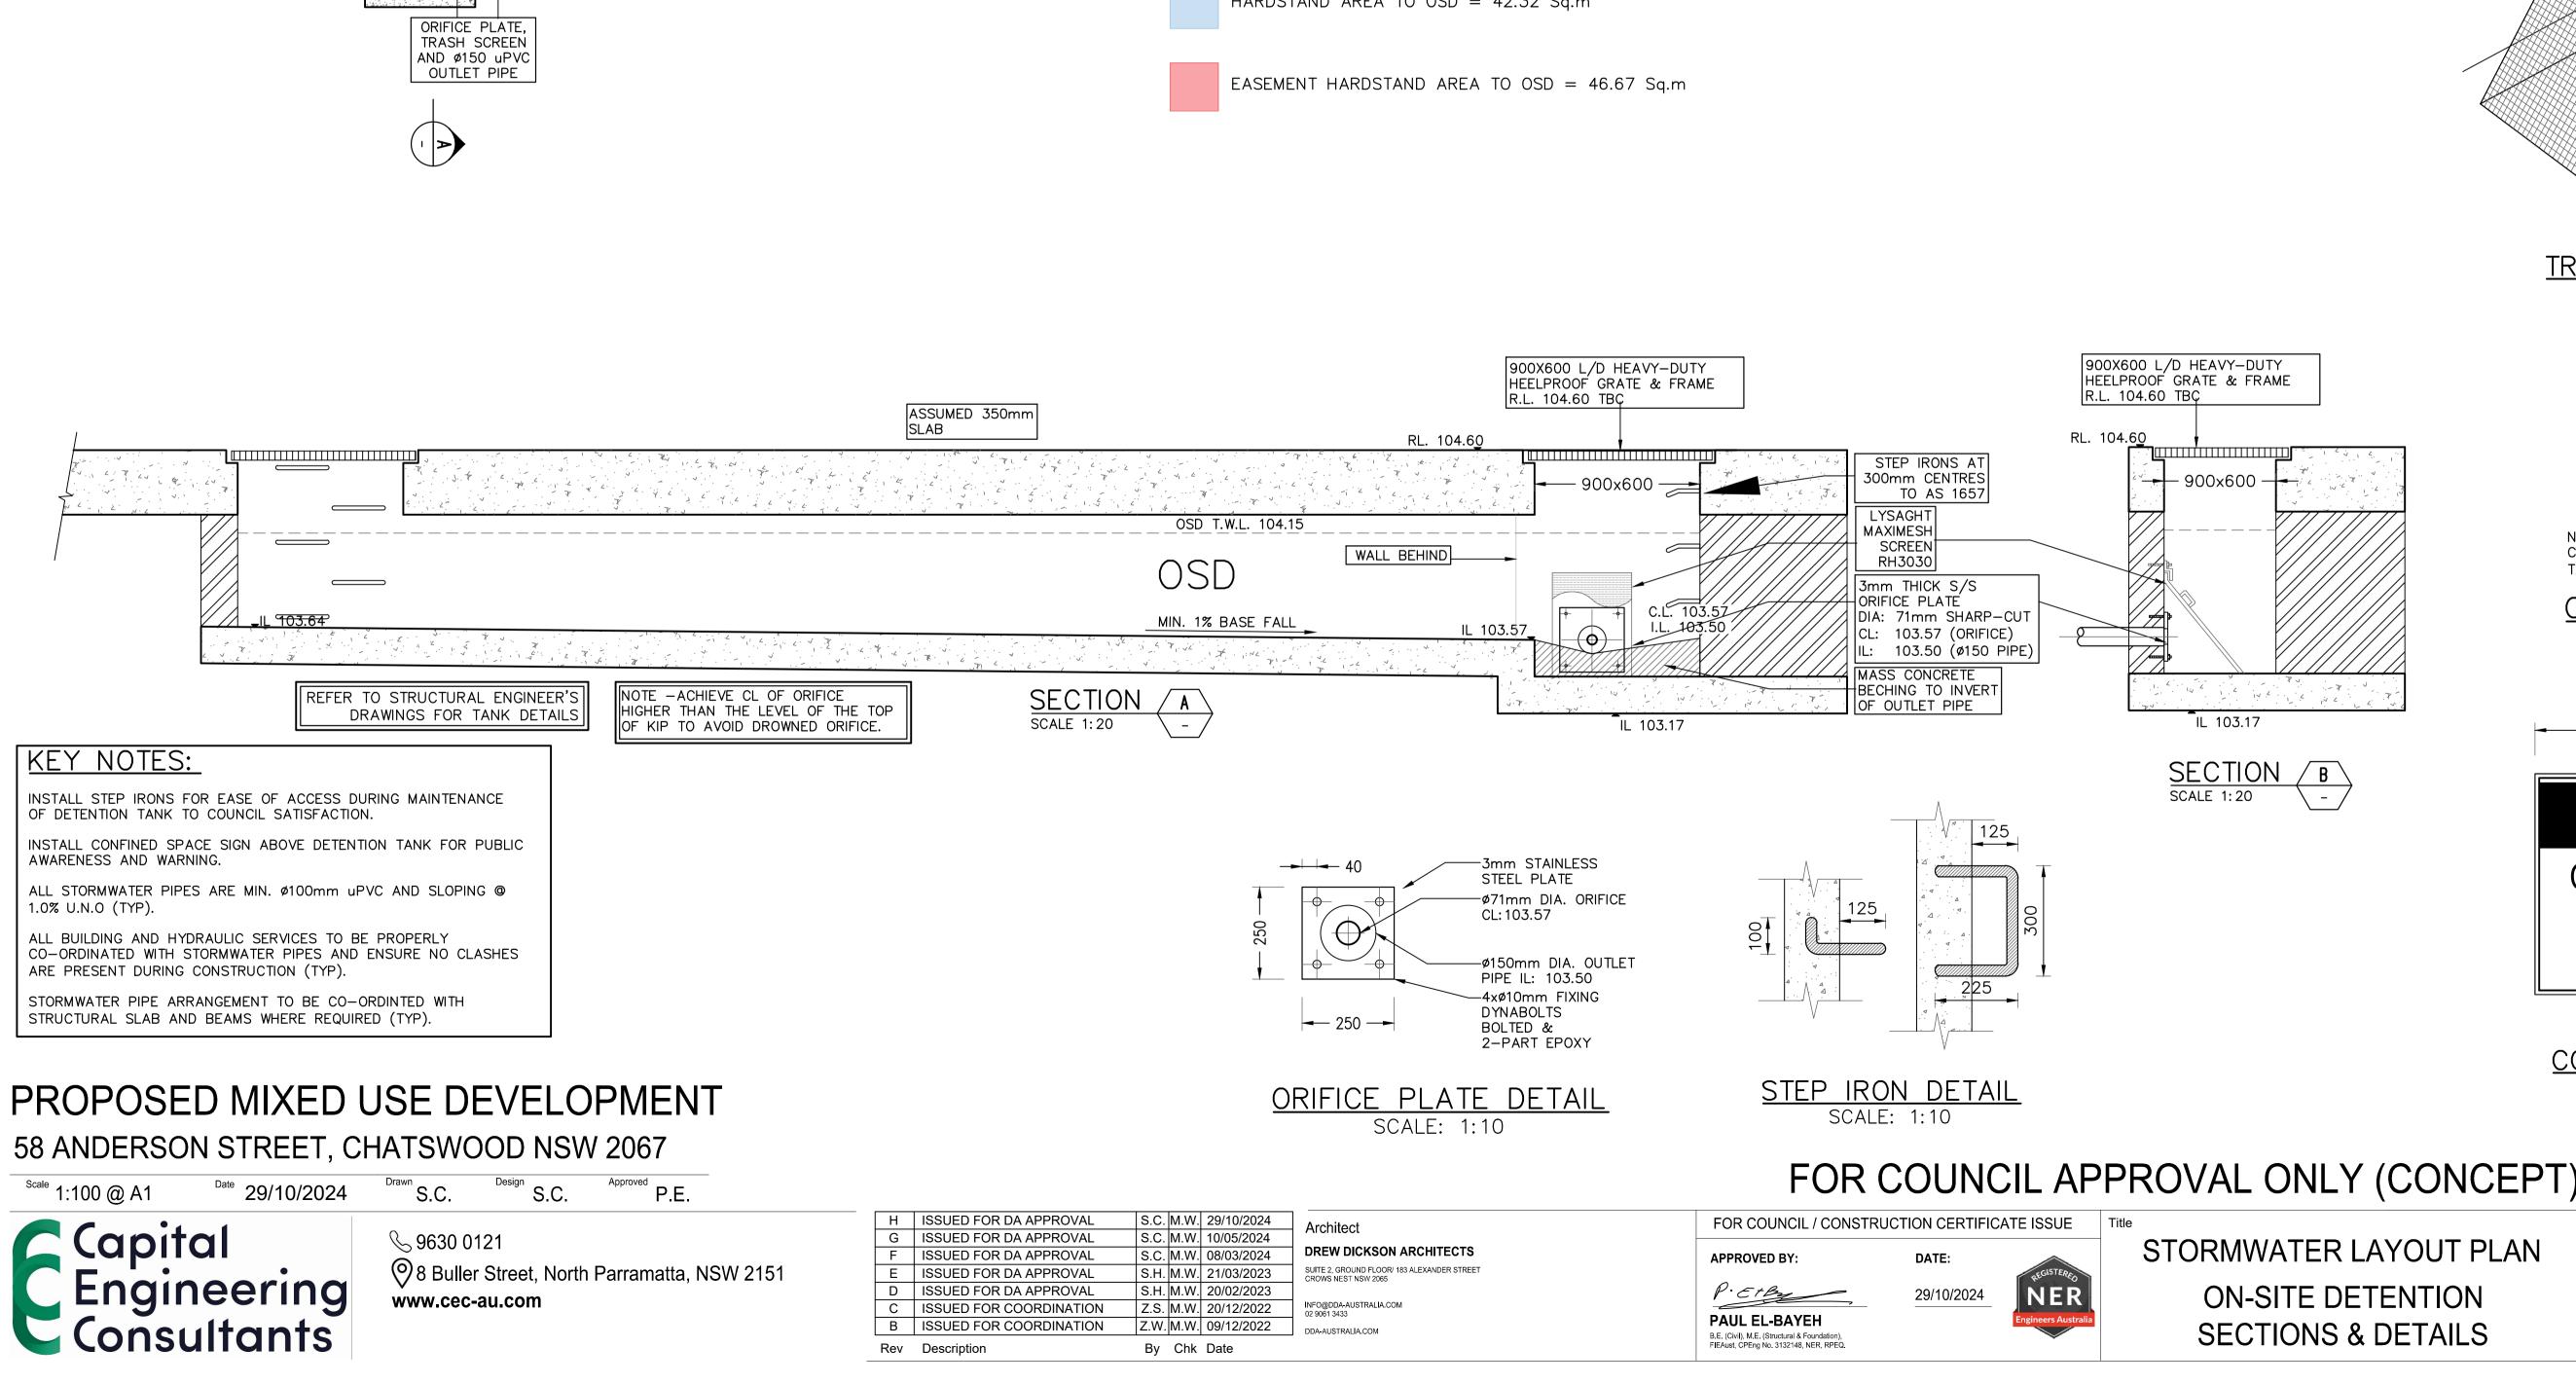

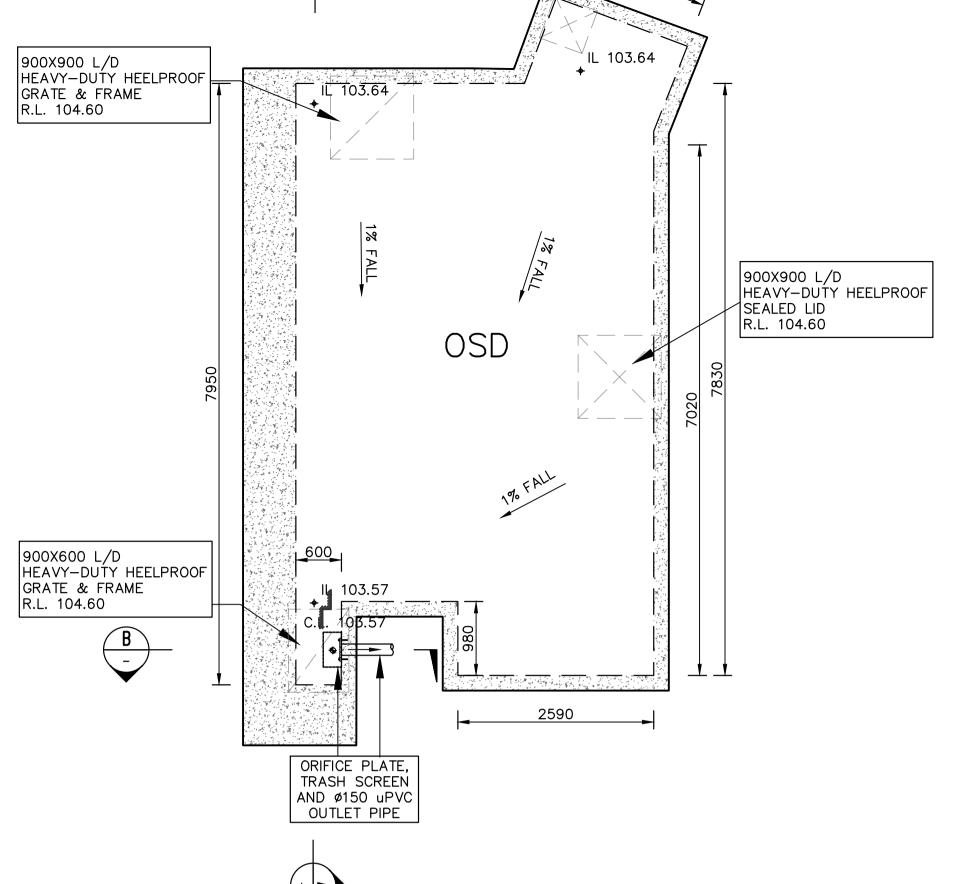

/850

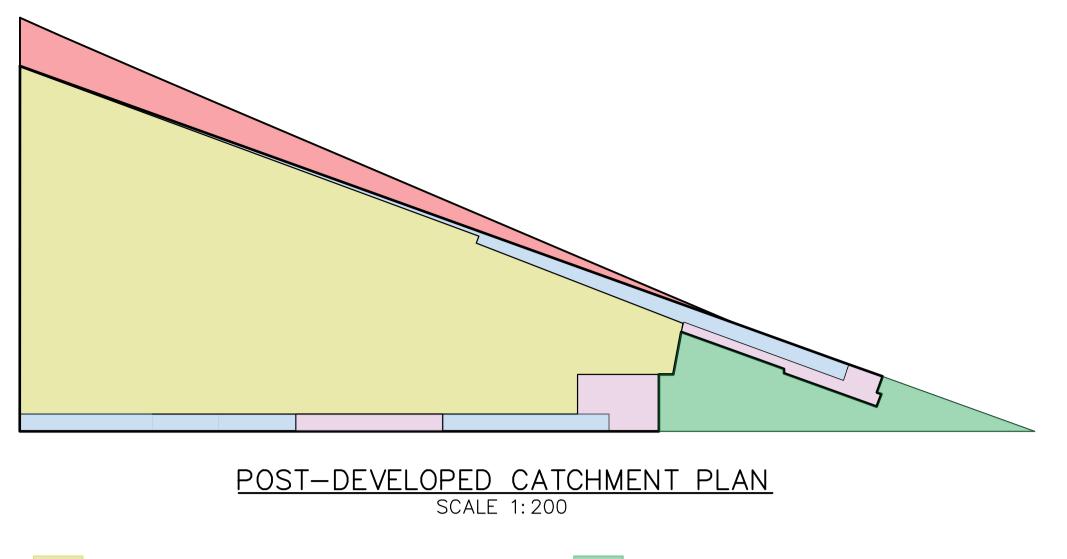



ROOF AREA TO OSD = 399.9 Sq.m

PERVIOUS AREA BYPASS OSD = 50.31 Sq.m

HARDSTAND AREA BYPASS OSD = 25.8 Sq.m

HARDSTAND AREA TO OSD = 42.32 Sq.m

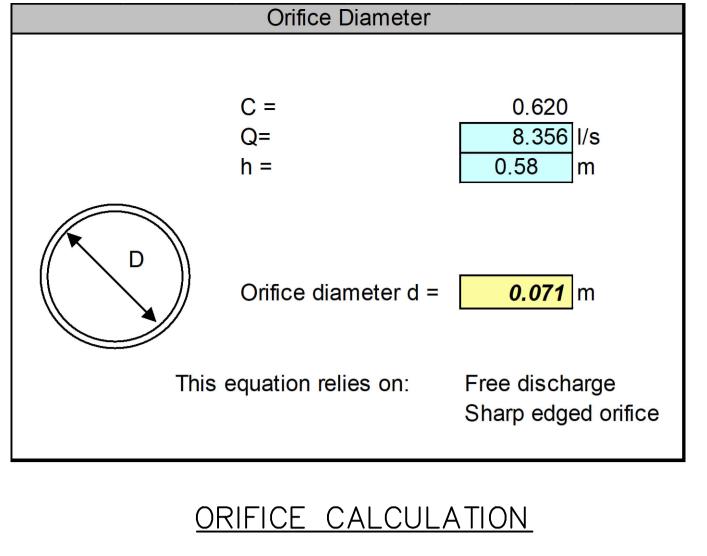


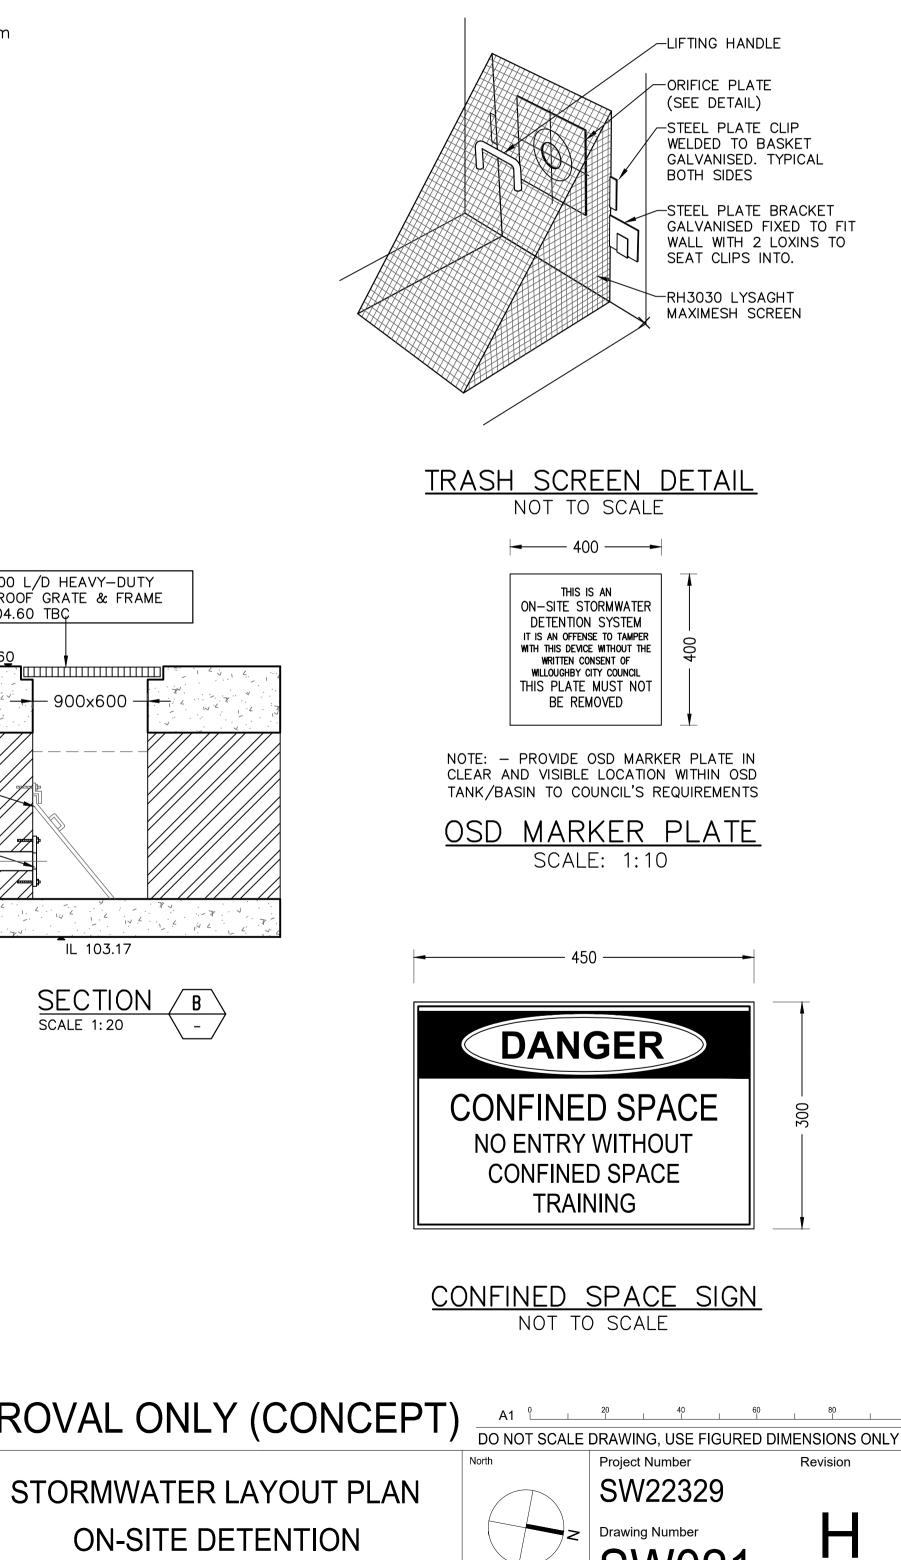

SW02<sup>2</sup>

**SECTIONS & DETAILS** 

V K

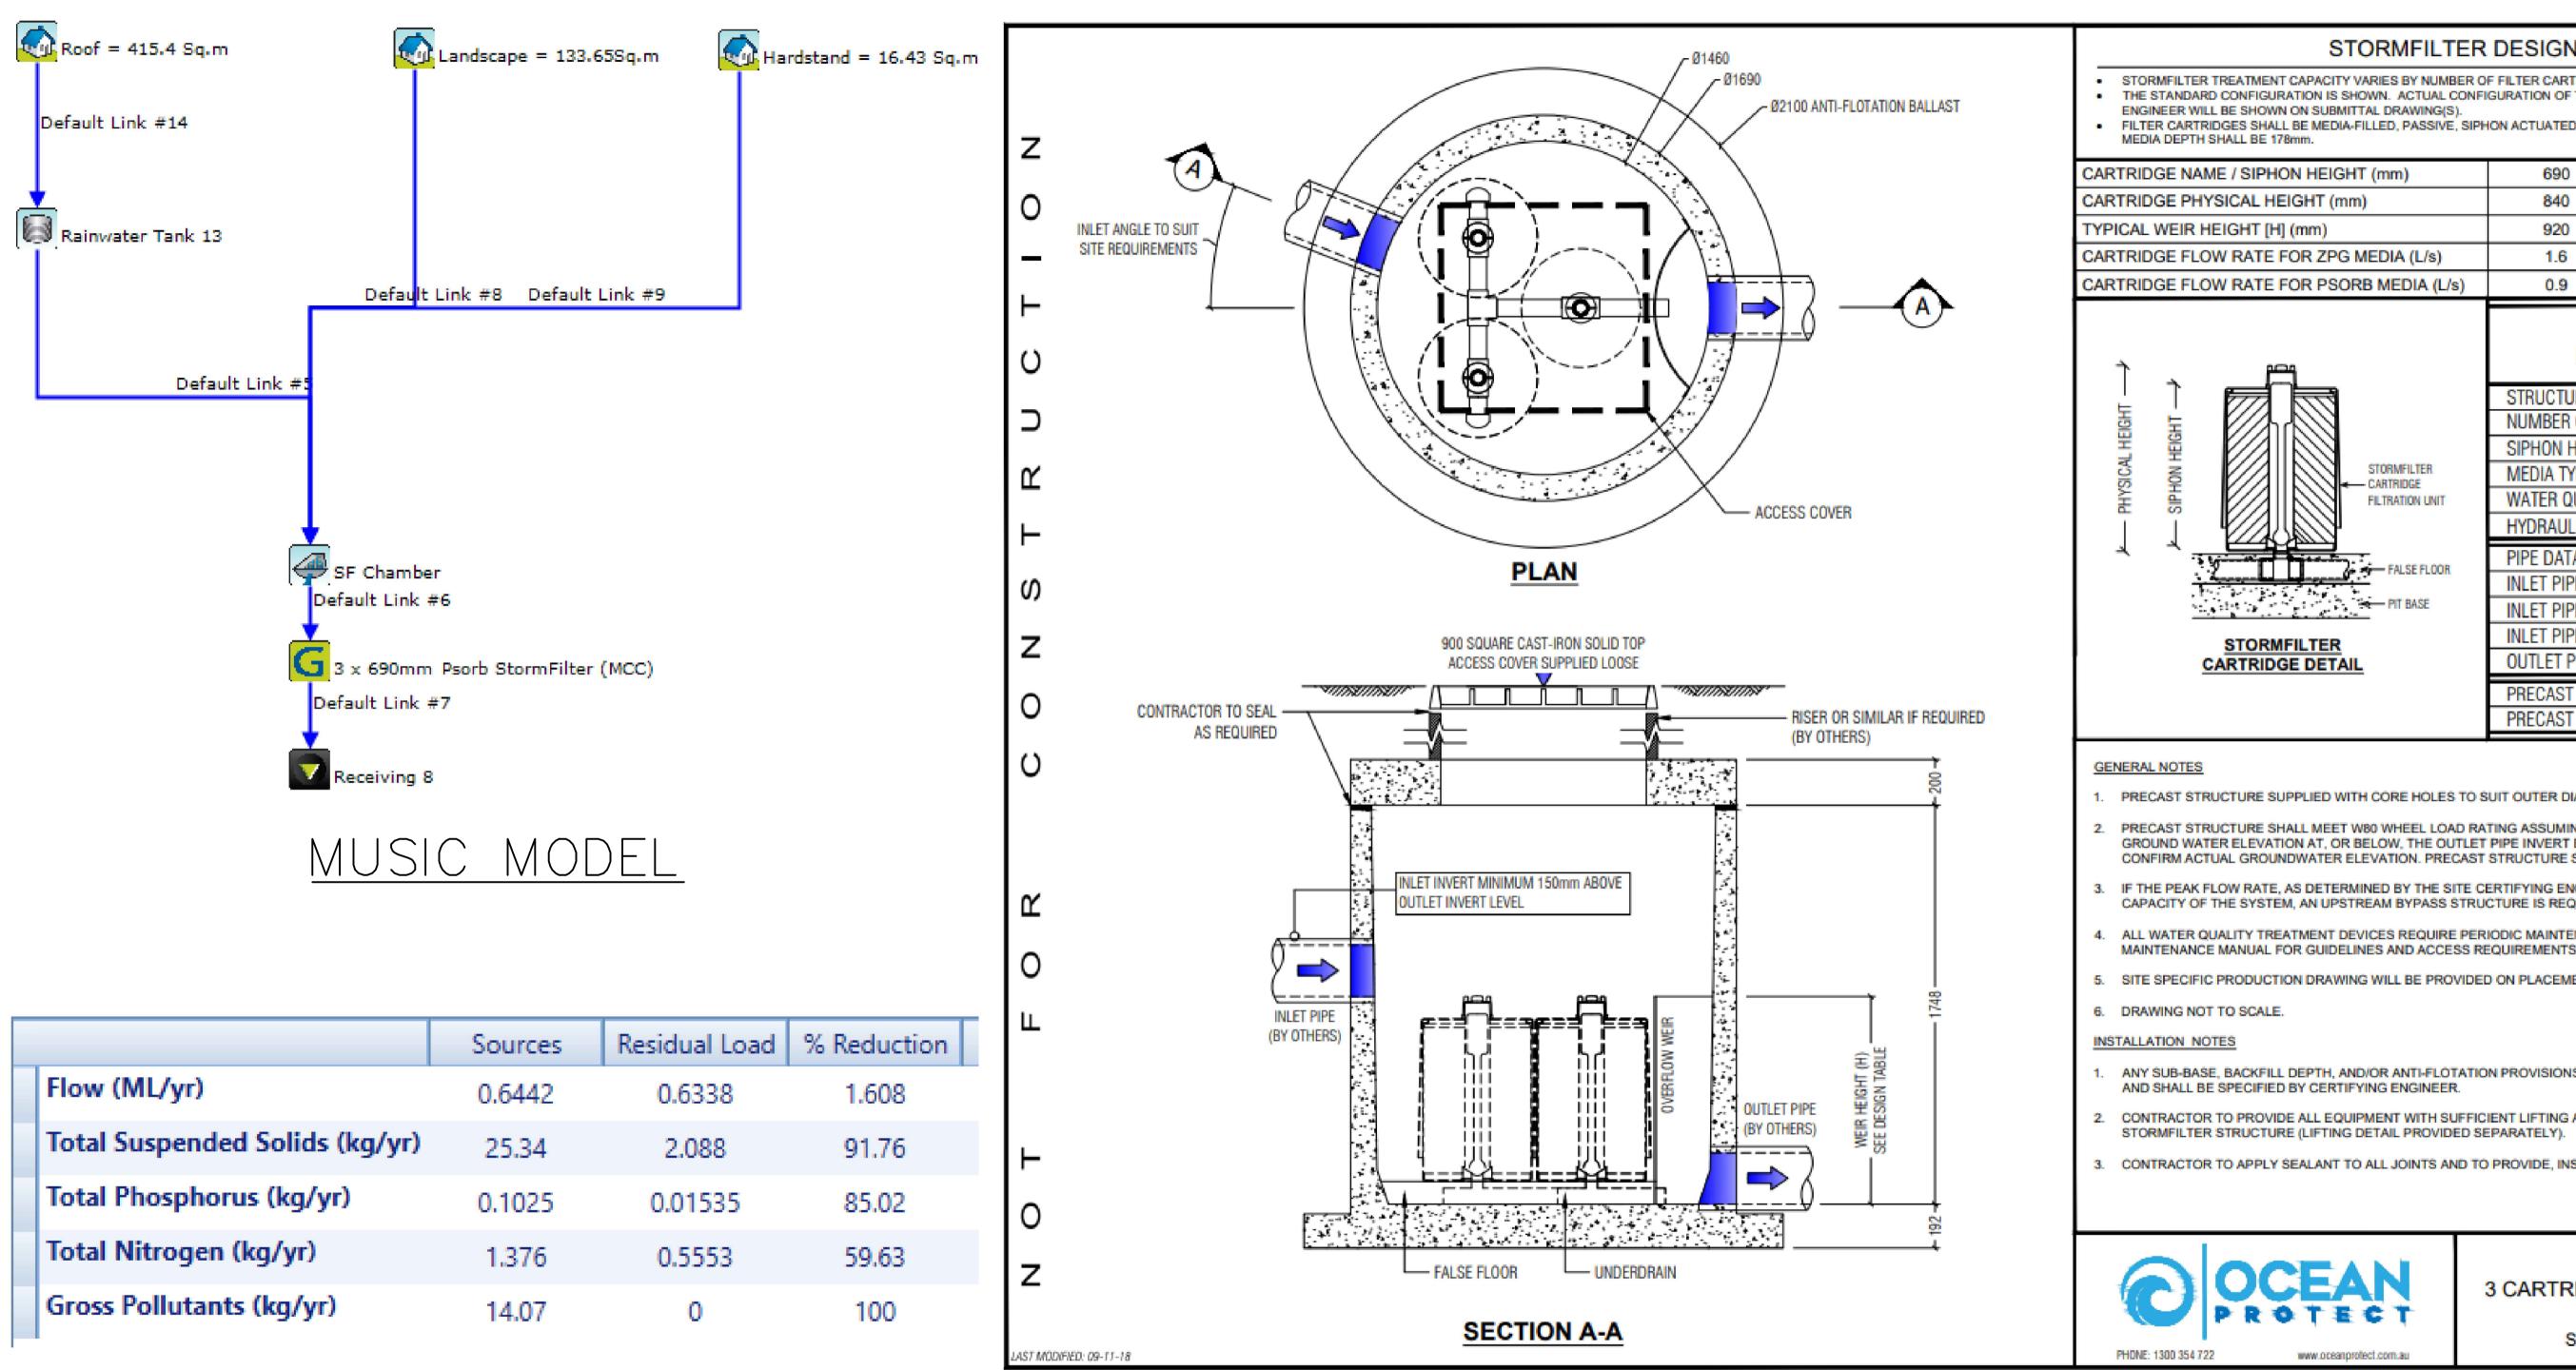

	Sources	Residual Load	% Reduction
Flow (ML/yr)	0.6442	0.6338	1.608
Total Suspended Solids (kg/yr)	25.34	2.088	91.76
Total Phosphorus (kg/yr)	0.1025	0.01535	85.02
Total Nitrogen (kg/yr)	1.376	0.5553	59.63
Gross Pollutants (kg/yr)	14.07	0	100

MUSIC RESULT

# PROPOSED MIXED USE DEVELOPMENT

S.C.

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E	ISSUED FOR DA APPROVAL
D	ISSUED FOR DA APPROVAL
С	ISSUED FOR COORDINATION
В	ISSUED FOR COORDINATION
Rev	Description

# FOR COUNCIL APPROVAL ONLY (CONCEPT)



Architect DREW DICKSON ARCHITECTS SUITE 2, GROUND FLOOR/ 183 ALEXANDER STREE CROWS NEST NSW 2065 INFO@DDA-AUSTRALIA.COM 02 9061 3433 DDA-AUSTRALIA.COM

FOR COUNCIL / CONSTRUCTION CERTIFICATE ISSUE

DATE:

**APPROVED BY:** 

NER 29/10/2024



Title

P.EtBy PAUL EL-BAYEH B.E. (Civil), M.E. (Structural & Foundation EAust, CPEng No. 3132148, NER, RPEQ.

### STORMFILTER DESIGN TABLE

REATMENT CAPACITY VARIES BY NUMBER OF FILTER CARTRIDGES INSTALLED. ONFIGURATION IS SHOWN. ACTUAL CONFIGURATION OF THE SPECIFIED STRUCTURE(S) PER CERTIFYING FILTER CARTRIDGES SHALL BE MEDIA-FILLED, PASSIVE, SIPHON ACTUATED, RADIAL FLOW, AND SELF-CLEANING, RADIAL

/ SIPHON HEIGHT (mm)	690	460	310
ICAL HEIGHT (mm)	840	600	600
GHT [H] (mm)	920	690	540
RATE FOR ZPG MEDIA (L/s)	1.6	1.1	0.7
RATE FOR PSORB MEDIA (L/s)	0.9	0.46	0.39

i <del>ci</del>		ITE SPECI REQUIRE	
	STRUCTURE ID		[ ]
	NUMBER OF CART	RIDGES REQ'D	3
	SIPHON HEIGHT (3	10 / 460 / 690)	[ ]
STORMFILTER	MEDIA TYPE (ZPG)	/ PSORB)	[ ]
FILTRATION UNIT	WATER QUALITY FL	LOW RATE (L/S)	[ ]
	HYDRAULIC CAPA	CITY (L/S)	90
FALSE FLOOR	PIPE DATA:	I.L. M/	ATERIAL DIAMETER
PALSE PLOON	INLET PIPE #1	[ ][	][ ]
- PIT BASE	INLET PIPE #2	[ ]	][ ]
TORMFILTER	INLET PIPE #3	[ ][	][ ]
RTRIDGE DETAIL	OUTLET PIPE	[ ][	][ ]
	PRECAST MANHOL	E WEIGHT	4100kg
	PRECAST LID WEIG	SHT	1100kg

PRECAST STRUCTURE SUPPLIED WITH CORE HOLES TO SUIT OUTER DIAMETER OF NOMINATED PIPE SIZE / MATERIAL

PRECAST STRUCTURE SHALL MEET W80 WHEEL LOAD RATING ASSUMING A MAXIMUM EARTH COVER OF 2.0m AND A GROUND WATER ELEVATION AT, OR BELOW, THE OUTLET PIPE INVERT ELEVATION, CERTIFYING ENGINEER TO CONFIRM ACTUAL GROUNDWATER ELEVATION PRECAST STRUCTURE SHALL

IF THE PEAK FLOW RATE, AS DETERMINED BY THE SITE CERTIFYING ENGINEER, EXCEEDS THE PEAK HYDRAULIC CAPACITY OF THE SYSTEM, AN UPSTREAM BYPASS STRUCTURE IS REQUIRED

4. ALL WATER QUALITY TREATMENT DEVICES REQUIRE PERIODIC MAINTENANCE. REFER TO OPERATION AND

5. SITE SPECIFIC PRODUCTION DRAWING WILL BE PROVIDED ON PLACEMENT OF ORDER.

ANY SUB-BASE, BACKFILL DEPTH, AND/OR ANTI-FLOTATION PROVISIONS ARE SITE-SPECIFIC DESIGN CONSIDERATIONS

2. CONTRACTOR TO PROVIDE ALL EQUIPMENT WITH SUFFICIENT LIFTING AND REACH CAPACITY TO LIFT AND SET THE STORMFILTER STRUCTURE (LIFTING DETAIL PROVIDED SEPARATELY).

CONTRACTOR TO APPLY SEALANT TO ALL JOINTS AND TO PROVIDE, INSTALL AND GROUT INLET AND OUTLET PIPES

### OCEAN PROTECT 3 CARTRIDGE STORMFILTER SYSTEM DN1460 MANHOLE SPECIFICATION DRAWING



STORMWATER LAYOUT PLAN STORMFILTER SYSTEM **SECTIONS & DETAILS** 

A1 Ĺ DO NOT SCALE DRAWING, USE FIGURED DIMENSIONS ONLY


Revision

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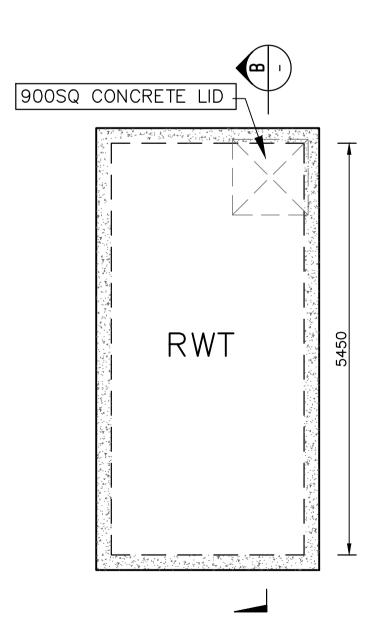
**Project Number** 


SW22329

**Drawing Number** SW022



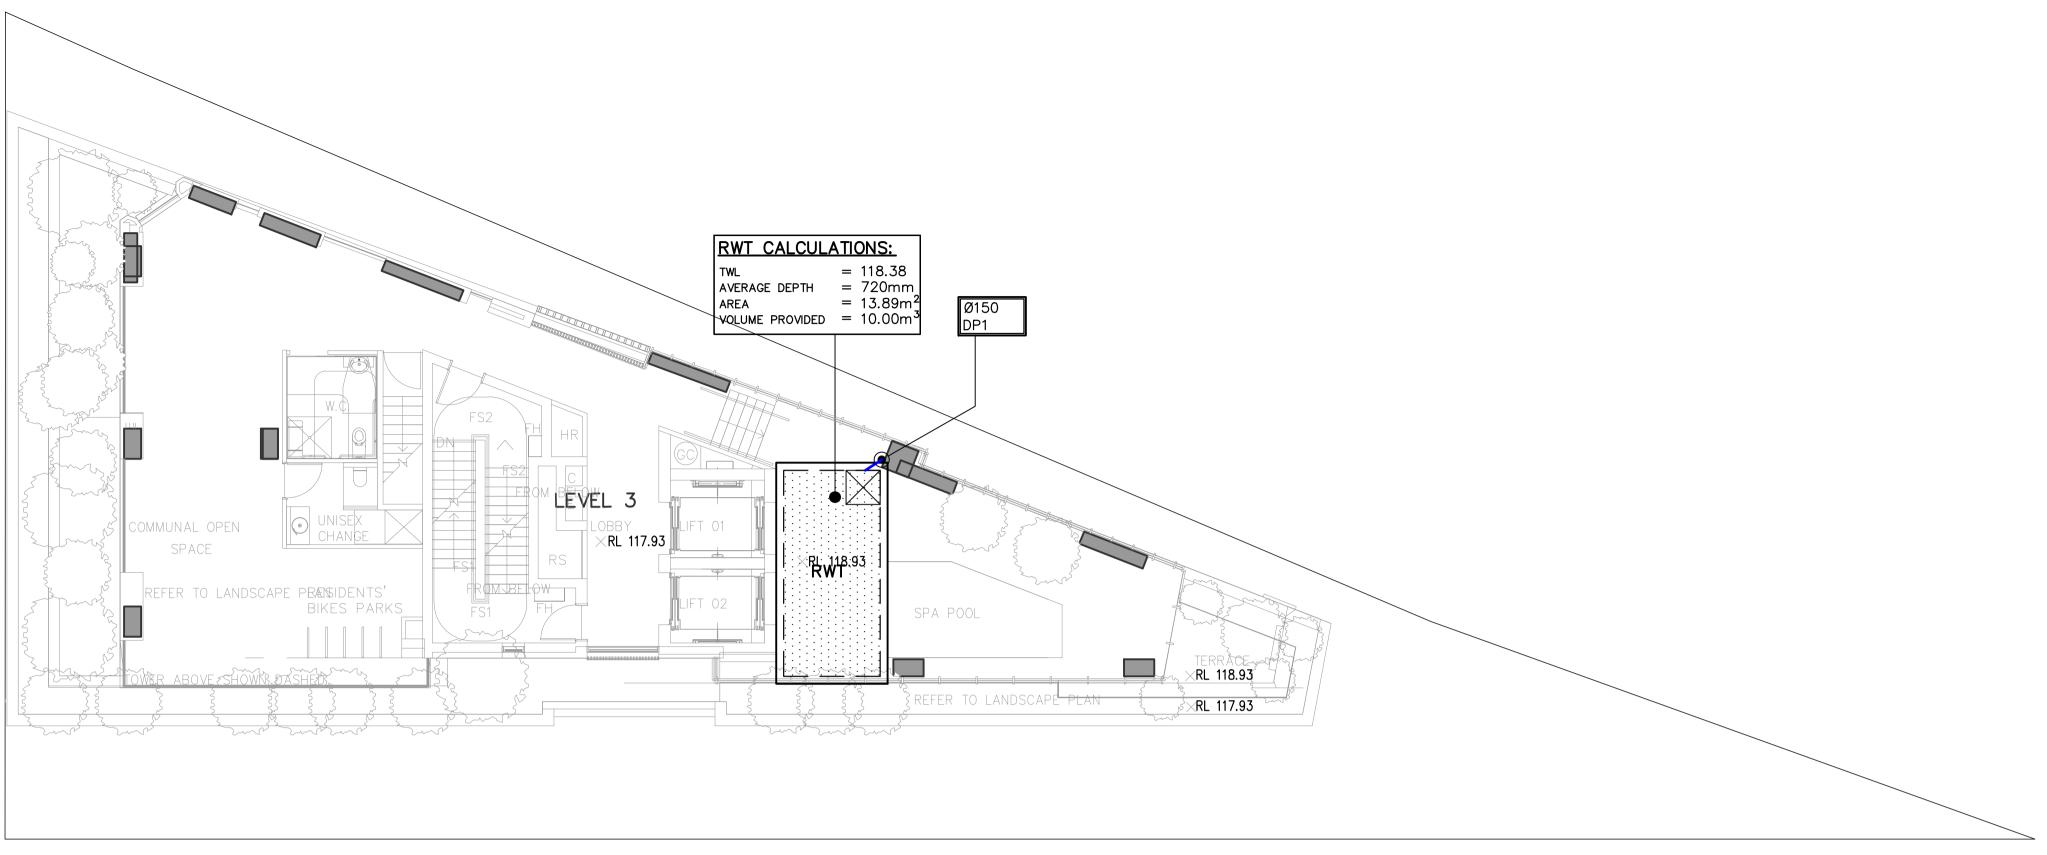



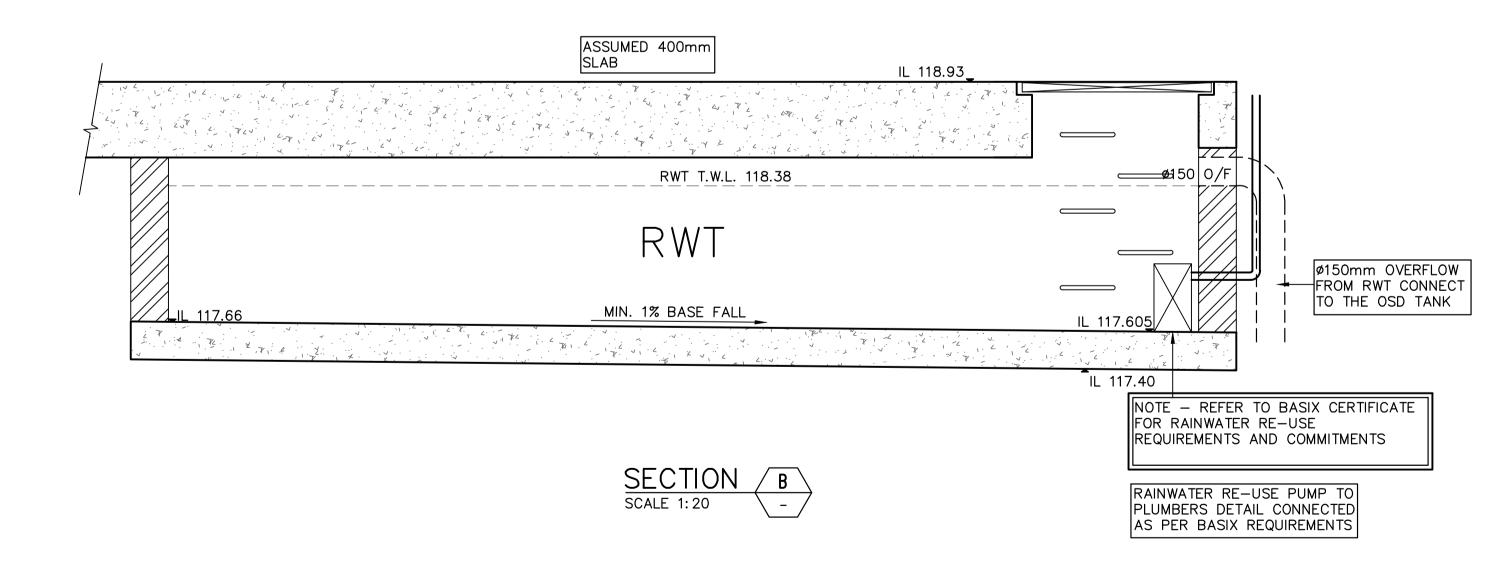

### PROPOSED MIXED USE DEVELOPMENT 58 ANDERSON STREET, CHATSWOOD NSW 2067

Design S.C. Approved P.E. <sup>Scale</sup> 1:100 @ A1 Date 29/10/2024 Drawn S.C.



S 9630 0121 8 Buller Street, North Parramatta, NSW 2151 www.cec-au.com

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G	ISSUED FOR DA APPROVAL
F	ISSUED FOR DA APPROVAL
E	ISSUED FOR DA APPROVAL
D	ISSUED FOR DA APPROVAL
С	ISSUED FOR COORDINATION
В	ISSUED FOR COORDINATION
Rev	Description


# FOR COUNCIL APPROVAL ONLY (CONCEPT)

FOR COUNCIL / CONSTRUCTION CERTIFICATE ISSUE

APPROVED BY:

DATE: 29/10/2024



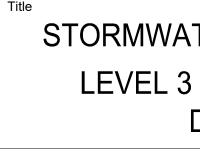

Architect DREW DICKSON ARCHITECTS SUITE 2, GROUND FLOOR/ 183 ALEXANDER STREET CROWS NEST NSW 2065

S.C. M.W. 29/10/2024 S.C. M.W. 10/05/2024 S.C. M.W. 08/03/2024 S.H. M.W. 21/03/2023 S.H. M.W. 20/02/2023 INFO@DDA-AUSTRALIA.COM 02 9061 3433 Z.S. M.W. 20/12/2022 Z.W. M.W. 09/12/2022 DDA-AUSTRALIA.COM

By Chk Date

P.EtB PAUL EL-BAYEH B.E. (Civil), M.E. (Structural & Foundation), FIEAust, CPEng No. 3132148, NER, RPEQ.

KEY NOTES:

INSTALL STEP IRONS FOR EASE OF ACCESS DURING MAINTENANCE OF DETENTION TANK TO COUNCIL SATISFACTION.

INSTALL CONFINED SPACE SIGN ABOVE DETENTION TANK FOR PUBLIC AWARENESS AND WARNING.

ALL STORMWATER PIPES ARE MIN. Ø100mm uPVC AND SLOPING @ 1.0% U.N.O (TYP).

ALL BUILDING AND HYDRAULIC SERVICES TO BE PROPERLY CO-ORDINATED WITH STORMWATER PIPES AND ENSURE NO CLASHES ARE PRESENT DURING CONSTRUCTION (TYP).


STORMWATER PIPE ARRANGEMENT TO BE CO-ORDINTED WITH STRUCTURAL SLAB AND BEAMS WHERE REQUIRED (TYP).


ALL ROOF AREA TO BE COLLECTED BY ALL ROOF AREA TO BE COLLECTED BT RAINWATER OUTLETS AND CONNECTED TO DOWNPIPES. ALL DOWNPIPES TO CONNECT INTO ON-SITE DETENTION SYSTEM. FULL DETAILS OF ROOF DRAINAGE SHALL BE PROVIDED IN CC STAGE



LEGEND: BACKGROUND IS YELLOW TEXT IS WHITE ON BLACK BACKGROUND



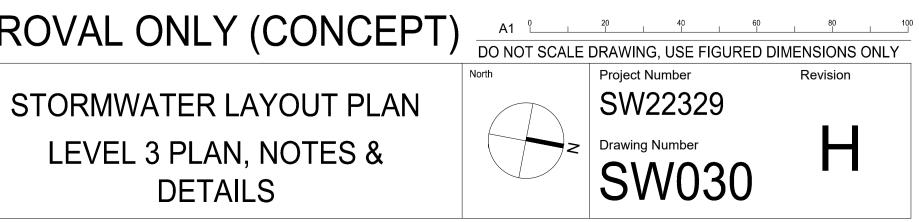

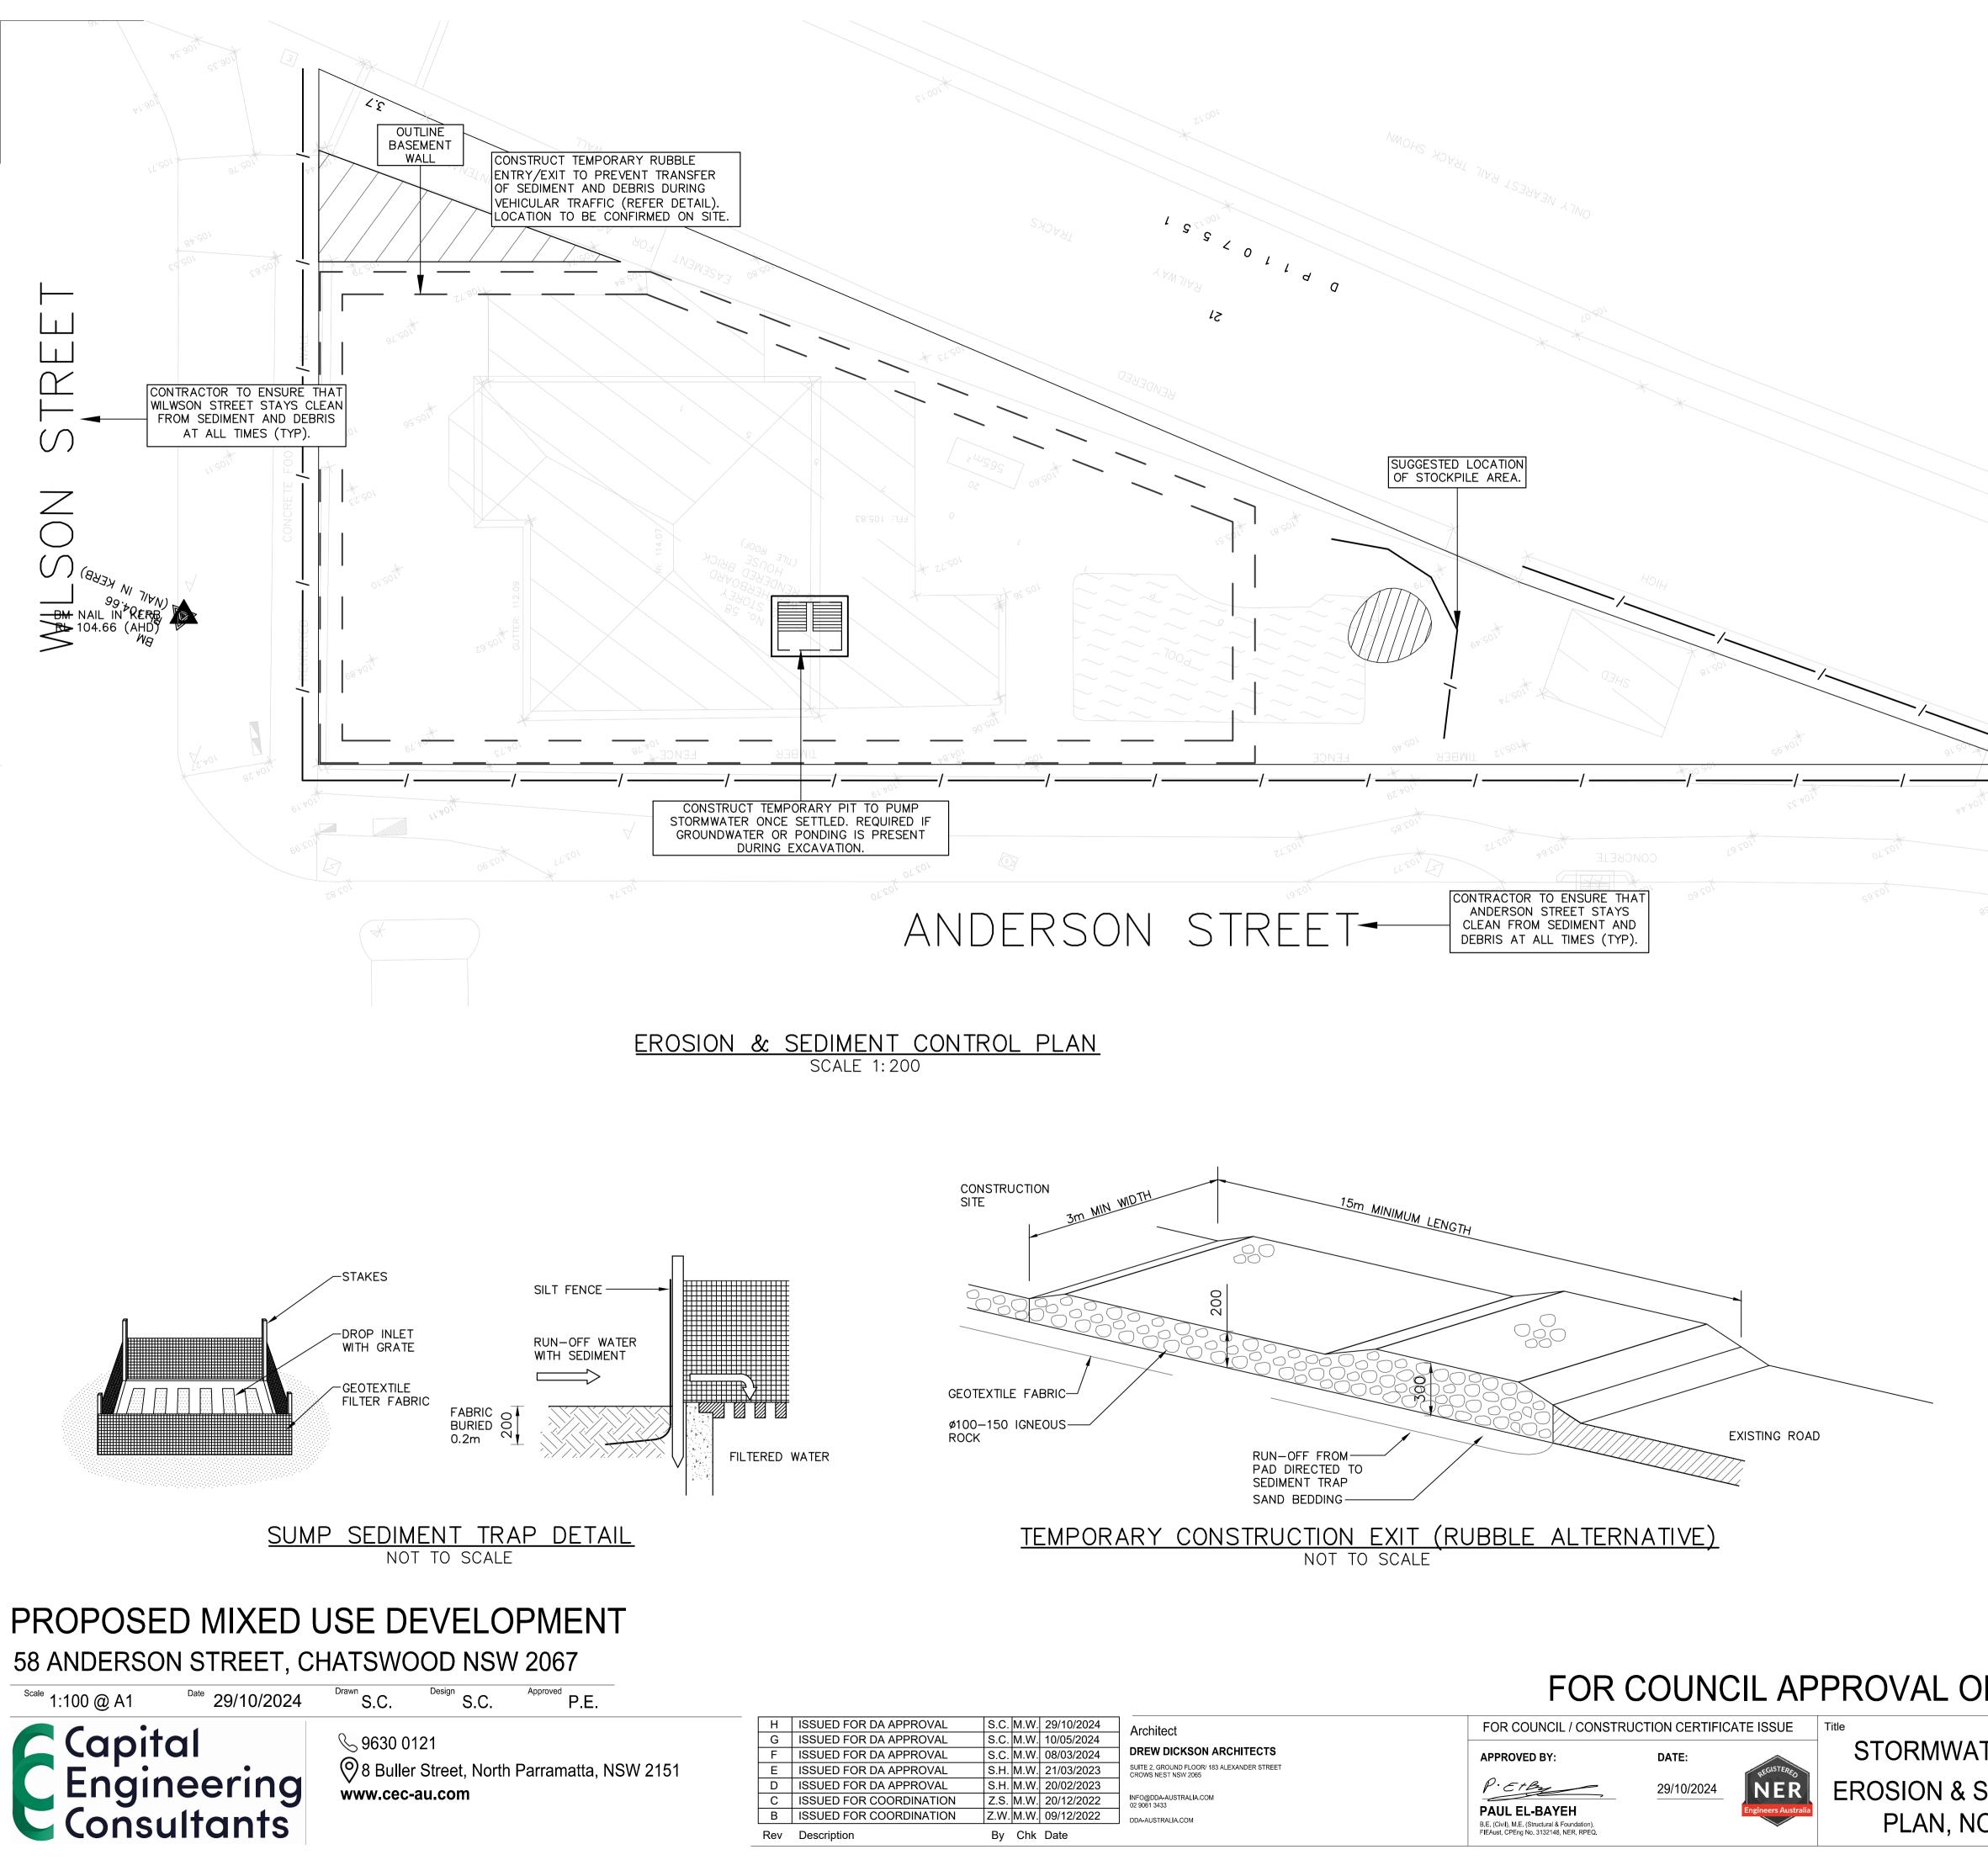

# FOR COUNCIL APPROVAL ONLY (CONCEPT)

### EROSION CONTROL

BEFORE EARTHWORKS CAN COMMENCE THE EROSION & SEDIMENT CONTROL MEASURES MUST BE IN PLACE.

DURING THE CONSTRUCTION PERIOD. THESE CONTROL MEASURES WILL NEED TO BE INSPECTED & MAINTAINED REGULARLY, ESPECIALLY AFTER STORM EVENTS, BY THE CONTRACTOR.

ALL WORK IS TO BE CARRIED OUT TO PREVENT EROSION, CONTAMINATION & SEDIMENTATION OF THE STORAGE SITE, SURROUNDING AREAS & DRAINAGE SYSTEMS.

MINIMIZE DISTURBED AREA COVERED WITH NATURAL VEGETATION. ONLY THOSE AREAS DIRECTLY REQUIRED FOR CONSTRUCTION ARE TO BE DISTURBED.

ISOLATE EXISTING STORMWATER PITS WITH STRAW BALES OR SILT TRAPS TO FILTER ALL INCOMING FLOWS.

DO NOT STOCKPILE EXCAVATED MATERIAL ON THE ROAD WAY.

DIVERT CLEAN WATER FROM UNDISTURBED AREAS AROUND THE WORKING AREAS.

CONSTRUCTION ENTRY/EXIT SHALL BE VIA THE LOCATION NOTED ON THE DRAWING. CONTRACTOR SHALL ENSURE ALL DROPPABLE SOIL & SEDIMENT IS REMOVED PRIOR TO CONSTRUCTION TRAFFIC EXITING SITE. CONTRACTOR SHALL ENSURE ALL CONSTRUCTION TRAFFIC ENTERING AND LEAVING THE SITE DO SO IN A FORWARD DIRECTION.

ADOPT TEMPORARY MEASURES AS MAY BE NECCESSARY FOR EROSION & SEDIMENT CONTROL, INCLUDING BUT NOT LIMITED TO THE FOLLOWING:

- DRAINS: TEMPORARY DRAINS AND CATCH DRAINS. - SPREADER BANKS OR OTHER STRUCTURES: TO DISPERSE


CONCENTRATED RUNOFF. - SILT TRAPS: CONSTRUCTION AND MAINTENANCE OF SILT TRAPS TO PREVENT DISCHARGE OF SCOURED MATERIAL TO DOWNSTREAM AREAS.

AFTER RAIN, INSPECT, CLEAN, AND REPAIR IF REQUIRED, TEMPORARY EROSION & SEDIMENT CONTROL MEASURES.


REMOVE TEMPORARY EROSION & SEDIMENT CONTROL MEASURES WHEN THEY ARE NO LONGER REQUIRED.

COMPLY WITH THE REQUIREMENTS OF LANDCOM'S MANAGING URBAN STORMWATER - SOIL AND CONSTRUCTION 'THE BLUE BOOK' LATEST EDITION

THE EROSION & SEDIMENT CONTROL PLAN PROVIDED IS ONLY INDICATIVE. THE CONTRACTOR SHOULD PREPARE A DETAILED ESCP SUITABLE FOR THE SPECIFIC SITE CONDITIONS

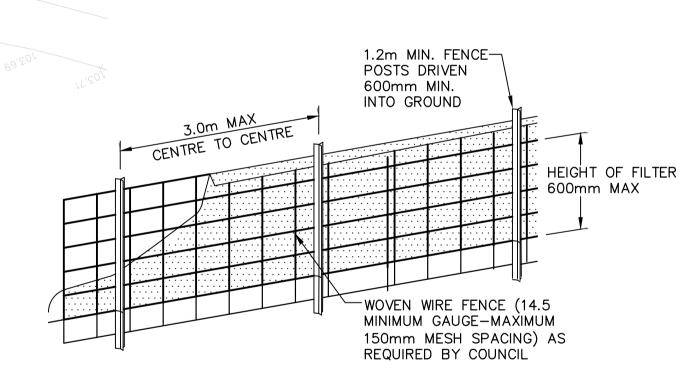

DIAGRAMMATIC VIEW

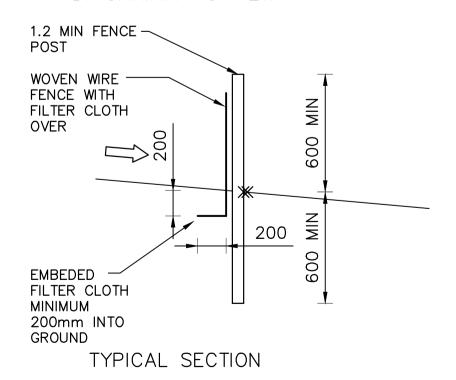



DO NOT SCALE DRAWING, USE FIGURED DIMENSIONS ONLY Project Number Revision STORMWATER LAYOUT PLAN SW22329 Η **EROSION & SEDIMENT CONTROL Drawing Number** ER001 PLAN, NOTES & DETAILS